



工程指示 / 要求簡箋(E.I.)

工程指示編號：EI / 1722 / 20

修改版次：-

工程編號

: J851

工程名稱：青衣明翹匯住宅

工程項目

: 鋁飾綫 CAD 電腦圖

收件人

: 生統

發件人

: Leung Hin Wai

日期

: 23/4-2020

要求提供 / 確認 事項：

- | | | |
|------------------------------------|-------------------------------------|-------------------------------|
| <input type="checkbox"/> 初步鋁料 B.M. | <input type="checkbox"/> 加工拆圖，然後生產 | <input type="checkbox"/> 尺寸表 |
| <input type="checkbox"/> 正式鋁料 B.M. | <input type="checkbox"/> 技術上資料 / 指示 | <input type="checkbox"/> 報價 |
| <input type="checkbox"/> 配件 B.M. | <input type="checkbox"/> 樣辦或貨品說明書 | <input type="checkbox"/> 分判合約 |
| <input type="checkbox"/> 其他：_____ | | |

內容：

請查收 鋁飾綫 CAD 電腦圖。

請在 _____ 前完成上列要求。

附：-

以上項目為：

- 原合約工程包 原合約工程加 / 減賬 新工程報價

原因：-

分發東莞各部門：

- () 生產技術總監 連附件 () 技術部 連附件 () 生產部 連附件 () 機械設計部 連附件
 () 採購部 連附件 (/) 生產統籌部 連附件
 (/) 質檢部 連附件 () 會計部 連附件 () 報關組 連附件 () 其他 _____ 連附件

分發香港各部門：

- () 行政部 連附件 () 會計部 連附件 () 統籌部 連附件 () 工程部地盤科文(柄) 連附件
 () 採購部 連附件 () QS 部 連附件 () 維修部 連附件 () 其他 _____ 連附件

傳遞編號：

HK0660

發件人簽署：

Handwritten signature

項目經理簽署：

Handwritten signature

PROJECT :

**RESIDENTIAL DEVELOPMENT AT
TSING YI TOWN LOT 190
SAI SHAN ROAD**

②

**SHOP DRAWING OF ALUM. CLADDING, FEATURE & FINS
(TOWER 1 / 1A AND TOWER 2 / 2A)
DATE : 17 - April - 2020**

 **美特鋁質有限公司**
MIDI ALUMINIUM FABRICATOR LTD.

Units 6-8, Sunray Industrial Centre, 1/F
610 Cha Kwo Ling Road, Kowloon
Tel:23489211-4 Fax:(852)27727666

DWG. NO. : BD-AFC-000

REV. : -

FILE NAME:

GENERAL NOTES:

1. DESIGN CODES AND REFERENCE :

- 1.1. HONG KONG BUILDING (CONSTRUCTION) REGULATIONS 1990.
- 1.2. CODE OF PRACTICE ON WIND EFFECTS IN HONG KONG 2304.
- 1.3. CODE OF PRACTICE FOR THE STRUCTURAL USE OF STEEL 2011.
- 1.4. CODE OF PRACTICE FOR STRUCTURAL USE OF CONCRETE 2004.
- 1.5. BS8118 -- THE STRUCTURAL USE OF ALUMINIUM, PART 1 - 1991.
- 1.6. PRACTICE NOTE FOR AUTHORIZED PERSONS REGISTERED STRUCTURAL ENGINEERS AND REGISTERED GEOTECHNICAL ENGINEERS (PNAP APP-16).

2. MATERIAL:

- 2.1. DISSIMILAR METAL CONTACT SURFACE SHOULD BE PAINTED WITH BITUMEN PAINT OR ISOLATED WITH PLASTIC SHEET TO PREVENT CORROSION.
- 2.2. STRUCTURAL STEEL SECTION:
ALL STRUCTURAL STEEL SECTION TO BE GRADE S275JO CLASS 1 AND COMPLY WITH BS EN 10210 FOR HOLLOW SECTION AND BS EN 10025 FOR SECTIONS OTHER THAN HOLLOW.
DESIGN STRENGTH FOR GRADE S275 STEEL :
MINIMUM YIELD STRENGTH, $f_y = 275 \text{ N/mm}^2$
MINIMUM ULTIMATE TENSILE STRENGTH, $f_u = 430 \text{ N/mm}^2$
YOUNG'S MODULUS OF STEEL, $E = 205 \text{ kN/mm}^2$
ALL STRUCTURAL STEEL SHOULD BE APPLIED HOT-DIP GALVANIZED WITH 85 μm THICKNESS TO B.S. EN ISO 1461 : 2009 FOR CORROSION PROTECTION.

2.3. STAINLESS STEEL:


- SCREW, CONNECTION BOLT AND NUT GRADE A4-70 (TO BS EN ISO 3506 PART 1 & 2 : 1998)
- 0.2% PROOF STRENGTH, $f_{0.2p} = 450 \text{ N/mm}^2$
ULTIMATE TENSILE STRENGTH, $f_{ts} = 700 \text{ N/mm}^2$
DESIGN TENSILE STRENGTH, $f_p = 360 \text{ N/mm}^2$
DESIGN SHEAR STRENGTH, $f_q = 311 \text{ N/mm}^2$

2.4. WELDING

2.4.1. STRUCTURAL STEEL

- 1) MATERIAL
ALL WELD MATERIAL FOR CONNECTION BETWEEN STRUCTURAL STEEL SHALL COMPLY WITH BS EN ISO 2560 : 2005.
- 2) WORKMANSHIP
ALL STRUCTURAL STEEL WELDING SHALL COMPLY WITH BS EN 1011-1 : 1998.
FOR ALL WELDING ON SITE, FLUX RESIDUE AND SLAG SHOULD BE REMOVED AND PROTECTED WITH 2 COATS OF ZINC RICH PAINT TO B.S. 4852 : 1995.
DESIGN STRENGTH FOR STRUCTURAL STEEL WELDING = 220 MPa.
- 3) ALL WELDING OF STRUCTURAL STEEL FRAME TO BE 4mm FILLET WELDING ON TWO SIDES, MINIMUM LENGTH = 40mm AT EACH SIDE, UNLESS OTHERWISE STATED.

2.4.2. WELDING LEGEND

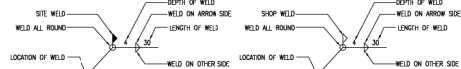

- 2.4.3. ALL WELDING TO BE PERFORMED BY QUALIFIED WELDERS TO BS EN 287 - PART 1 : 2004.

3.0 ALUMINIUM WORK

- 3.1 ALL ALUMINIUM EXTRUSION SHALL COMPLY WITH BS 8118 : PART 1 1991 & BS EN 755 -- 1,2008 & BS EN 573-3,2009

- MODULUS OF ELASTICITY
 $E = 70000 \text{ MPa}$
- a. FOR GRADE 6063-T5
LIMITING BENDING STRESS $P_b = 110 \text{ MPa}$
LIMITING TENSILE STRESS $P_t = 130 \text{ MPa}$
LIMITING SHEAR STRESS $P_v = 65 \text{ MPa}$
- b. FOR GRADE 6063-T6
LIMITING BENDING STRESS $P_b = 160 \text{ MPa}$
LIMITING TENSILE STRESS $P_t = 175 \text{ MPa}$
LIMITING SHEAR STRESS $P_v = 95 \text{ MPa}$

- 3.2 ALL ALUMINIUM CLADDING BE GRADE 3003-H14 AND 3 MM THICKNESS TO BS EN 185, PART 2,2008 & BS EN 573-3, 2009

- 0.2% TENSILE PROOF STRENGTH $P_b = 125 \text{ MPa}$
ULTIMATE TENSILE STRENGTH $P_t = 145 \text{ MPa}$
SHEAR STRENGTH $P_v = 15 \text{ MPa}$
MODULUS OF ELASTICITY $E = 70000 \text{ MPa}$

3.3 ALUMINIUM WELD STUD

- ALUMINIUM WELD STUD SHALL BE GRADE 6082-16 TO BS EN ISO 13918:2008.
AND WELDING SHALL BE COMPLIED WITH BS EN 1011-4:2000.
- 0.2% TENSILE PROOF STRENGTH $P_b = 80 \text{ MPa}$
ULTIMATE TENSILE STRENGTH $P_t = 80 \text{ MPa}$
LIMITING STRESS OF WELDING $P_v = 160 \text{ MPa}$

- 3.4 ALLOWABLE DEFLECTION OF ALL STRUCTURAL MEMBER TO BE L/180 OR 20mm WHICHEVER IS LESSER


4. DESIGN WIND PRESSURE (Sa=1.0)

- BASIC WIND PRESSURE : 2.96 kPa (HEIGHT =0-125m)
WIND FORCE COEFFICIENT : -1.4/+1.0 (ELEVATION) -2.0 (UPWARD/DOWNWARD)
DESIGN WIND PRESSURE : -4.9/+3.5 kPa(ELEVATION) $\pm 5.92 \text{ kPa}$ (UPWARD/DOWNWARD)

5. ANCHOR BOLTS (ANCHOR BOLT SHALL BE INSTALLED IN ACCORDANCE TO THE BOLT MANUFACTURER'S SPECIFICAT

5.1 DESIGN DATA (STAINLESS STEEL TYPE/CRACKED CONCRETE)

Anchor model NO:	HLB HS13-R M8	HLB HS13-R M10
Minimum Embedment Length (from sound concrete surface)	47 mm	60 mm
Recommended Pull Out	3.33 kN	6.0 kN
Recommended Shear	6.22 kN	10.0 kN
Minimum Edge Distance	40 mm	45 mm
Minimum Spacing Between Bolts	35 mm	40 mm
Tested Pull Out (Recommended Pull Out x1.3)	5.0 kN	9.0 kN
Drill Hole Depth	59 mm	73 mm
Concrete grade	C30/35	C35/40
Concrete grade	1.19	
BO No.:	BO-A-130	BO-A-127

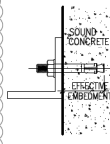


- 5.2 TO USE COVER METER TO CHECK REBAR PRIOR TO THE INSTALLATION OF ANCHOR AND TO AVOID CLASHING WITH EXISTING REINFORCEMENT

6. REINFORCED CONCRETE (FOR INFORMATION ONLY)

- 6.1. THE CONCRETE USED FOR STRUCTURAL MEMBERS IS OF GRADE 45D, AND USE GRADE 30D FOR STONE CLADDING FIXING DESIGN
- 6.2. THE MINIMUM THICKNESS OF SUPPORT R.C. WALL SHALL BE 125mm THICK.
7. ALLOW MAX. $\pm 25\text{mm}$ SPACING TOLERANCE BETWEEN GRANITE FACE AND CONCRETE SURFACE.
8. THIS ALUM. CLADDING SUBMISSION DRAWING IS ACCORDING TO GBP APPROVED ON. 11/04/2014 (REV.D)

9. TYPICAL CLADDING DESIGN DETAILS

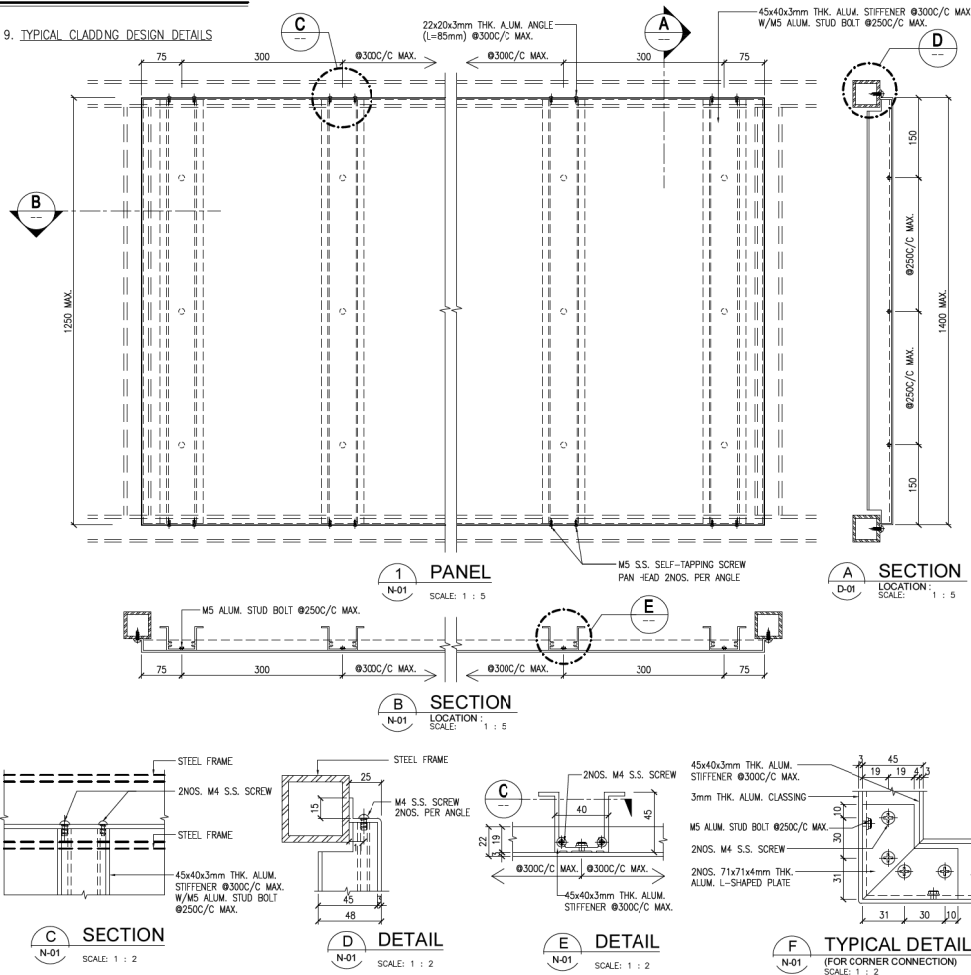

F.S.D. REF :

Note :

1. All dimensions are in mm.
2. All elevations are viewed from outside
3. All dimensions to be verified on site before fabrication.

GENERAL NOTES

Legend :

1. F.F.L.-- Finished Floor Level
2. S.F.L.-- Structural Floor Level
3. (R) -- Reversed Detail
4. MR. -- Minor

X1 -- DETAIL MARK NO.
X001 -- REFER SHEET NO.

A	05/03/2020	GENERAL REVISION	
NO.	DATE	REVISED	BY

CLIENT :

住明集團控股有限公司
GRAND MING GROUP HOLDINGS LIMITED

MAIN CONTRACTOR :

GRAND TECH CONSTRUCTION CO. LTD.

ARCHITECT :

WONG TUNG & PARTNERS LIMITED
ARCHITECTS & PLANNERS



STRUCTURAL ENGINEER :

C M WONG & ASSOCIATES LTD

美特鋁質有限公司
MIDI ALUMINIUM FABRICATOR LTD.

Units 6-8, Sunray Industrial Centre, 1/F
610 Cha Kwo Ling Road, Kowloon
Tel:23489211-4 Fax:(852)27727666

PROJECT :

RESIDENTIAL DEVELOPMENT AT
TSING YI TOWN LOT 190 SAI SHAN ROAD

TITLE :

GENERAL NOTES
(ALUM. CLADDING FEATURE) (1)

JOB NO. : J851

DRAWN BY : DL DATE : 18-11-2019

CHKD BY : SCALE AT: N.T.S

DWG. NO. : J851-GN-01_01 REV. : A

10. MEMBER SCHECLWLE
10.1 ALUM. EXTRUSION

MEMBER MARK: AL1(1)	MEMBER MARK: AL1(2)	MEMBER MARK: AL2(1)	MEMBER MARK: AL2(2)
MATERIAL: ALLOY 6063-T5	MATERIAL: ALLOY 6063-T5	MATERIAL: ALLOY 6063-T5	MATERIAL: ALLOY 6063-T5
AREA=1437.00mm ²	AREA=6080.00mm ²	AREA=2542.00mm ²	AREA=5665.00mm ²
I _x =2234233mm ⁴ I _y =3051072mm ⁴	I _x =31403622mm ⁴ I _y =31607436mm ⁴	I _x =7107439mm ⁴ I _y =18680729mm ⁴	I _x =31663828mm ⁴ I _y =39221309mm ⁴
Z _x =42966mm ³ Z _y =42376mm ³	Z _x =270721mm ³ Z _y =274874mm ³	Z _x =84612mm ³ Z _y =133434mm ³	Z _x =282713mm ³ Z _y =297131mm ³
MEMBER MARK: AL3	MEMBER MARK: AL6	MEMBER MARK: AL6(1)	MEMBER MARK: AL6(2)
MATERIAL: ALLOY 6063-T5	MATERIAL: ALLOY 6063-T5	MATERIAL: ALLOY 6063-T5	MATERIAL: ALLOY 6063-T5
AREA=4440.00mm ²	AREA=1394.00mm ²	AREA=1154.80mm ²	AREA=1565.10mm ²
I _x =11024992mm ⁴ I _y =33750275mm ⁴	I _x =1077300mm ⁴ I _y =5170477mm ⁴	I _x =1025338mm ⁴ I _y =4498337mm ⁴	I _x =120384mm ⁴ I _y =6460012mm ⁴
Z _x =113660mm ³ Z _y =210939mm ³	Z _x =25053mm ³ Z _y =56201mm ³	Z _x =16809mm ³ Z _y =52922mm ³	Z _x =16809mm ³ Z _y =52922mm ³
MEMBER MARK:STIFFENER			
MATERIAL: ALLOY 6063-T5			
AREA=487.00mm ²			
I _x =127008mm ⁴ I _y =160586mm ⁴			
Z _x =5080mm ³ Z _y =5018mm ³			

10.2 GMS SECTION

SECTION	MATERIAL
1_ANGLE	S275JO
40x40x5mm GMS ANGLE	
50x50x5/6mm GMS ANGLE	
75x75x6mm GMS ANGLE	
80x80x8mm GMS ANGLE	
90x90x6mm GMS ANGLE	S275JOH
2_PLATE	
5/6/8/10mm THK.	
3_CHANNEL	
102x51 GMS CHANNEL	
4_SHS/RHS	S275JOH
40x40x5mm GMS SHS	
50x50x5mm GMS SHS	
75x75x5mm GMS SHS	
40x80x5mm GMS RHS	
50x100x5mm GMS RHS	

F.S.D. REF :

- Note ;
1. All dimensions are in mm.
2. All elevations are viewed from outside.
3. All dimensions to be verified on site before fabrication.

GENERAL NOTES

Legend :

1. F.F.L--- Finished Floor Level
2. S.F.L--- Structural Floor Level
3. (Symbol) --- Reversed Detail
4. MR --- Mirror



NO.	DATE	GENERAL REVISION	BY
A	05/31/2020	GENERAL REVISION	

CLIENT
佳明集團控股有限公司
GRAND MING GROUP HOLDINGS LIMITED

MAIN CONTRACTOR :
GRAND TECH CONSTRUCTION CO. LTD.

ARCHITECT :
WONG TUNG & PARTNERS LIMITED
ARCHITECTS & PLANNERS

STRUCTURAL ENGINEER :
C M WONG & ASSOCIATES LTD

美特鋁質有限公司
MIDI ALUMINIUM FABRICATOR LTD.
Units 6-8, Sunny Industrial Centre, 1/F
610 Cha Kwo Ling Road, Kowloon
Tel:23489211-4 Fax:(852)27727666

PROJECT :
RESIDENTIAL DEVELOPMENT AT
TSING YI TOWN LOT 190 SAI SHAN ROAD


TITLE :
GENERAL NOTES
(ALUM. CLADDING FEATURE) (2)

JOB NO : J851


DRAWN BY : DL DATE : 18-11-2019

CHKD BY : SCALE A1: N.T.S.

DWG. NO. : J851-GN-01_01a REV. : A

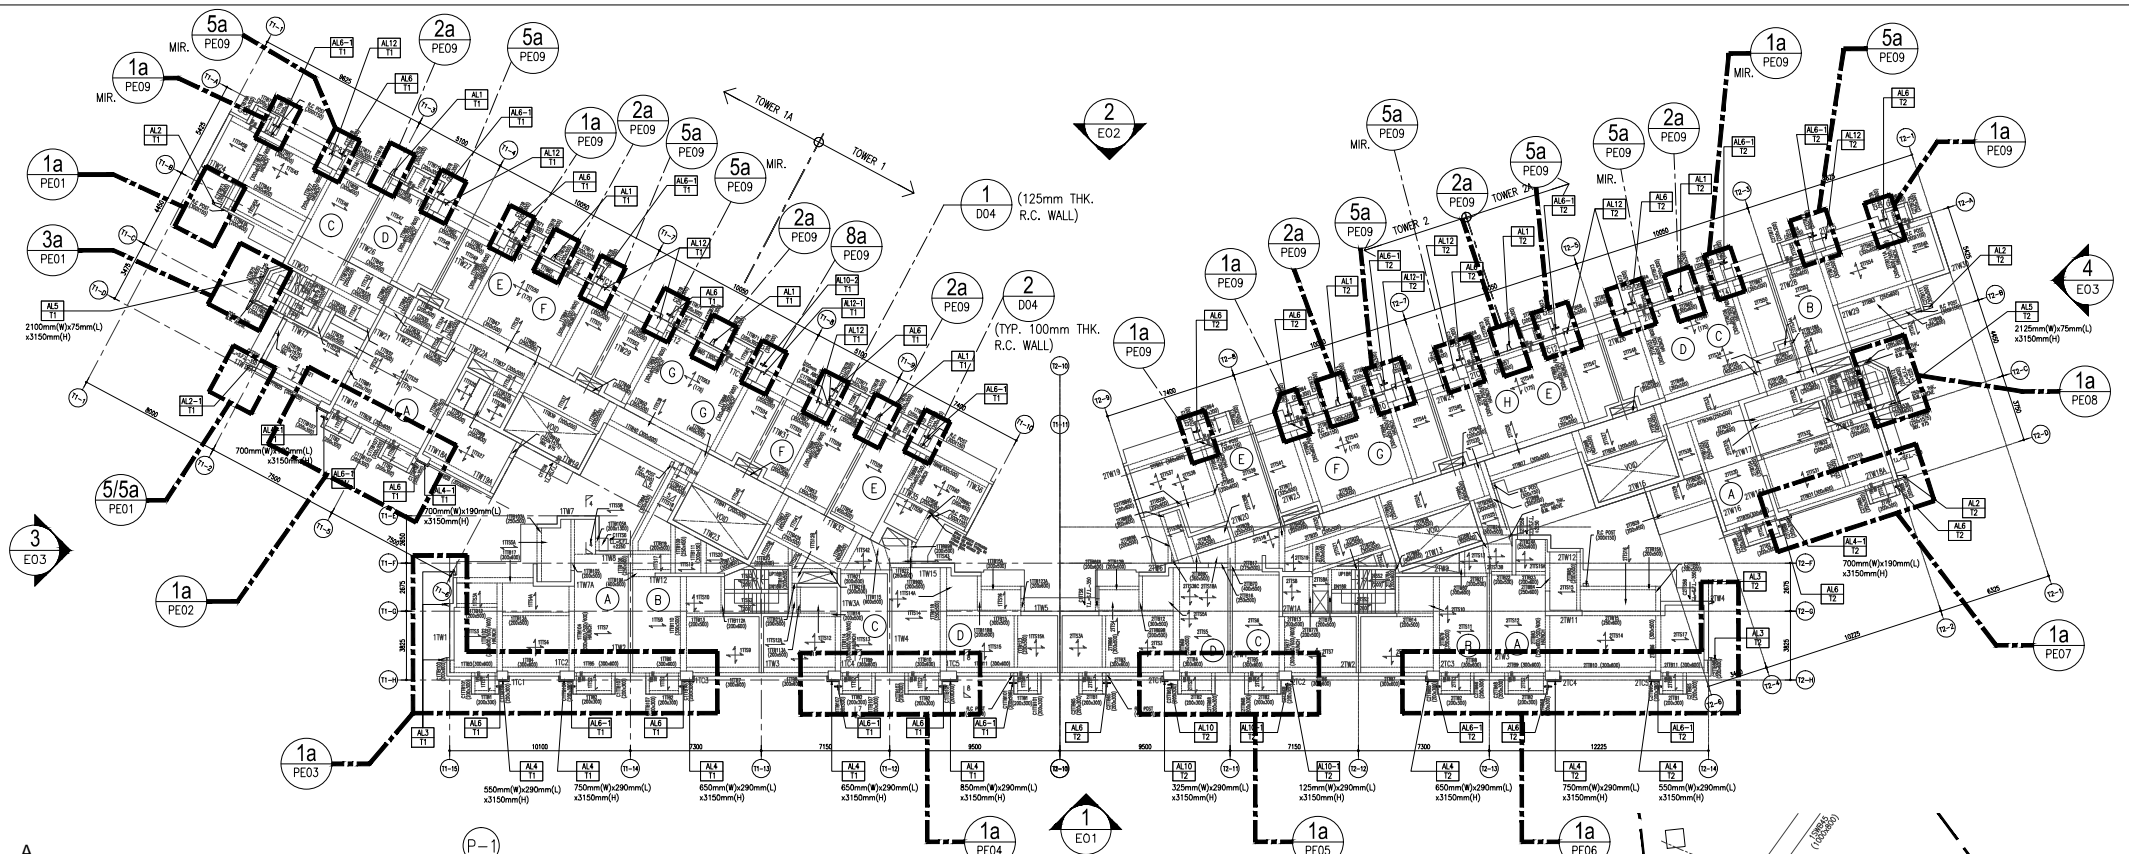

2 ALUMINIUM CLADDING LOCATION PLAN AT 2/F-32/F
 LOCATION: FOR TOWER 1/1A & 2/2A
 SCALE: 1 : 200

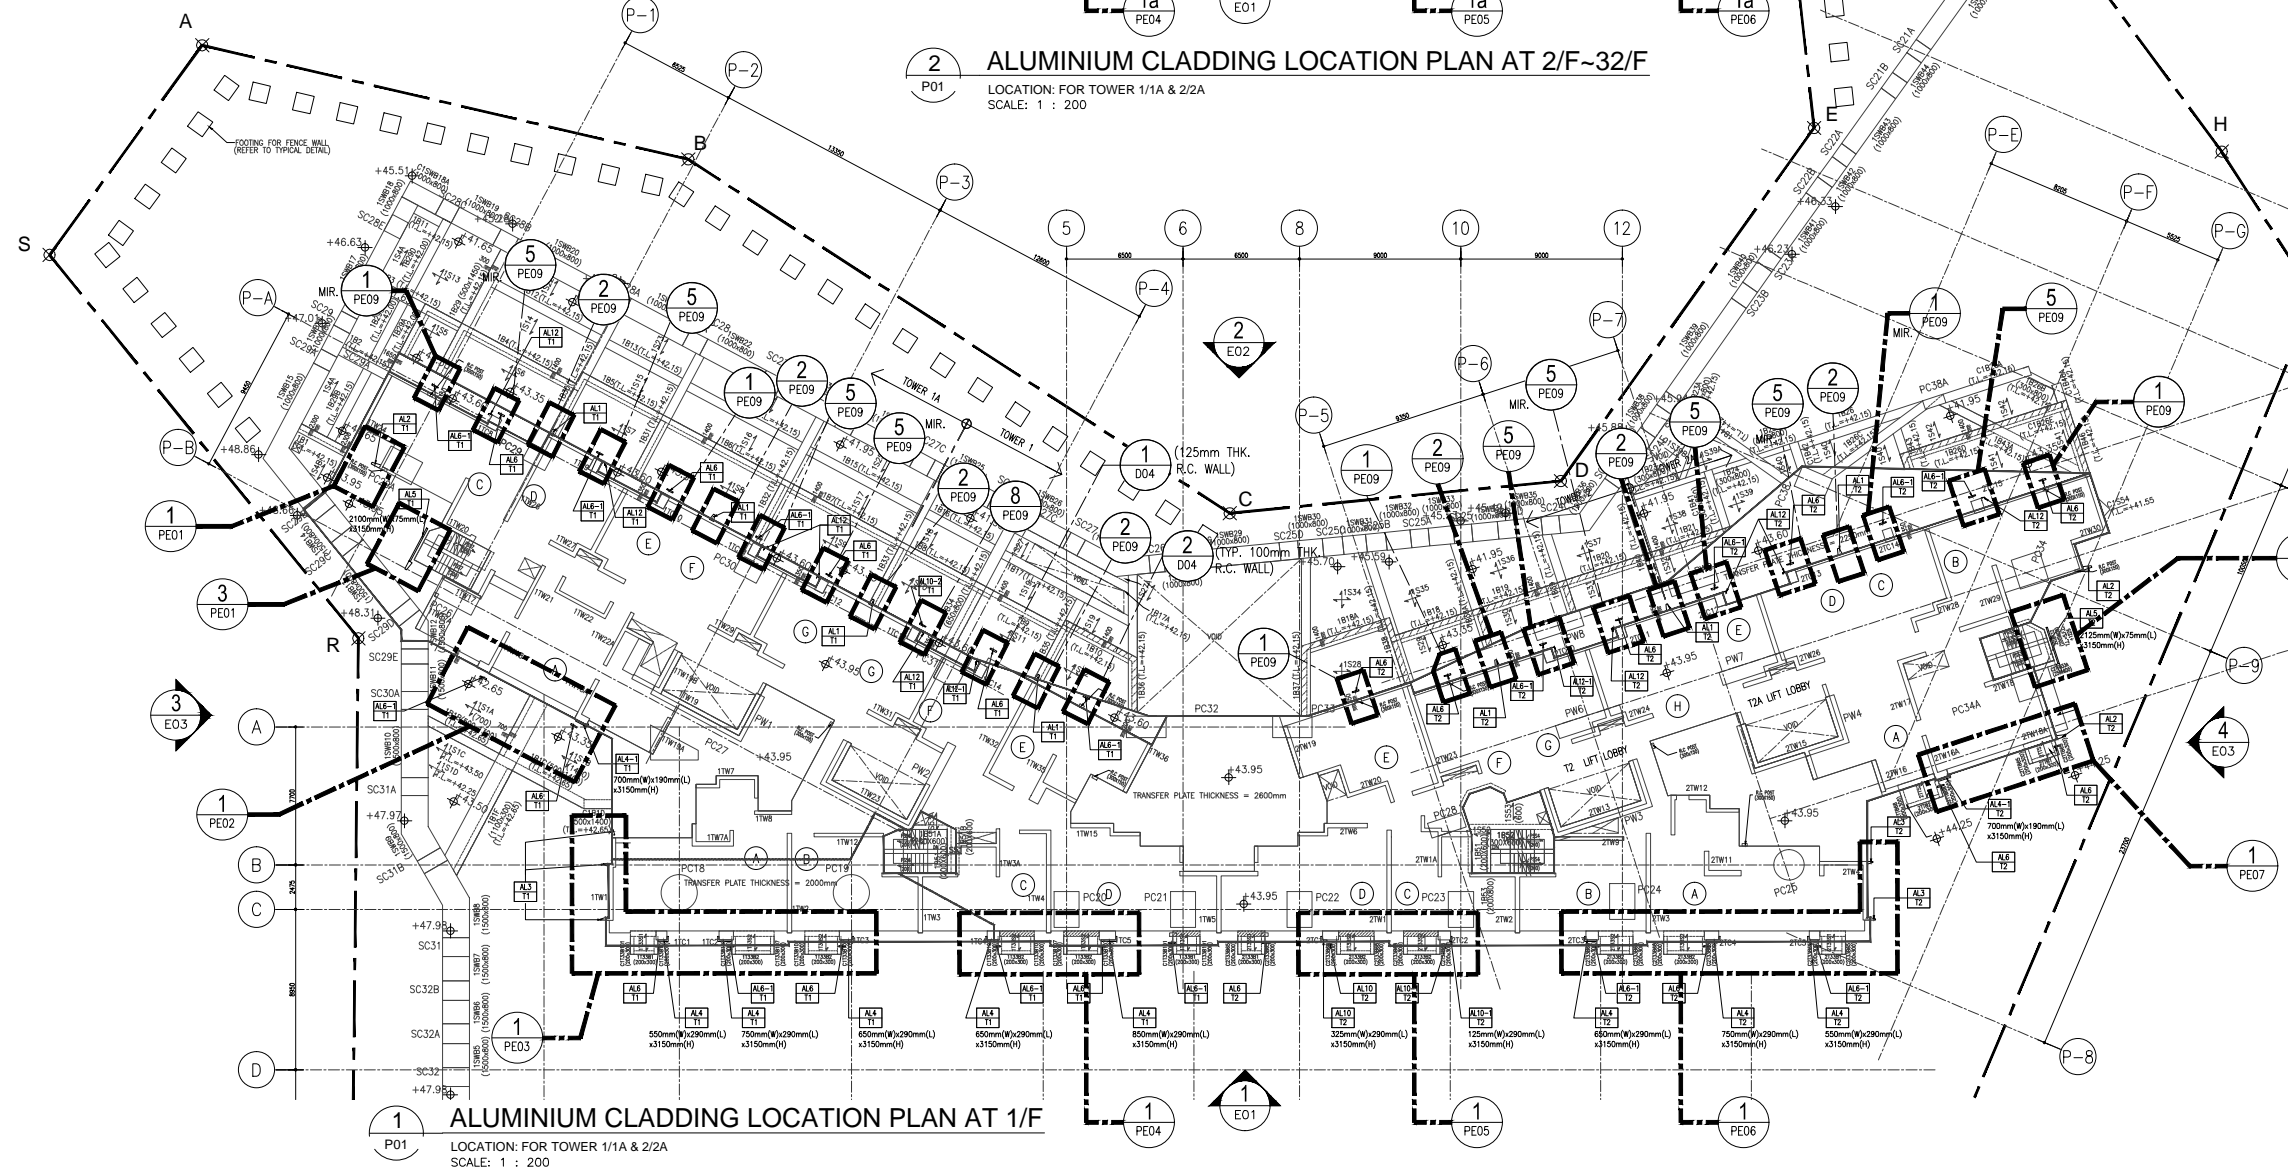

1 ALUMINIUM CLADDING LOCATION PLAN AT 1/F
 LOCATION: FOR TOWER 1/1A & 2/2A
 SCALE: 1 : 200

F.S.D. REF :
 Note :
 1. All dimensions are in mm.
 2. All elevations are viewed from outside.
 3. All dimensions to be verified on site before fabrication.

GENERAL NOTES

Legend :

1. F.F.L.-- Finished Floor Level
 2. S.F.L.-- Structural Floor Level
 3. (R) -- Reversed Detail
 4. MIR. -- Mirror

X1 -- DETAIL MARK NO.
 X001 -- REFER SHEET NO.

STRUCTURAL & FINISH FLOOR LEVEL FOR T1, T2, 1/F-32/F (LOW, HIGH ZONE) (4TH, 13TH, 14TH, 24TH FLOOR OMITTED)


FLOOR	S.F.L.	F.F.L.
1/F	+ 44.45	+ 44.50
2/F	+ 47.60	+ 47.65
3/F	+ 50.75	+ 50.80
5/F	+ 53.90	+ 53.95
6/F	+ 57.05	+ 57.10
7/F	+ 60.20	+ 60.25
8/F	+ 63.35	+ 63.40
9/F	+ 66.50	+ 66.55
10/F	+ 69.65	+ 69.70
11/F	+ 72.80	+ 72.85
12/F	+ 75.95	+ 76.00
15/F	+ 79.10	+ 79.15
16/F	+ 82.25	+ 82.30
17/F	+ 85.40	+ 85.45
18/F	+ 88.55	+ 88.60
19/F	+ 91.70	+ 91.75
20/F	+ 94.85	+ 94.90
21/F	+ 98.00	+ 98.05
22/F	+ 101.15	+ 101.20
23/F	+ 104.30	+ 104.35
25/F	+ 107.45	+ 107.50
26/F	+ 110.60	+ 110.65
27/F	+ 113.75	+ 113.80
28/F	+ 116.90	+ 116.95
29/F	+ 120.05	+ 120.10
30/F	+ 123.20	+ 123.25
31/F	+ 126.35	+ 126.40
32/F	+ 129.50	+ 129.55


A	14/04/2020	GENERAL REVISED	
NO.	DATE	REVISED	BY

CLIENT :
佳明集團控股有限公司
 GRAND MING GROUP HOLDINGS LIMITED

MAIN CONTRACTOR :
GRAND TECH CONSTRUCTION CO. LTD.

ARCHITECT :
WONG TUNG PARTNERS LIMITED
 ARCHITECTS & PLANNERS




STRUCTURAL ENGINEER :
 **C M WONG & ASSOCIATES LTD**

美特鋁質有限公司
MIDI ALUMINIUM FABRICATOR LTD.
 Units 6-8, Sunray Industrial Centre, 1/F
 610 Cha Kwo Ling Road, Kowloon
 Tel: 23489211-4 Fax: (852) 27727666


PROJECT :
RESIDENTIAL DEVELOPMENT AT TSING YI TOWN LOT 190 SAI SHAN ROAD

TITLE :
LOCATION KEY PLAN OF ALUM. CLADDING AT 1/F-32/F FOR T1/1A & T2/2A

JOB NO. :	J851
DRAWN BY : DL	DATE : 18-11-2019
CHKD BY :	SCALE A1: 1 : 200
DWG. NO. : J851-ACF-P01	REV. : A

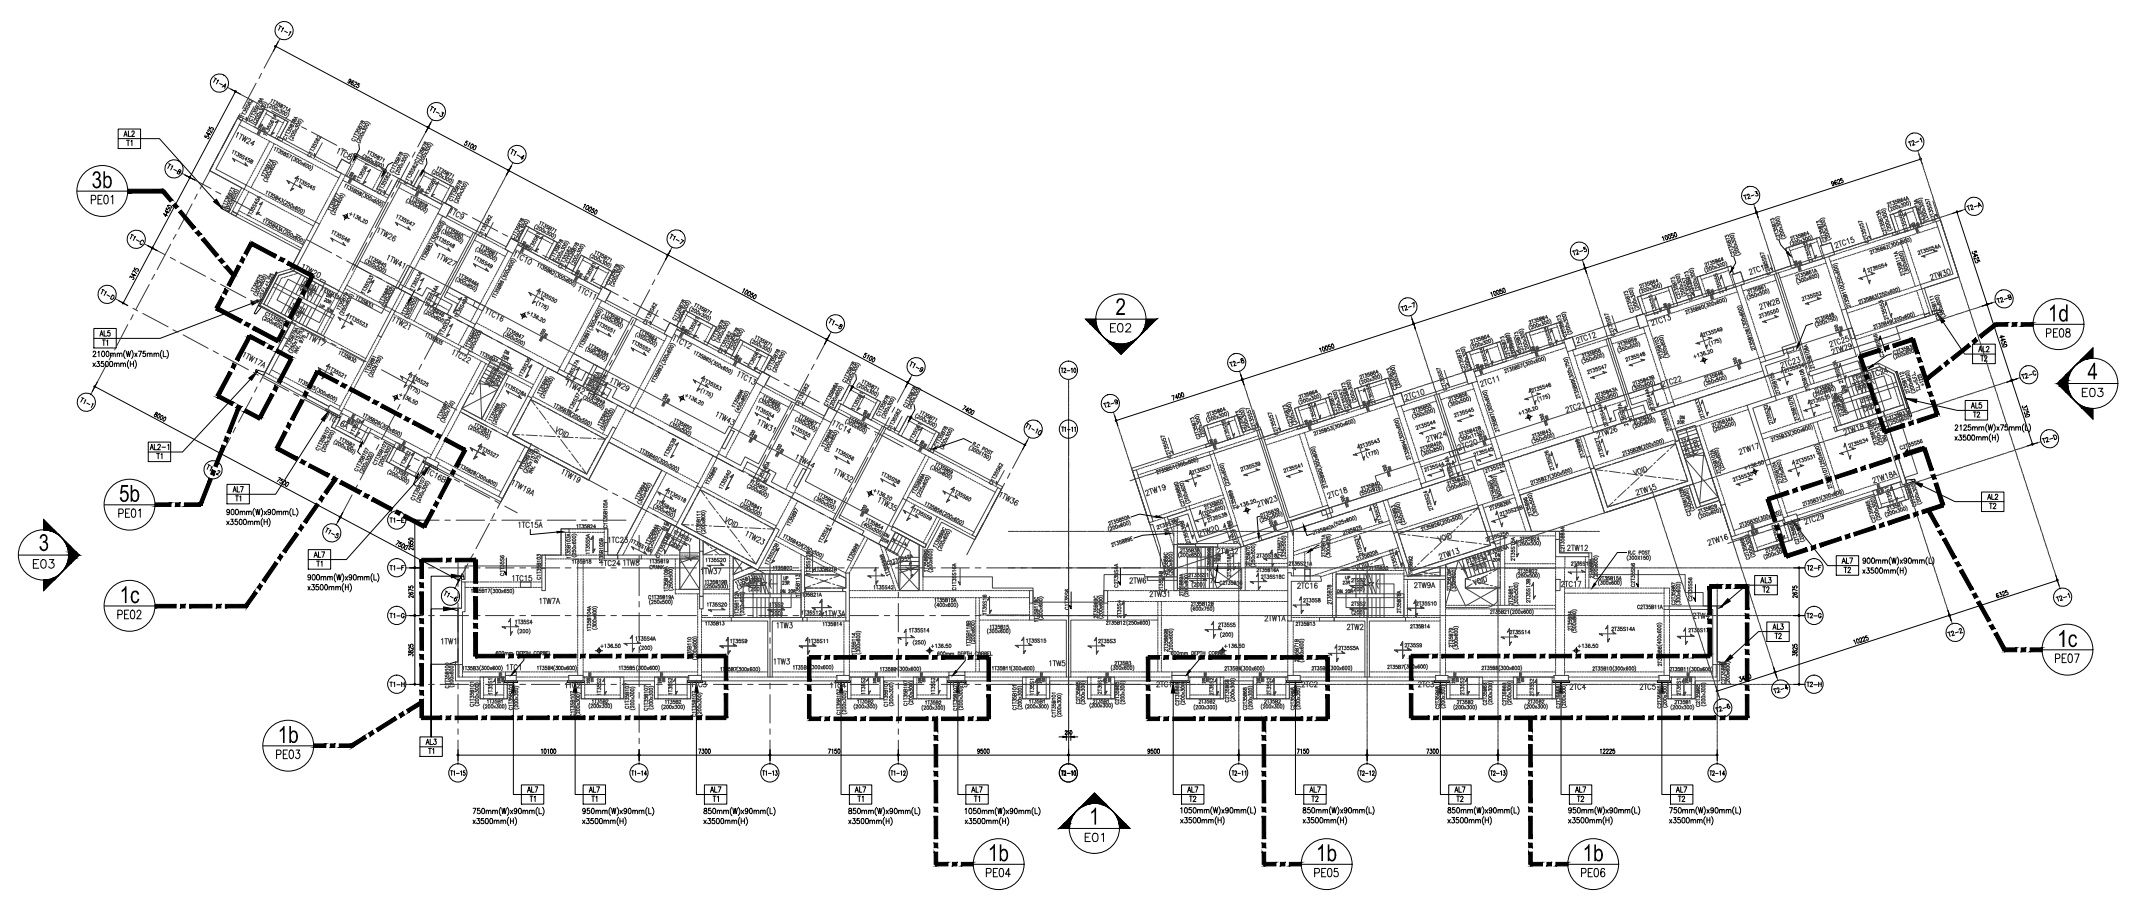

2 ALUMINIUM CLADDING LOCATION PLAN AT 35/F
 LOCATION: FOR TOWER T1/1A & T2/2A
 SCALE: 1 : 200

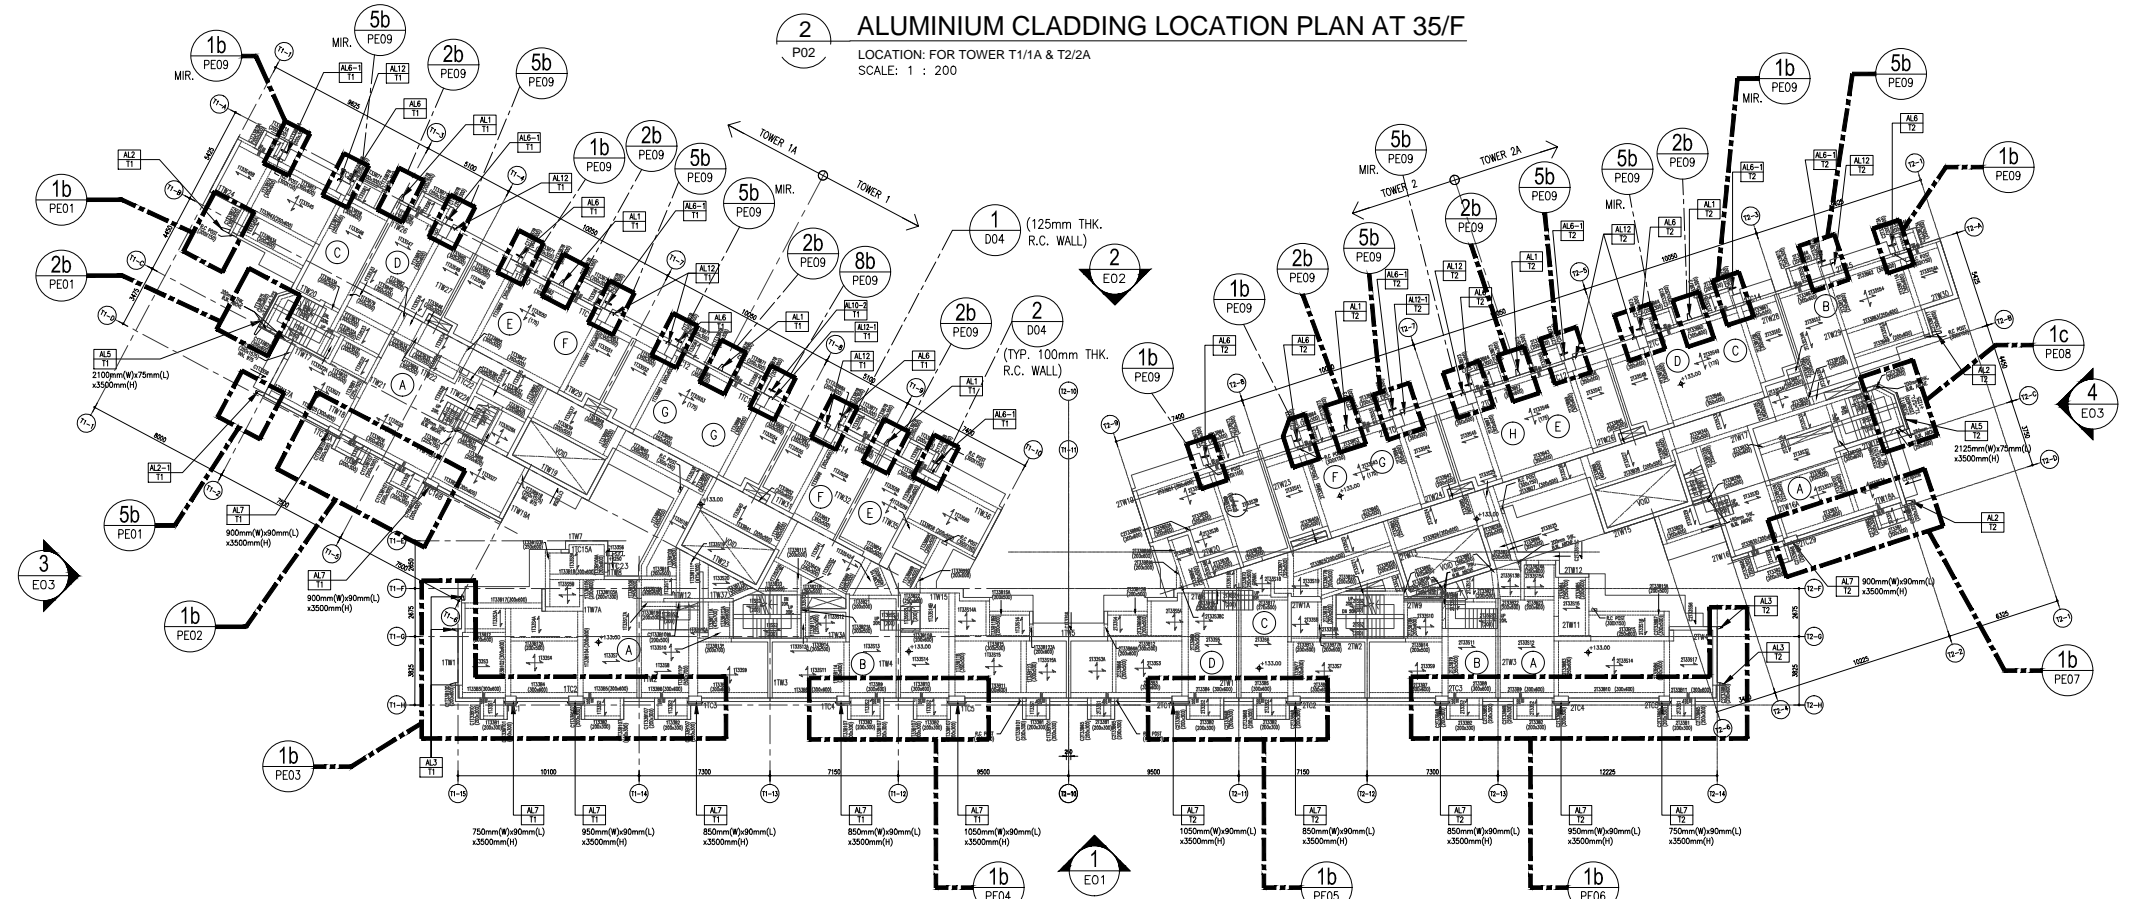

1 ALUMINIUM CLADDING LOCATION PLAN AT 33/F
 LOCATION: FOR TOWER T1/1A & T2/2A
 SCALE: 1 : 200

F.S.D. REF :
 Note :
 1. All dimensions are in mm.
 2. All elevations are viewed from outside.
 3. All dimensions to be verified on site before fabrication.

GENERAL NOTES

Legend :

1. F.F.L.-- Finished Floor Level
 2. S.F.L.-- Structural Floor Level
 3. (R) -- Reversed Detail
 4. MIR. -- Mirror

X1 -- DETAIL MARK NO.
 X001 -- REFER SHEET NO.

STRUCTURAL & FINISH FLOOR LEVEL FOR T1, T2, 33/F~35/F (HIGH ZONE) (34TH FLOOR OMITTED)

FLOOR	S.F.L.	F.F.L.
33/F	+ 133.00	+ 133.05
35/F	+ 136.50	+ 136.55

NO.	DATE	GENERAL REVISION	BY
A	14/04/2020	GENERAL REVISED	

CLIENT :
佳明集團控股有限公司
 GRAND MING GROUP HOLDINGS LIMITED

MAIN CONTRACTOR :
GRAND TECH CONSTRUCTION CO. LTD.

ARCHITECT : **WONG TUNG & PARTNERS LIMITED**
 ARCHITECTS & PLANNERS

STRUCTURAL ENGINEER :



C M WONG & ASSOCIATES LTD

美特鋁質有限公司
MIDI ALUMINIUM FABRICATOR LTD.
 Units 6-8, Sunray Industrial Centre, 1/F
 610 Cha Kwo Ling Road, Kowloon
 Tel: 23489211-4 Fax: (852) 27727666

PROJECT :
 RESIDENTIAL DEVELOPMENT AT
 TSING YI TOWN LOT 190 SAI SHAN ROAD

TITLE :
 LOCATION KEY PLAN OF ALUM. CLADDING
 AT 33/F & 35/F FOR T1/1A & T2/2A

JOB NO. :	J851
DRAWN BY : DL	DATE : 18-11-2019
CHKD BY :	SCALE A1: 1 : 200
DWG. NO. : J851-ACF-P02	REV. : A

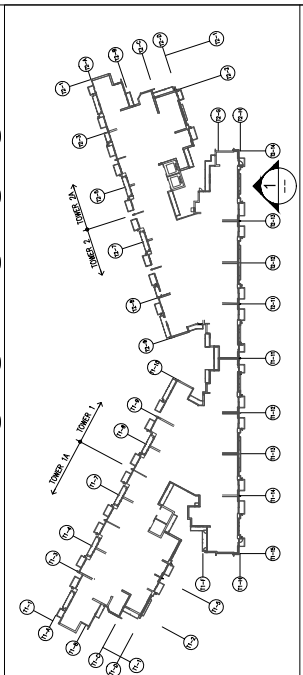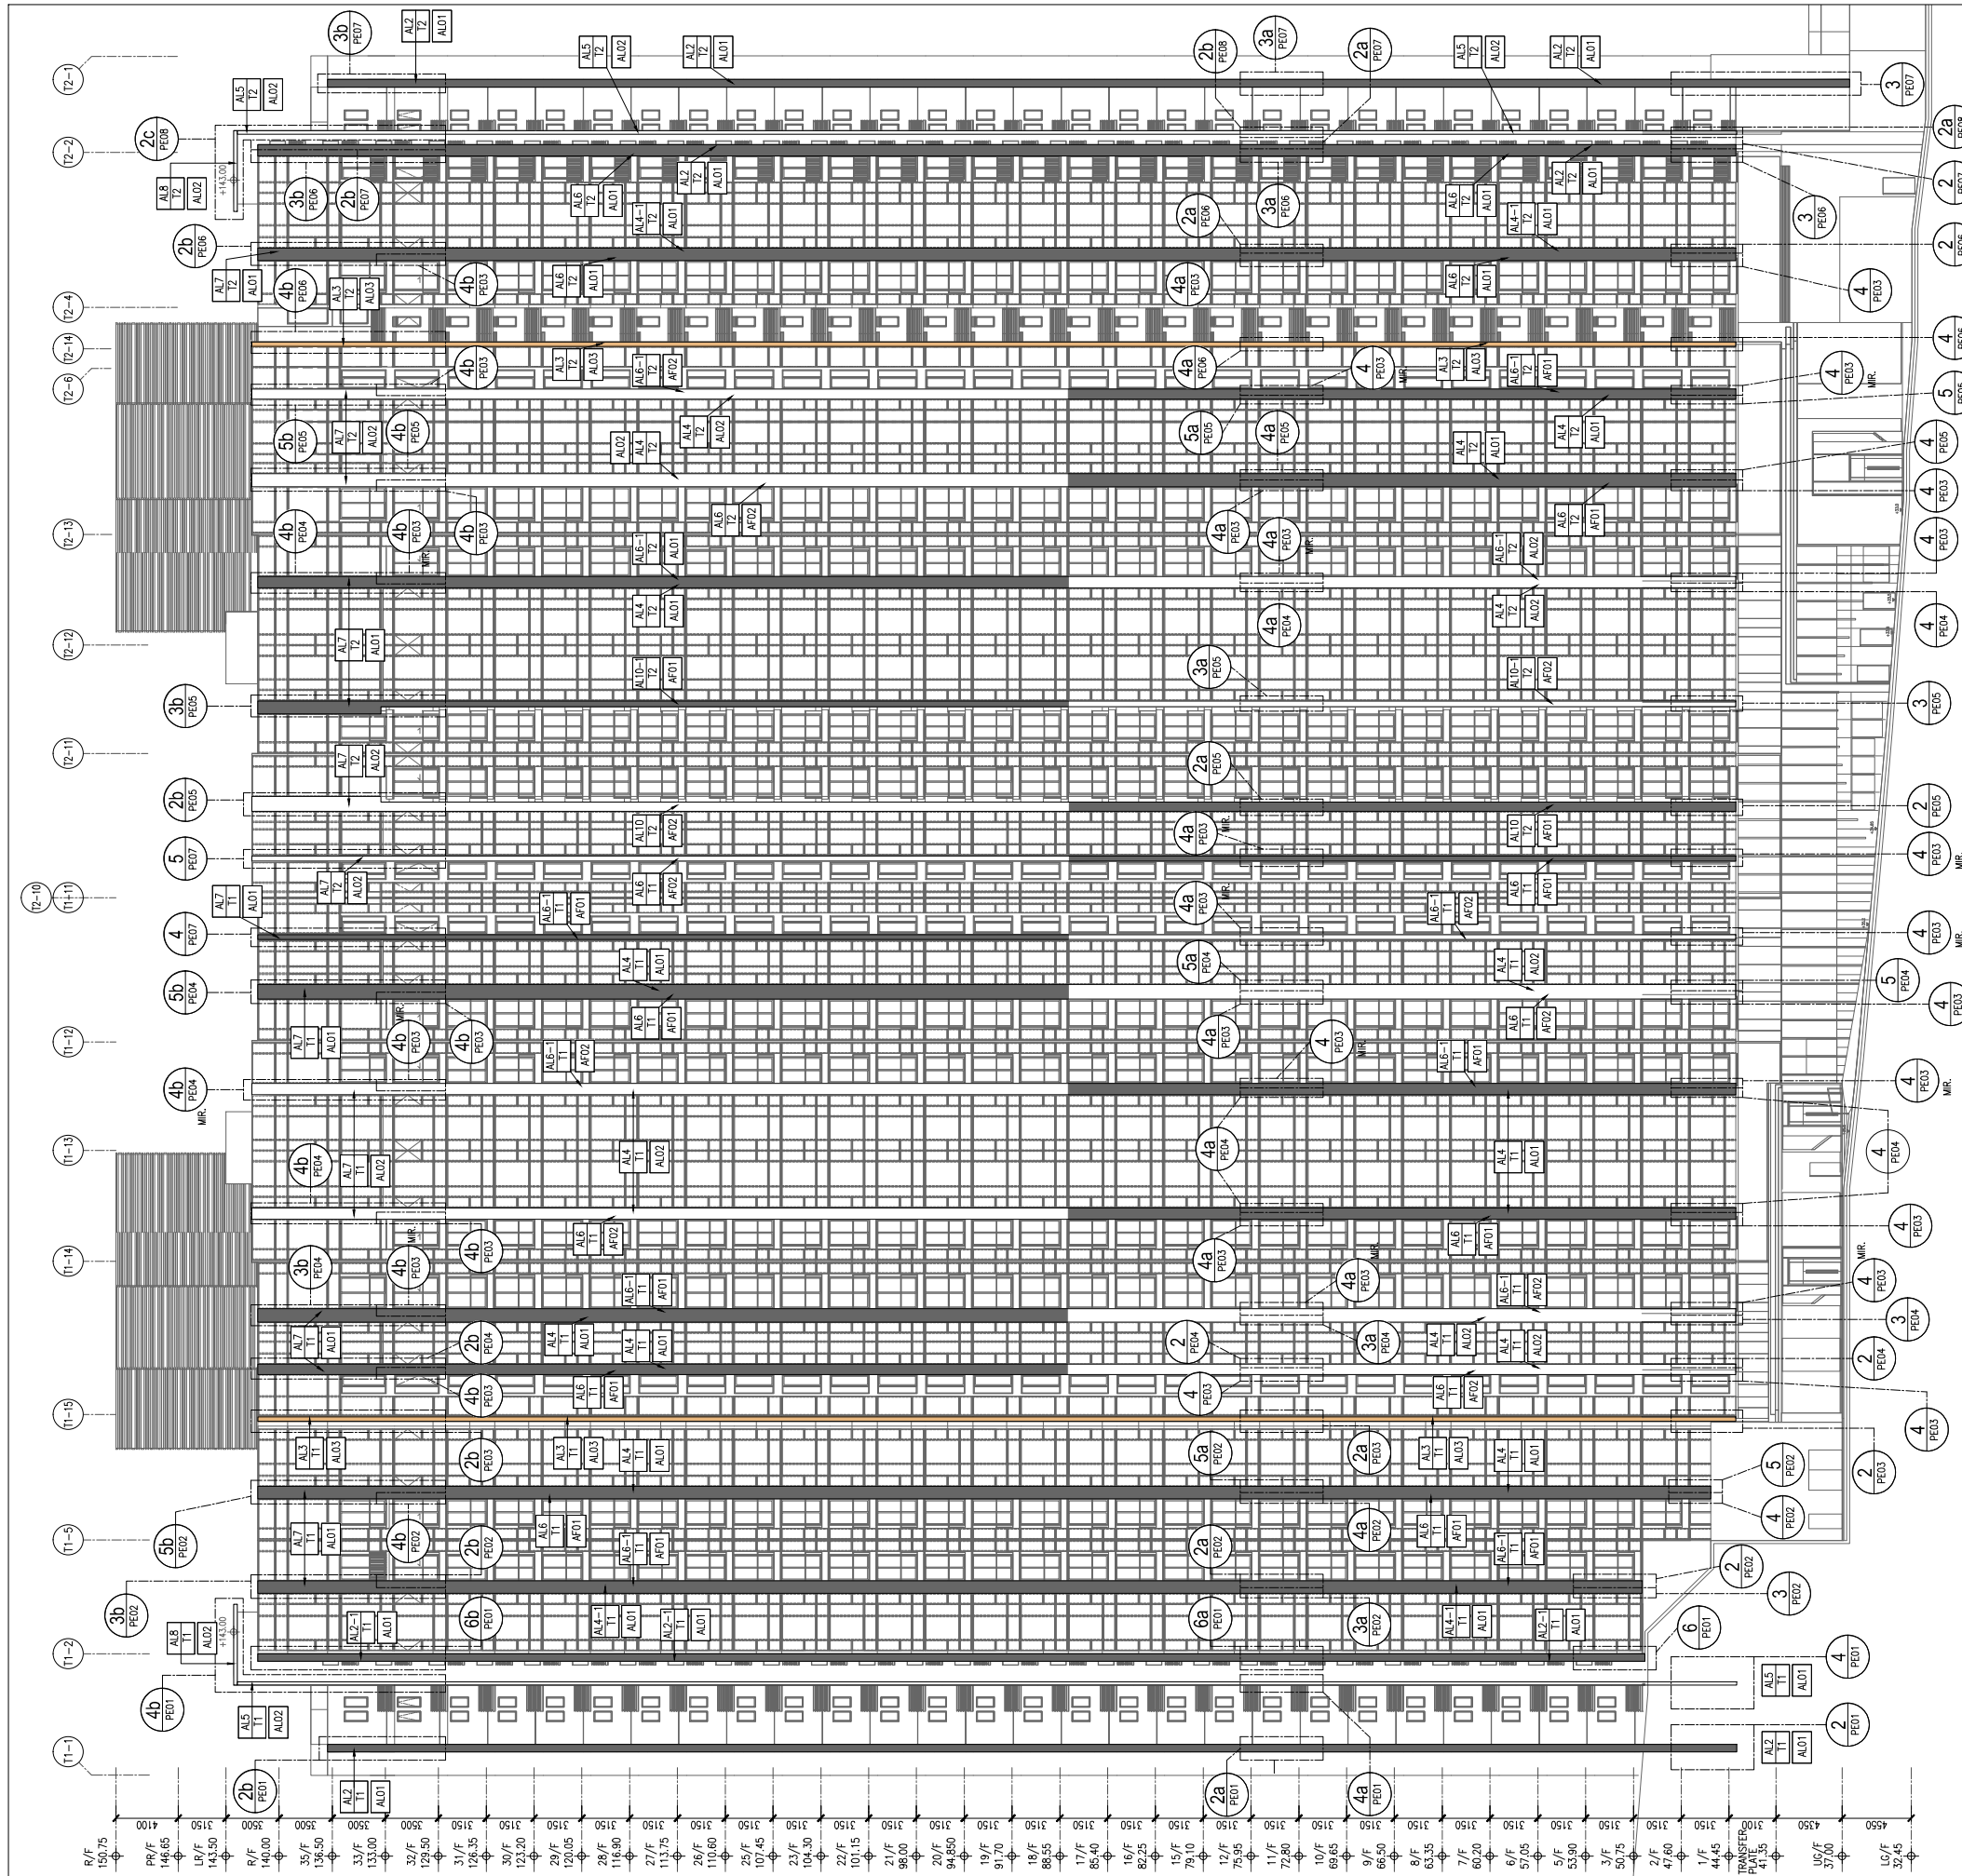

1 FRONT ELEVATION
 LOCATION: REFER TO DWG NO. P-01-P-03
 SCALE: N.T.S.

F.S.D. REF :
 Note:
 1. All dimensions are in mm.
 2. All elevations are viewed from outside.
 3. All dimensions to be verified on site before fabrication.

GENERAL NOTES

Legend :

1. F.F.L.-- Finished Floor Level
 2. S.F.L.-- Structural Floor Level
 3. (R) -- Reversed Detail
 4. MIR. -- Mirror

X1 -- DETAIL MARK NO.
 X001 -- REFER SHEET NO.

LEGEND	NOTICES	
	DARK GREY ALUMINIUM CLADDING (3mm THK.) w/ DARK GREY SEALANT	AL01
	WHITE ALUMINIUM CLADDING (3mm THK.) w/ WHITE SEALANT	AL02
	SANDY BROWN ALUMINIUM CLADDING (3mm THK.) w/ WHITE SEALANT	AL03
	DARK GREY ALUMINIUM PANEL/ EXTRUSION (3mm THK.)	AF01
	WHITE ALUMINIUM PANEL/ EXTRUSION (3mm THK.)	AF02
	SILVER GREY ALUMINIUM PANEL/ EXTRUSION (3mm THK.)	AF06

⊕ STRUCTURE LEVEL
 ⊕ FINISH LEVEL

SYMBOL:

	AL11 DARK GREY ALUMINIUM EXTRUDED FRAME (3mm THK.)
	AL12 WHITE ALUMINIUM EXTRUDED FRAME (3mm THK.)
	AL03 SANDY BROWN ALUMINIUM EXTRUDED FRAME (3mm THK.)

NO.	DATE	GENERAL REVISED	BY
A	14/04/2020		

CLIENT :
佳明集團控股有限公司
 GRAND MING GROUP HOLDINGS LIMITED

MAIN CONTRACTOR :
GRAND TECH CONSTRUCTION CO. LTD.

ARCHITECT : **WONG TUNG & PARTNERS LIMITED**
 ARCHITECTS & PLANNERS



STRUCTURAL ENGINEER :
 C M WONG & ASSOCIATES LTD

美特鋁質有限公司
MIDI ALUMINIUM FABRICATOR LTD.
 Units 6-8, Sunray Industrial Centre, 1/F
 610 Cha Kwo Ling Road, Kowloon
 Tel:23489211-4 Fax:(852)2727666

PROJECT :
 RESIDENTIAL DEVELOPMENT AT
 TSING YI TOWN LOT 190 SAI SHAN ROAD



TITLE :
 FRONT ELEVATION

JOB NO. :	J851
DRAWN BY : DL	DATE : 18-11-2019
CHKD BY :	SCALE A1: N.T.S.
DWG. NO. : J851-ACF-E01	REV. : A

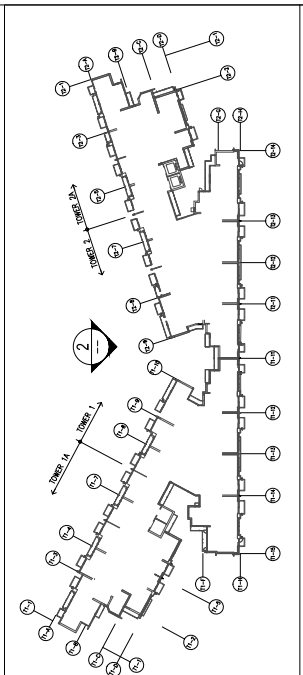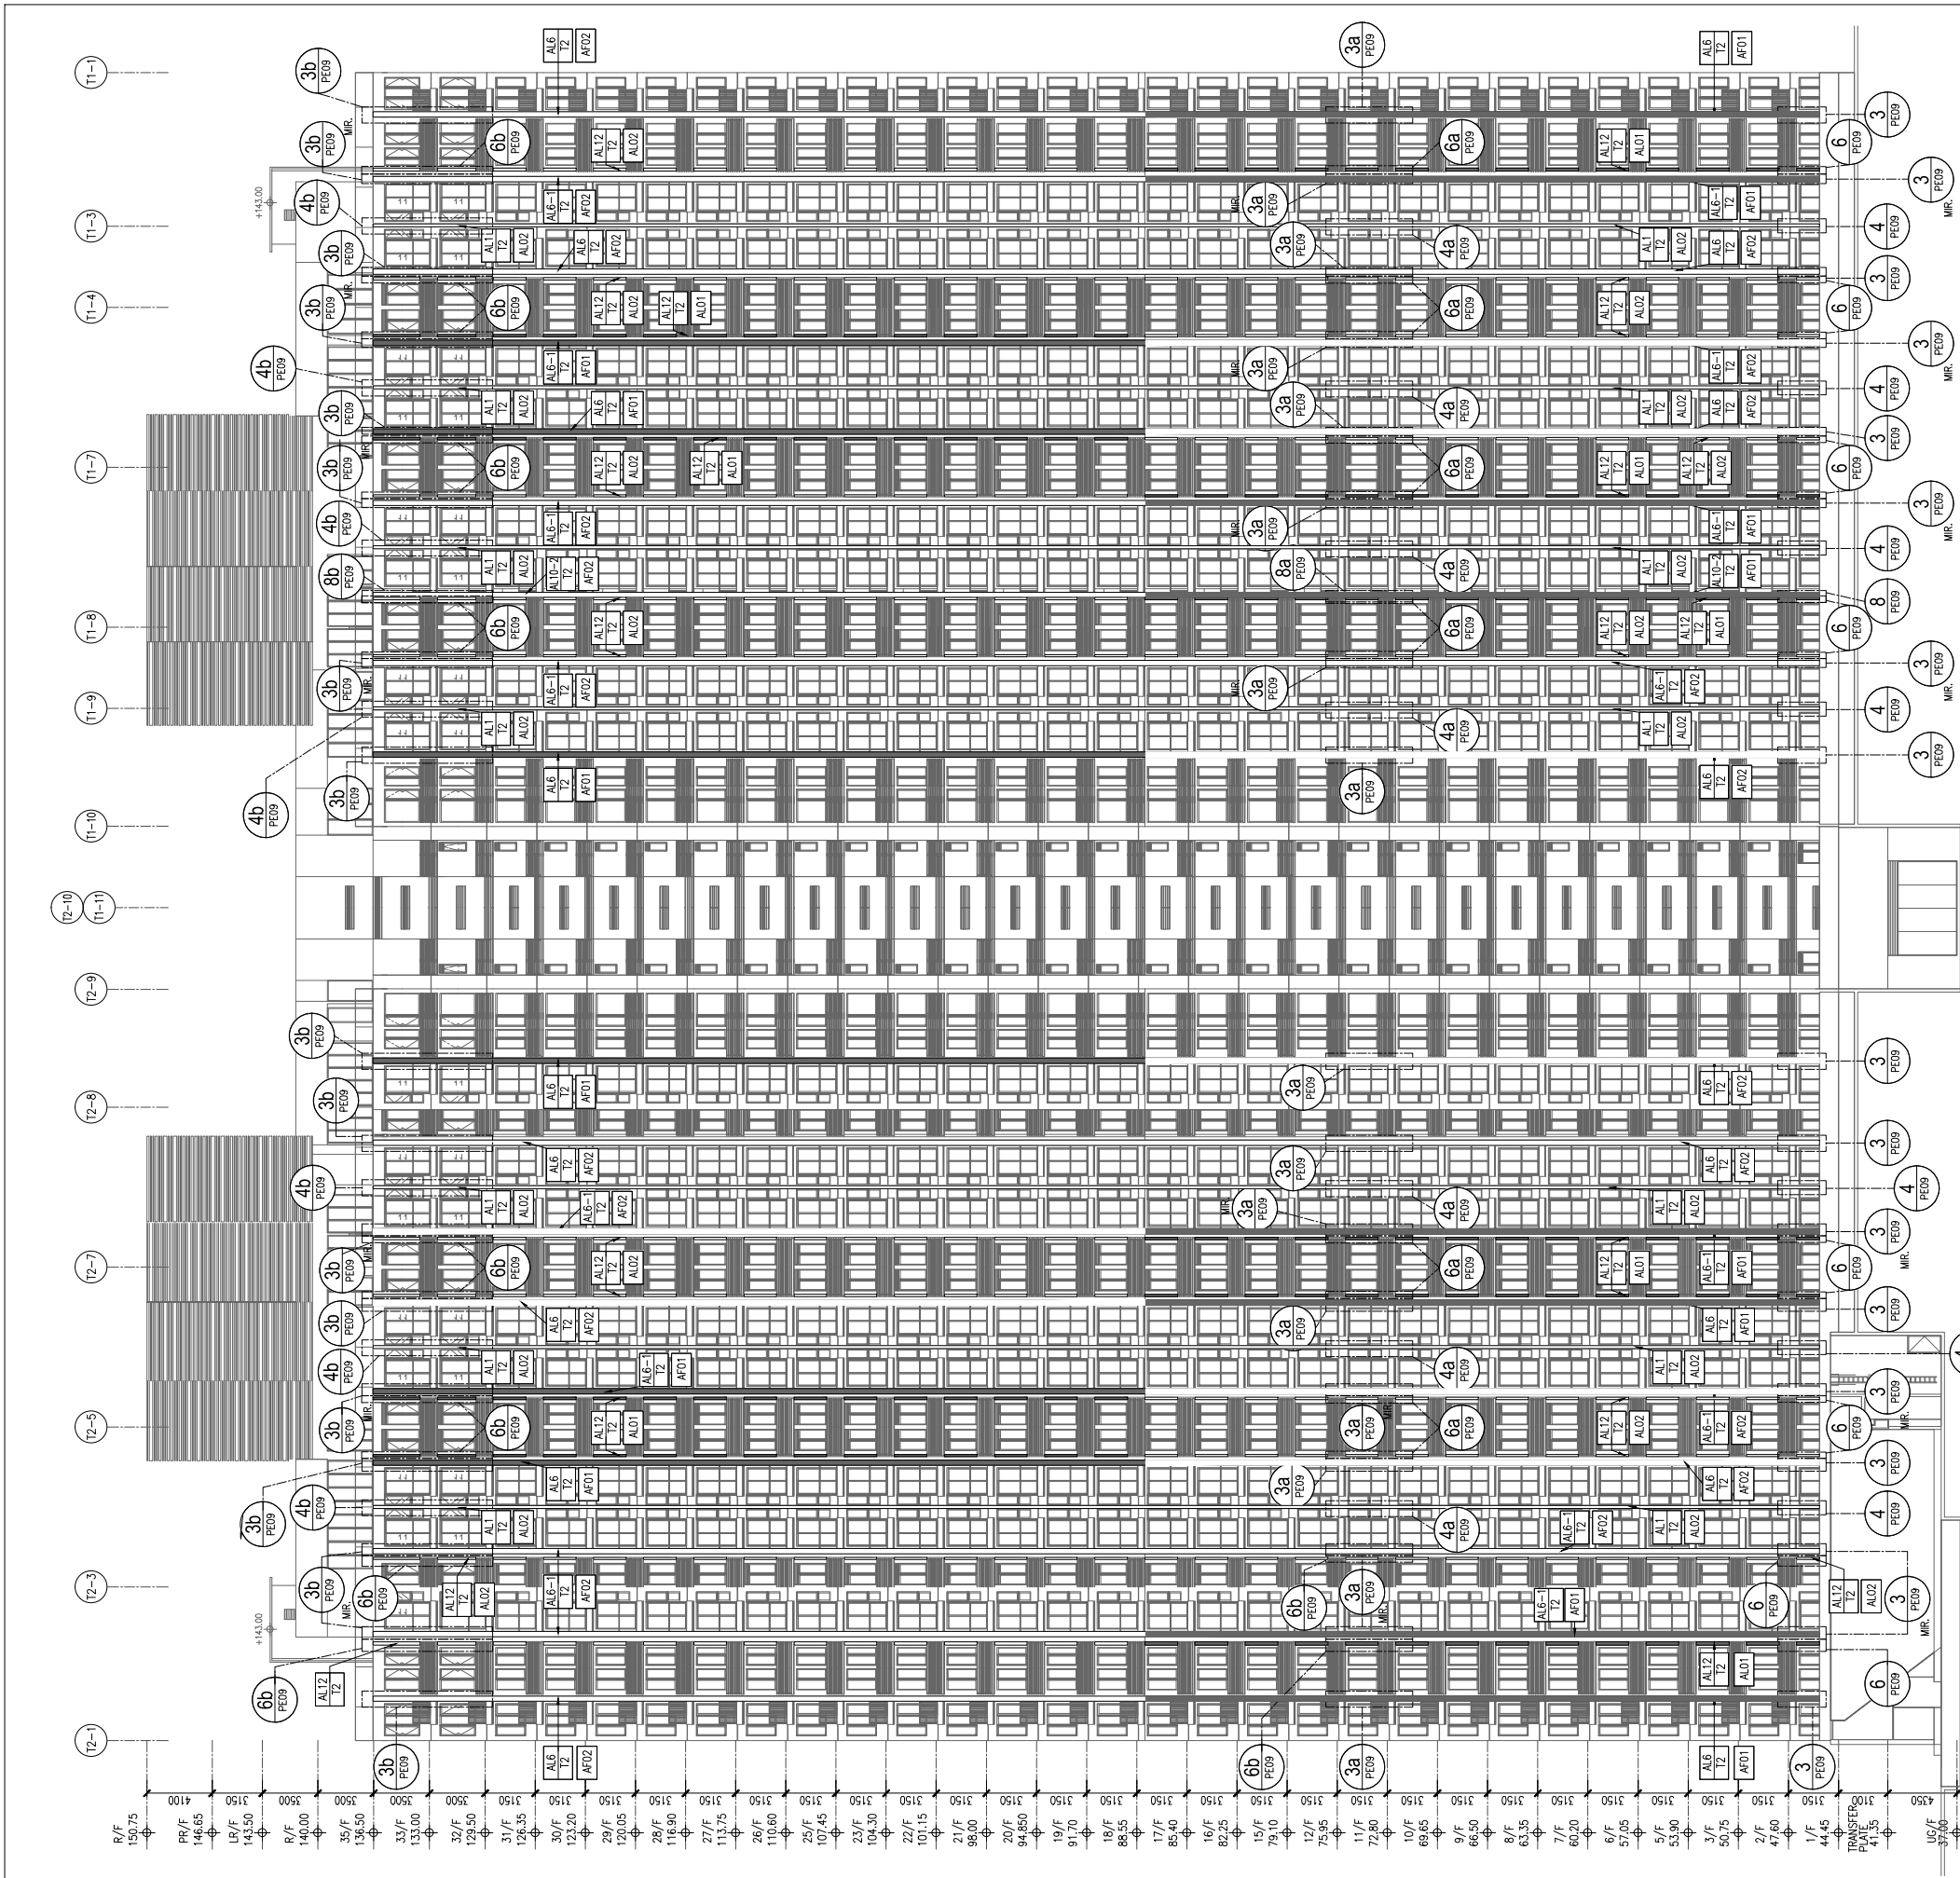

2 BACK ELEVATION
 LOCATION: REFER TO DWG NO. P-01-P-02
 SCALE: N.T.S.

F.S.D. REF :													
Note :													
1. All dimensions are in mm.													
2. All elevations are viewed from outside.													
3. All dimensions to be verified on site before fabrication.													
GENERAL NOTES													
Legend :													
1. F.F.L.-- Finished Floor Level													
2. S.F.L.-- Structural Floor Level													
3. (R) -- Reversed Detail													
4. MR. -- Mirror													
DETAIL MARK NO. REFER SHEET NO.													
KEY PLAN	LEGEND												
DARK GREY ALUMINIUM CLADDING (3mm THK.) w/ DARK GREY SEALANT WHITE ALUMINIUM CLADDING (3mm THK.) w/ WHITE SEALANT SANDY BROWN ALUMINIUM CLADDING (3mm THK.) w/ WHITE SEALANT DARK GREY ALUMINIUM PANEL/ EXTRUSION (3mm THK.) WHITE ALUMINIUM PANEL/ EXTRUSION (3mm THK.) SILVER GREY ALUMINIUM PANEL/ EXTRUSION (3mm THK.)	<table border="1"> <tr> <td>AL01</td> <td>NOTICES</td> </tr> <tr> <td>AL02</td> <td></td> </tr> <tr> <td>AL03</td> <td></td> </tr> <tr> <td>AF01</td> <td></td> </tr> <tr> <td>AF02</td> <td></td> </tr> <tr> <td>AF06</td> <td></td> </tr> </table>	AL01	NOTICES	AL02		AL03		AF01		AF02		AF06	
AL01	NOTICES												
AL02													
AL03													
AF01													
AF02													
AF06													
STRUCTURE LEVEL FINISH LEVEL													
SYMBOL:													
AL11 DARK GREY ALUMINIUM EXTRUDED FRAME (3mm THK.)													
AL12 WHITE ALUMINIUM EXTRUDED FRAME (3mm THK.)													
<table border="1"> <tr> <td>A</td> <td>14/04/2020</td> <td>GENERAL</td> <td>REVISED</td> </tr> <tr> <td>NO.</td> <td>DATE</td> <td>REVISED</td> <td>BY</td> </tr> </table>		A	14/04/2020	GENERAL	REVISED	NO.	DATE	REVISED	BY				
A	14/04/2020	GENERAL	REVISED										
NO.	DATE	REVISED	BY										
CLIENT :													
佳明集團控股有限公司 GRAND MING GROUP HOLDINGS LIMITED													
MAIN CONTRACTOR :													
GRAND TECH CONSTRUCTION CO. LTD.													
ARCHITECT :													
WONG TUNG & PARTNERS LIMITED ARCHITECTS & PLANNERS 													
STRUCTURAL ENGINEER :													
C M WONG & ASSOCIATES LTD													
美特鋁質有限公司 MIDI ALUMINIUM FABRICATOR LTD. Units 6-8, Sunray Industrial Centre, 1/F 610 Cha Kwo Ling Road, Kowloon Tel:23489211-4 Fax:(852)2727666													
PROJECT :													
RESIDENTIAL DEVELOPMENT AT TSING YI TOWN LOT 190 SAI SHAN ROAD													
TITLE :													
REAR ELEVATION													
JOB NO. :	J851												
DRAWN BY : DL	DATE : 18-11-2019												
CHKD BY :	SCALE A1: N.T.S.												
DWG. NO. : J851-ACF-E02	REV. : A												

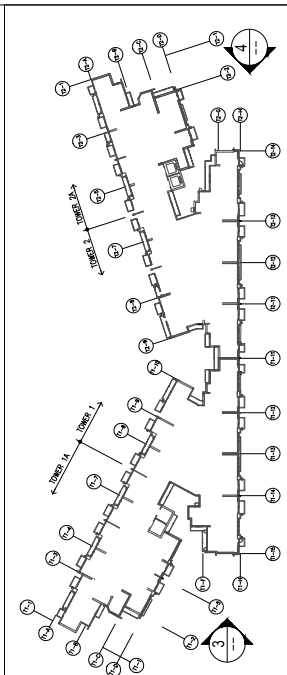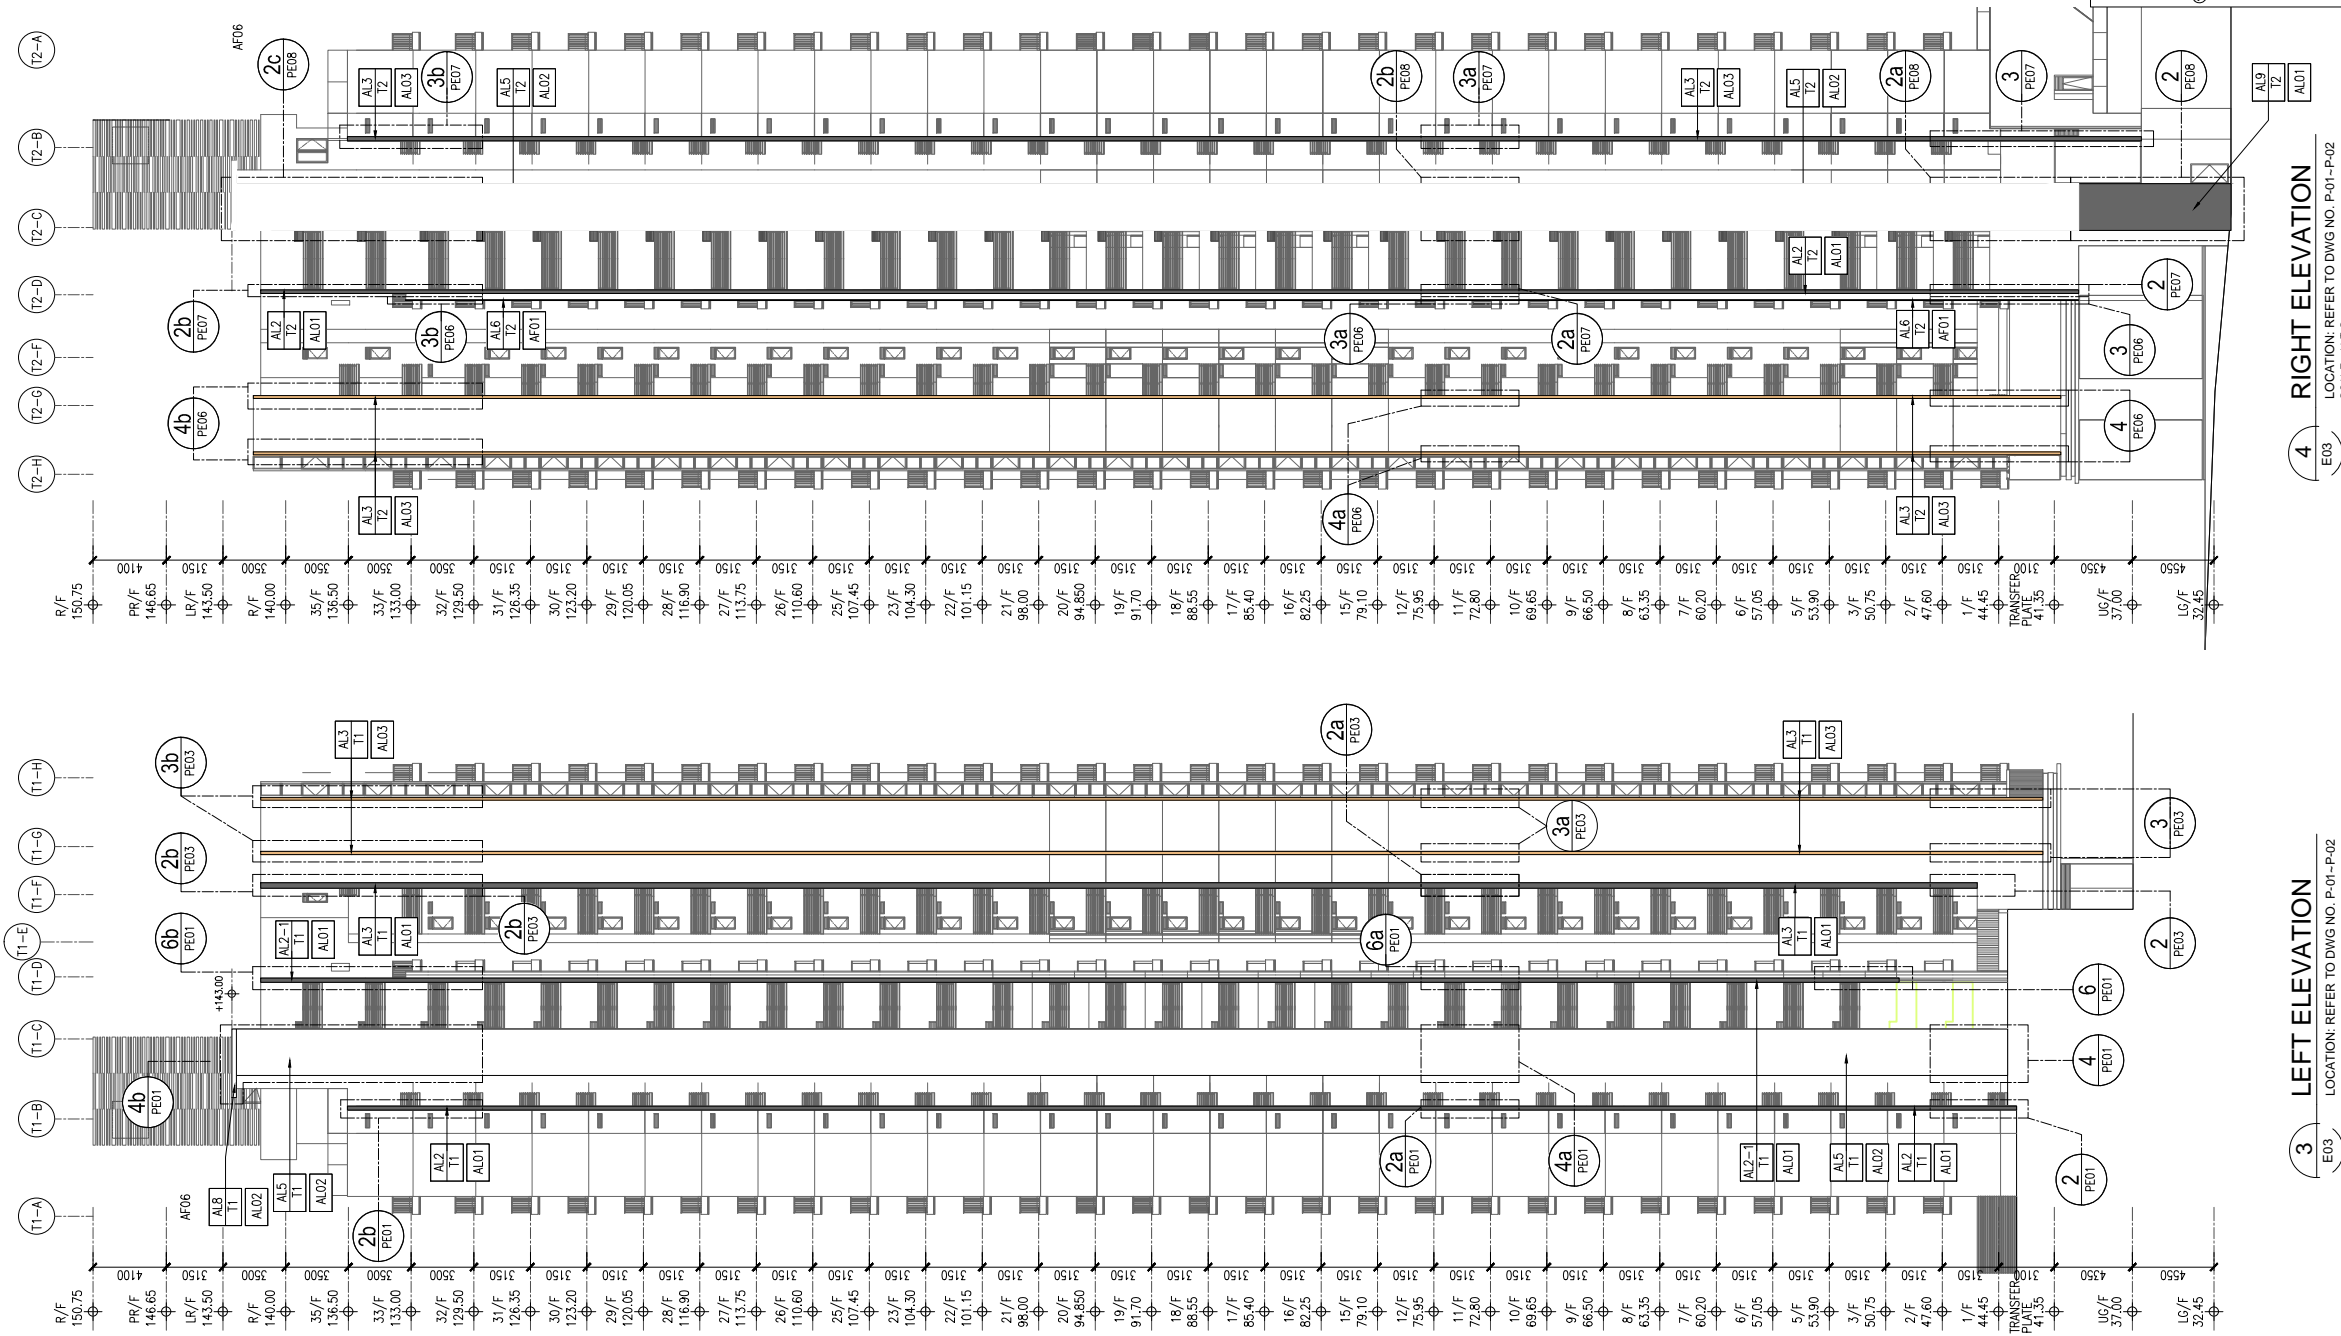

F.S.D. REF :

Note :

- All dimensions are in mm.
- All elevations are viewed from outside.
- All dimensions to be verified on site before fabrication.

GENERAL NOTES

Legend :

- F.F.L--- Finished Floor Level
- S.F.L--- Structural Floor Level
- (R) --- Reversed Detail
- MIR. --- Mirror

X1 --- DETAIL MARK NO.
X001 --- REFER SHEET NO.

LEGEND	NOTICES	
	DARK GREY ALUMINIUM CLADDING (3mm THK.) w/ DARK GREY SEALANT	AL01
	WHITE ALUMINIUM CLADDING (3mm THK.) w/ WHITE SEALANT	AL02
	SANDY BROWN ALUMINIUM CLADDING (3mm THK.) w/ WHITE SEALANT	AL03
	DARK GREY ALUMINIUM PANEL/ EXTRUSION (3mm THK.)	AF01
	WHITE ALUMINIUM PANEL/ EXTRUSION (3mm THK.)	AF02
	SILVER GREY ALUMINIUM PANEL/ EXTRUSION (3mm THK.)	AF06

	STRUCTURE LEVEL
	FINISH LEVEL

SYMBOL:

	AL11 DARK GREY ALUMINIUM EXTRUDED FRAME (3mm) IN PVF2 FINISH
	AL12 WHITE ALUMINIUM EXTRUDED FRAME (3mm) IN PVF2 FINISH
	AL03 SANDY BROWN ALUMINIUM EXTRUDED FRAME (3mm) IN PVF2 FINISH

A	NO.	DATE	GENERAL REVISION	REVISED	BY
	14/04/2020				

CLIENT :

佳明集團控股有限公司
GRAND MING GROUP HOLDINGS LIMITED

MAIN CONTRACTOR :

GRAND TECH CONSTRUCTION CO. LTD.

ARCHITECT :

WONG TUNG & PARTNERS LIMITED
ARCHITECTS & PLANNERS

STRUCTURAL ENGINEER :

C M WONG & ASSOCIATES LTD

美特銘質有限公司
MIDI ALUMINIUM FABRICATOR LTD.

Units 6-8, Sunray Industrial Centre, 1/F
610 Cho Kwo Ling Road, Kowloon
Tel:23489211-4 Fax:(852)2772666

PROJECT :

RESIDENTIAL DEVELOPMENT AT
TSING YI TOWN LOT 190 SAI SHAN ROAD

TITLE :

SIDE ELEVATIONS

JOB NO. : J851


DRAWN BY : DL DATE : N.T.S.

CHKD BY : SCALE A1: N.T.S.


DWG. NO. : J851-ACF-E03 REV. : A

RIGHT ELEVATION
LOCATION: REFER TO DWG NO. P-01-P-02
SCALE: N.T.S.

LEFT ELEVATION
LOCATION: REFER TO DWG NO. P-01-P-02
SCALE: N.T.S.

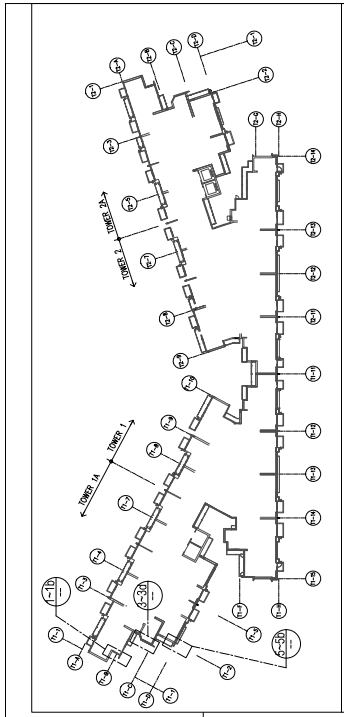

N.T.S.

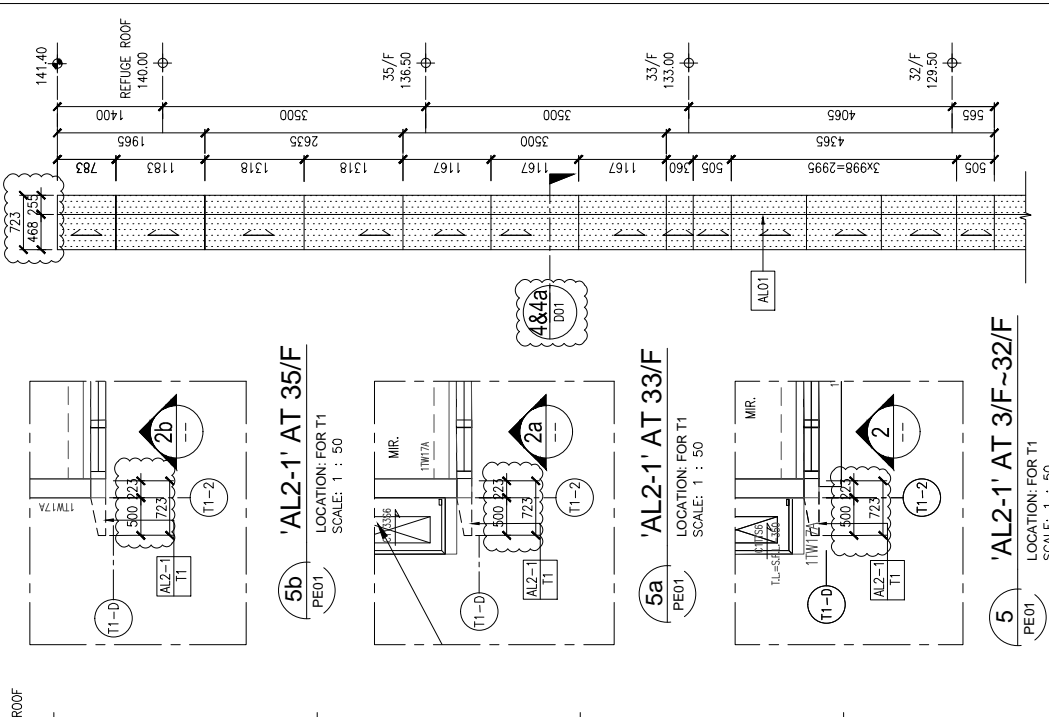


5D 'AL2-1' AT 35/F
LOCATION: FOR T1
SCALE: 1 : 50


5a 'AL2-1' AT 33/F
LOCATION: FOR T1
SCALE: 1 : 50

5b 'AL2-1' AT 32/F
LOCATION: FOR T1
SCALE: 1 : 50

5 'AL2-1' AT 32/F~35/F
LOCATION: FOR T1
SCALE: 1 : 50

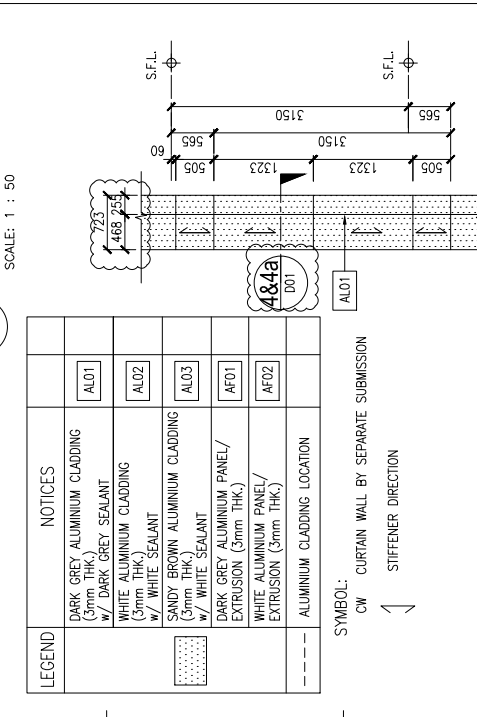


6b 'AL2-1' AT 32/F~35/F
LOCATION: FOR T1
SCALE: 1 : 50

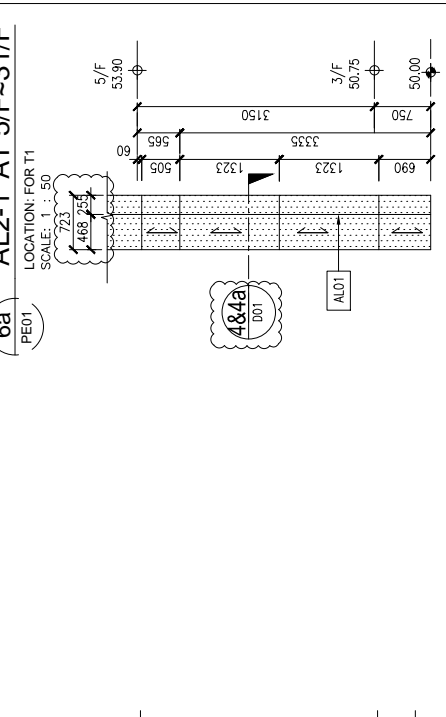


6a 'AL2-1' AT 5/F~31/F
LOCATION: FOR T1
SCALE: 1 : 50

LEGEND	NOTICES
[Symbol]	DARK GREY ALUMINIUM CLADDING (3mm THK) w/ DARK GREY SEALANT
[Symbol]	WHITE ALUMINIUM CLADDING (3mm THK) w/ WHITE SEALANT
[Symbol]	SANDY BROWN ALUMINIUM CLADDING (3mm THK) w/ WHITE SEALANT
[Symbol]	DARK GREY ALUMINIUM PANEL/ EXTRUSION (3mm THK) w/ WHITE SEALANT
[Symbol]	WHITE ALUMINIUM PANEL/ EXTRUSION (3mm THK)
[Symbol]	ALUMINIUM CLADDING LOCATION


SYMBOL: CW CURTAIN WALL BY SEPARATE SUBMISSION
STIFFENER DIRECTION

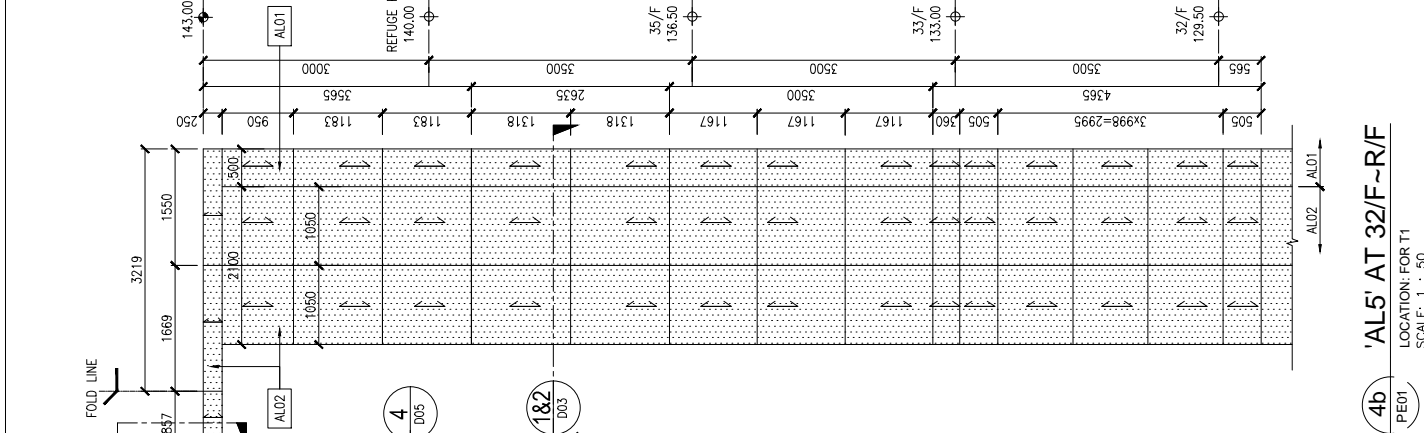


4b 'AL5' AT 32/F~R/F
LOCATION: FOR T1
SCALE: 1 : 50

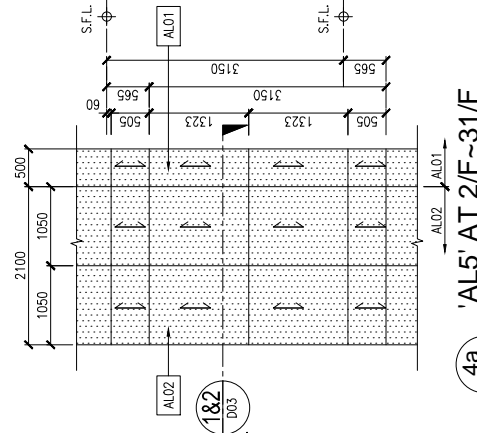


4a 'AL5' AT 2/F~31/F
LOCATION: FOR T1
SCALE: 1 : 50

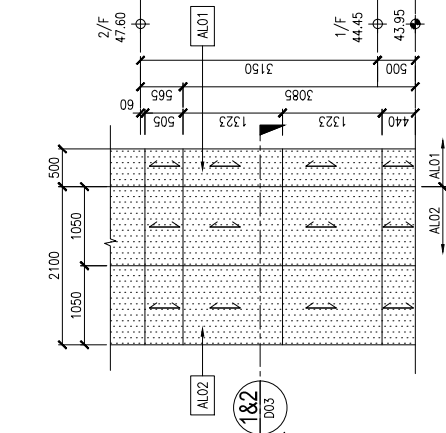


4 'AL5' AT 1/F
LOCATION: FOR T1
SCALE: 1 : 50

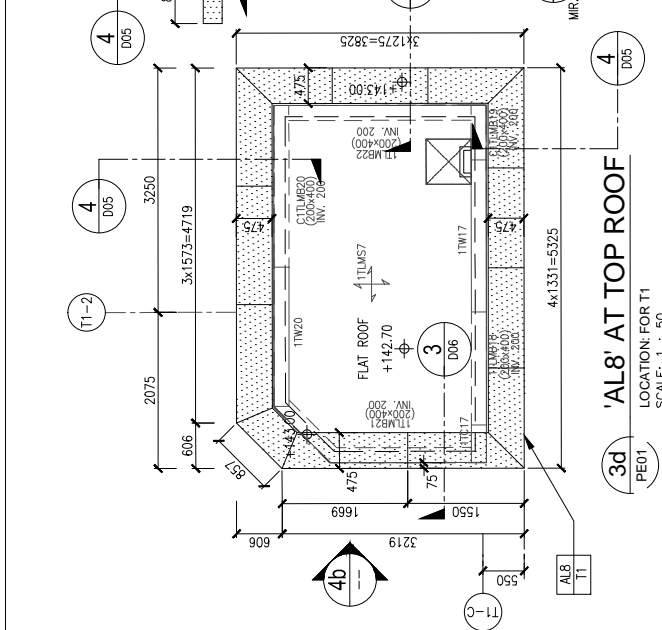


3d 'AL8' AT TOP ROOF
LOCATION: FOR T1
SCALE: 1 : 50

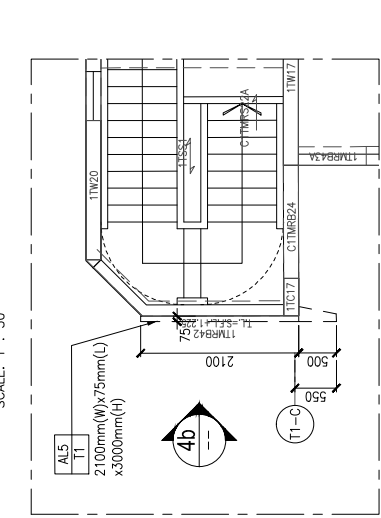


3c 'AL5' AT R/F
LOCATION: FOR T1
SCALE: 1 : 50

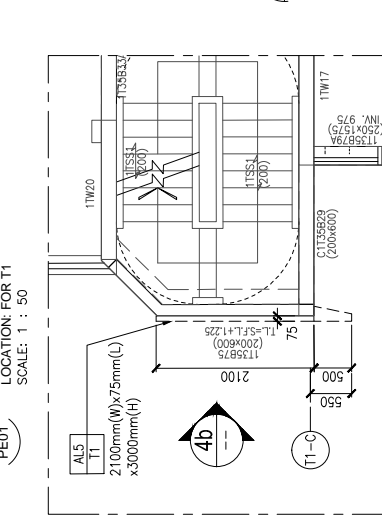


3b 'AL5' AT 33/F~35/F
LOCATION: FOR T1
SCALE: 1 : 50

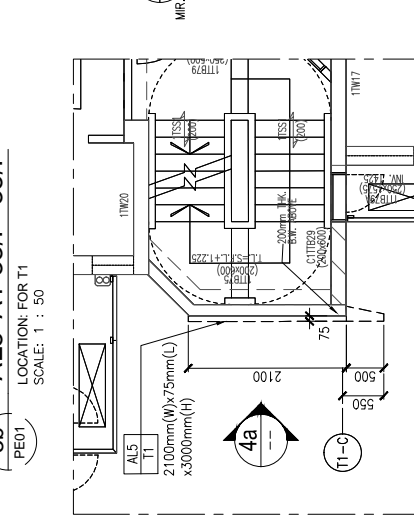


3a 'AL5' AT 2/F~32/F
LOCATION: FOR T1
SCALE: 1 : 50

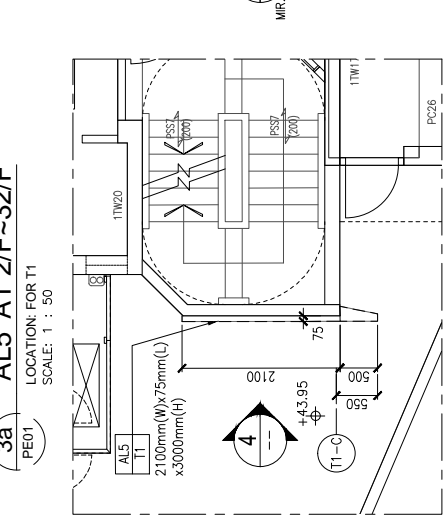


3 'AL5' AT 1/F
LOCATION: FOR T1
SCALE: 1 : 50

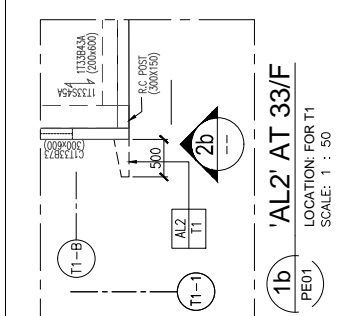


1b 'AL2' AT 33/F
LOCATION: FOR T1
SCALE: 1 : 50

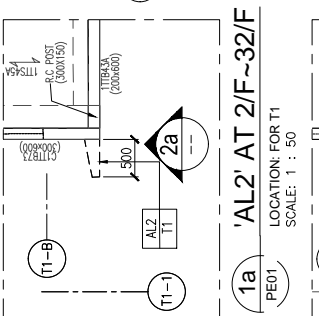


1a 'AL2' AT 2/F~32/F
LOCATION: FOR T1
SCALE: 1 : 50

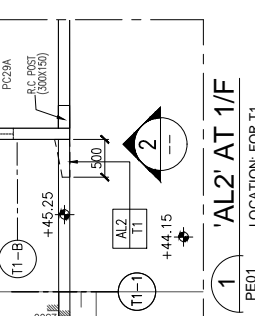


1 'AL2' AT 1/F
LOCATION: FOR T1
SCALE: 1 : 50

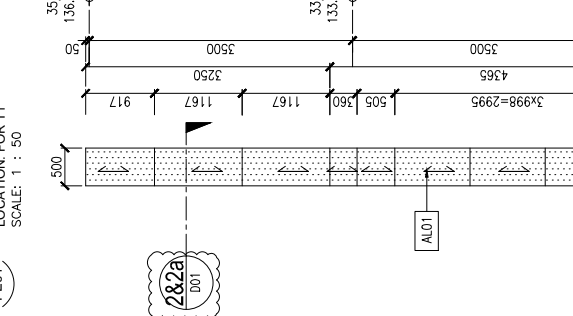

2b 'AL2' AT 32~33/F
LOCATION: FOR T1
SCALE: 1 : 50

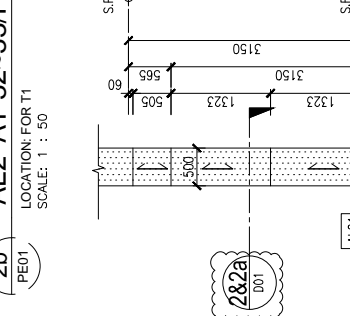

2a 'AL2' AT 2/F~31/F
LOCATION: FOR T1
SCALE: 1 : 50

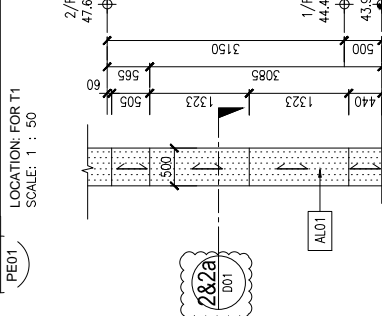

2 'AL2' AT 1/F
LOCATION: FOR T1
SCALE: 1 : 50

F.S.D. REF :
Note :
1. All dimensions are in mm.
2. All elevations are viewed from outside.
3. All dimensions to be verified on site before fabrication.

GENERAL NOTES

Legend :

1. F.F.L. -- Finished Floor Level
2. S.F.L. -- Structural Floor Level
3. (R) -- Reversed Detail
4. MIR -- Mirror

X1 -- DETAIL MARK NO.
X001 -- REFER SHEET NO.

STRUCTURAL & FINISH FLOOR LEVEL FOR T1, T2, 1/F~32/F (LOW, HIGH ZONE) (4TH, 13TH, 14TH, 24TH FLOOR OMITTED)

FLOOR	S.F.L.	F.F.L.
1/F	+ 44.45	+ 44.50
2/F	+ 47.60	+ 47.65
3/F	+ 50.75	+ 50.80
5/F	+ 53.90	+ 53.95
6/F	+ 57.05	+ 57.10
7/F	+ 60.20	+ 60.25
8/F	+ 63.35	+ 63.40
9/F	+ 66.50	+ 66.55
10/F	+ 69.65	+ 69.70
11/F	+ 72.80	+ 72.85
12/F	+ 75.95	+ 76.00
15/F	+ 79.10	+ 79.15
16/F	+ 82.25	+ 82.30
17/F	+ 85.40	+ 85.45
18/F	+ 88.55	+ 88.60
19/F	+ 91.70	+ 91.75
20/F	+ 94.85	+ 94.90
21/F	+ 98.00	+ 98.05
22/F	+ 101.15	+ 101.20
23/F	+ 104.30	+ 104.35
25/F	+ 107.45	+ 107.50
26/F	+ 110.60	+ 110.65
27/F	+ 113.75	+ 113.80
28/F	+ 116.90	+ 116.95
29/F	+ 120.05	+ 120.10
30/F	+ 123.20	+ 123.25
31/F	+ 126.35	+ 126.40
32/F	+ 129.50	+ 129.55
33/F	+ 133.00	+ 133.05
35/F	+ 136.50	+ 136.55
R/F	+ 140.00	+ 140.05

A	09/04/2020	GENERAL	REVISED	BY
NO.	DATE			

CLIENT :
佳明集團控股有限公司
GRAND MING GROUP HOLDINGS LIMITED

MAIN CONTRACTOR :
GRAND TECH CONSTRUCTION CO. LTD.

ARCHITECT :
WONG TUNG PARTNERS LIMITED
ARCHITECTS & PLANNERS

STRUCTURAL ENGINEER :
C M WONG & ASSOCIATES LTD

美特鋁質有限公司
MIDI ALUMINIUM FABRICATOR LTD.
Units 6-8, Sunray Industrial Centre, 1/F
610 Cha Kwo Ling Road, Kowloon
Tel: 23489211-4 Fax: (852) 27727666

PROJECT :
RESIDENTIAL DEVELOPMENT AT TSING YI TOWN LOT 190 SAI SHAN ROAD

TITLE :
PARTIAL PLAN & PARTIAL ELEVATION OF ALUM. CLADDING AT T1 1/F~35/F

JOB NO. : J851


DRAWN BY : DL DATE : 18-11-2019

CHKD BY : SCALE A1: 1 : 50


DWG. NO. : J851-ACF-PE01 REV. : A

LEGEND	NOTICES
	DARK GREY ALUMINIUM CLADDING (3mm THK.)
	WHITE ALUMINIUM CLADDING (3mm THK.)
	SANDY BROWN ALUMINIUM CLADDING (3mm THK.)
	DARK GREY ALUMINIUM PANEL/EXTRUSION (3mm THK.)
	WHITE ALUMINIUM PANEL/EXTRUSION (3mm THK.)
	ALUMINIUM CLADDING LOCATION


SYMBOL:
 CW CURTAIN WALL BY SEPARATE SUBMISSION
 STIFFENER DIRECTION

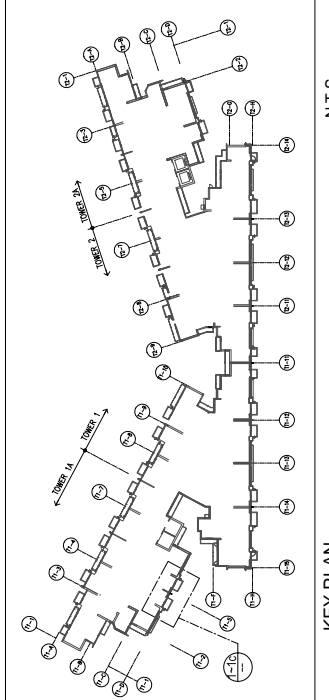


N.T.S.

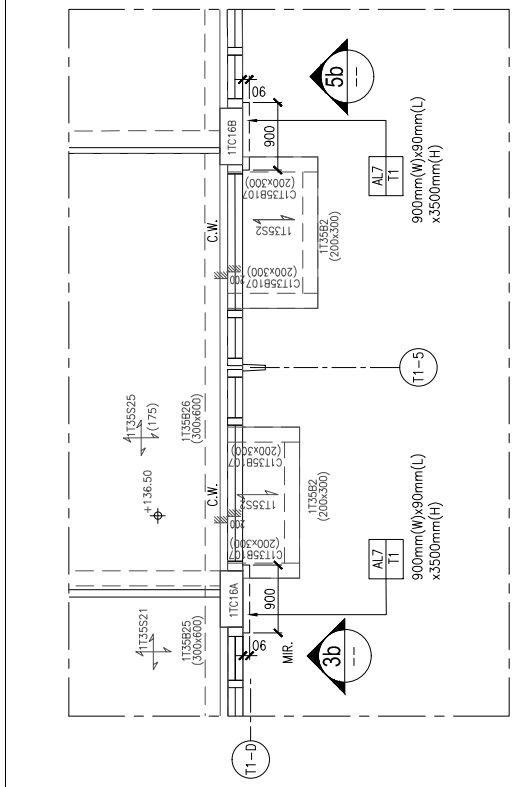


1C 'AL7' AT 35/F
 LOCATION: FOR T1
 SCALE: 1 : 50

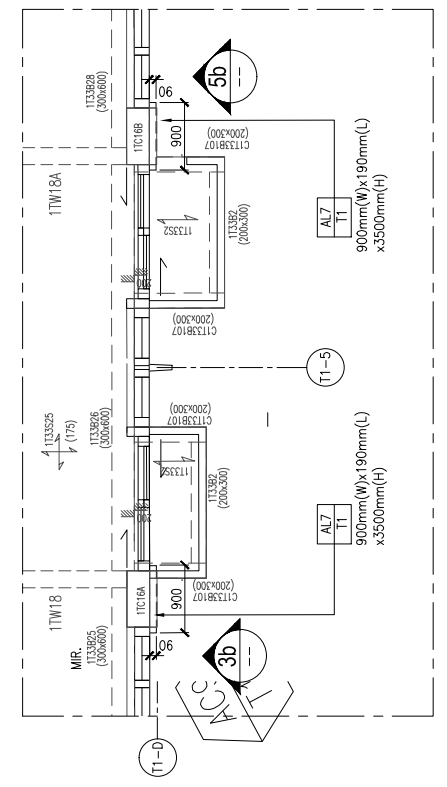


1b 'AL7' AT 33/F
 LOCATION: FOR T1
 SCALE: 1 : 50

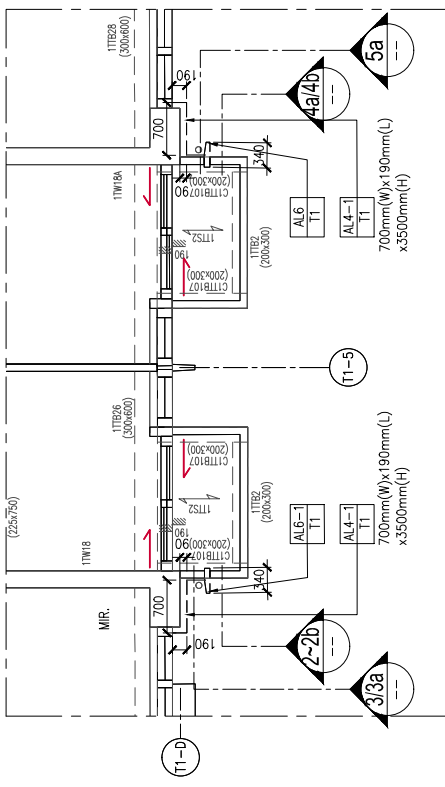

1a 'AL4-1', 'AL6' & 'AL16' AT 2/F~32/F
 LOCATION: FOR T1
 SCALE: 1 : 50

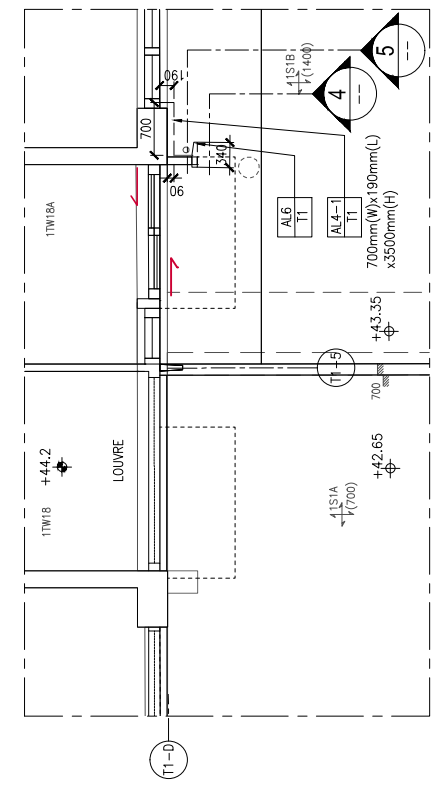

1 'AL4-1' & 'AL6' AT 1/F
 LOCATION: FOR T1
 SCALE: 1 : 50

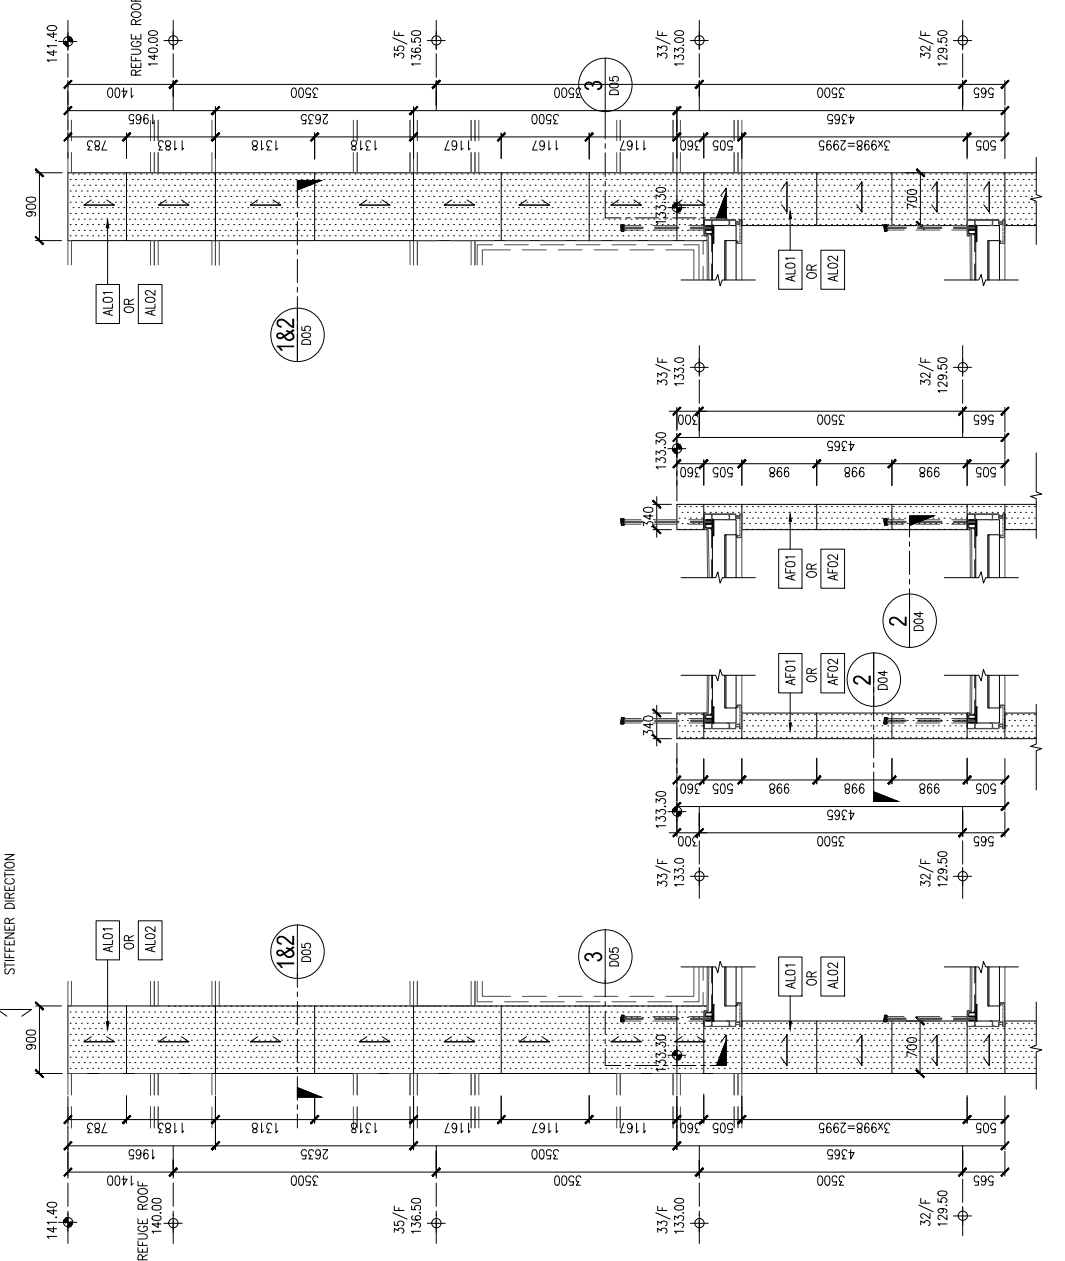


3b 'AL7' AT 32~35/F
 LOCATION: FOR T1
 SCALE: 1 : 50


2b 'AL6-1' AT 32/F
 LOCATION: FOR T1
 SCALE: 1 : 50

4b 'AL6' AT 32/F
 LOCATION: FOR T1
 SCALE: 1 : 50


5b 'AL7' AT 32~35/F
 LOCATION: FOR T1
 SCALE: 1 : 50

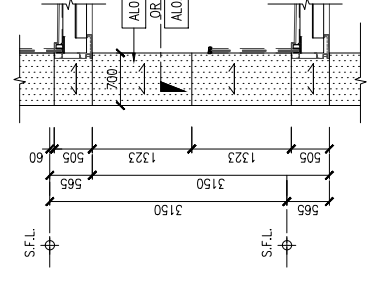


3a 'AL4-1' AT 6/F~31/F
 LOCATION: FOR T1
 SCALE: 1 : 50

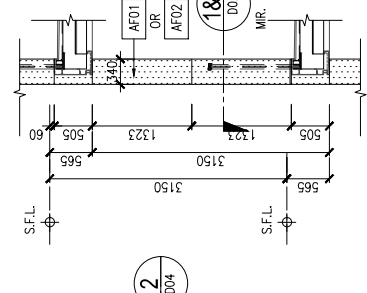


2a 'AL6-1' AT 6/F~31/F
 LOCATION: FOR T1
 SCALE: 1 : 50

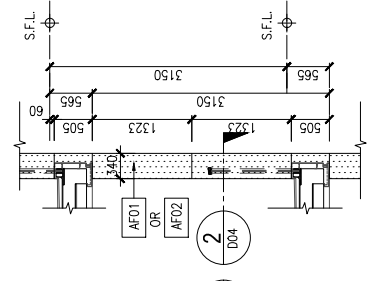


4a 'AL6' AT 2/F~31/F
 LOCATION: FOR T1
 SCALE: 1 : 50

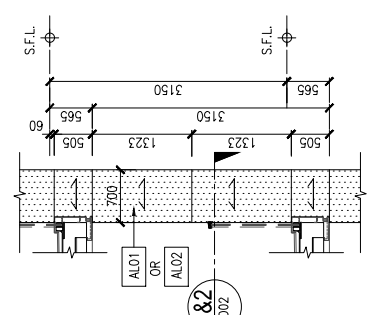


5a 'AL4-1' AT 2/F~31/F
 LOCATION: FOR T1
 SCALE: 1 : 50

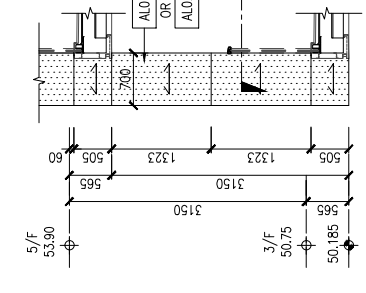


3 'AL4-1' AT 3/F
 LOCATION: FOR T1
 SCALE: 1 : 50

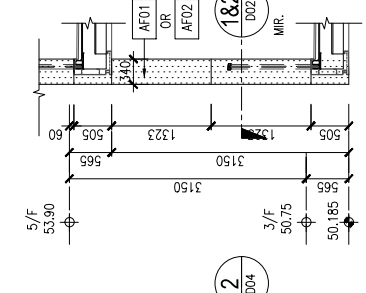

2 'AL6-1' AT 3/F
 LOCATION: FOR T1
 SCALE: 1 : 50

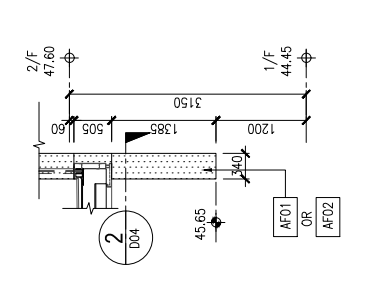

4 'AL6' AT 1/F
 LOCATION: FOR T1
 SCALE: 1 : 50

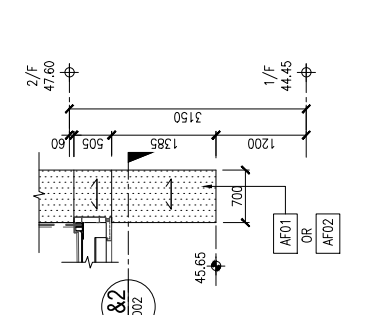

5 'AL4-1' AT 1/F
 LOCATION: FOR T1
 SCALE: 1 : 50

F.S.D. REF :
 Note :
 1. All dimensions are in mm.
 2. All elevations are viewed from outside.
 3. All dimensions to be verified on site before fabrication.

GENERAL NOTES

Legend :
 1. F.F.L -- Finished Floor Level
 2. S.F.L -- Structural Floor Level
 3. /R -- Reversed Detail
 4. MIR -- Mirror

X1 -- DETAIL MARK NO.
 X001 -- REFER SHEET NO.

FLOOR	S.F.L.	F.F.L.
1/F	+ 44.45	+ 44.50
2/F	+ 47.60	+ 47.65
3/F	+ 50.75	+ 50.80
5/F	+ 53.90	+ 53.95
6/F	+ 57.05	+ 57.10
7/F	+ 60.20	+ 60.25
8/F	+ 63.35	+ 63.40
9/F	+ 66.50	+ 66.55
10/F	+ 69.65	+ 69.70
11/F	+ 72.80	+ 72.85
12/F	+ 75.95	+ 76.00
15/F	+ 79.10	+ 79.15
16/F	+ 82.25	+ 82.30
17/F	+ 85.40	+ 85.45
18/F	+ 88.55	+ 88.60
19/F	+ 91.70	+ 91.75
20/F	+ 94.85	+ 94.90
21/F	+ 98.00	+ 98.05
22/F	+ 101.15	+ 101.20
23/F	+ 104.30	+ 104.35
25/F	+ 107.45	+ 107.50
26/F	+ 110.60	+ 110.65
27/F	+ 113.75	+ 113.80
28/F	+ 116.90	+ 116.95
29/F	+ 120.05	+ 120.10
30/F	+ 123.20	+ 123.25
31/F	+ 126.35	+ 126.40
32/F	+ 129.50	+ 129.55
33/F	+ 133.00	+ 133.05
35/F	+ 136.50	+ 136.55
R/F	+ 140.00	+ 140.05

STRUCTURAL & FINISH FLOOR LEVEL FOR T1, T2, 1/F~32/F (LOW, HIGH ZONE) (4TH, 13TH, 14TH, 24TH FLOOR OMITTED)		
A	14/04/2020	GENERAL REVISED
NO.	DATE	REVISED
BY		

CLIENT :
佳明集團控股有限公司
 GRAND MING GROUP HOLDINGS LIMITED

MAIN CONTRACTOR :
GRAND TECH CONSTRUCTION CO. LTD.

ARCHITECT :
WONG TUNG PARTNERS LIMITED
 ARCHITECTS & PLANNERS
















STRUCTURAL ENGINEER :
C M WONG & ASSOCIATES LTD

美特鋁質有限公司
 MIDI ALUMINIUM FABRICATOR LTD.
 Units 6-8, Sunray Industrial Centre, 1/F
 610 Cho Kwo Ling Road, Kowloon
 Tel: 23489211-4 Fax: (852) 27727666

PROJECT :
 RESIDENTIAL DEVELOPMENT AT
 TSING YI TOWN LOT 190 SAI SHAN ROAD

TITLE :
 PARTIAL PLAN & PARTIAL ELEVATION OF
 ALUM. CLADDING AT T1 1/F~35/F

JOB NO. :	J851
DRAWN BY : DL	DATE : 18-11-2019
CHKD BY :	SCALE A1: 1 : 50
DWG. NO. : J851-ACF-PE02	REV. : A

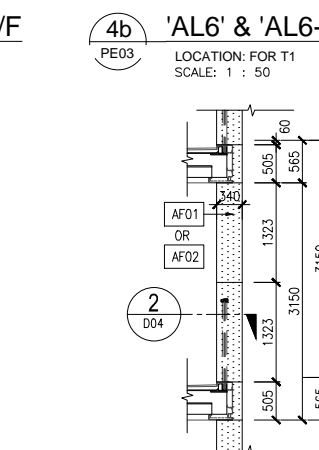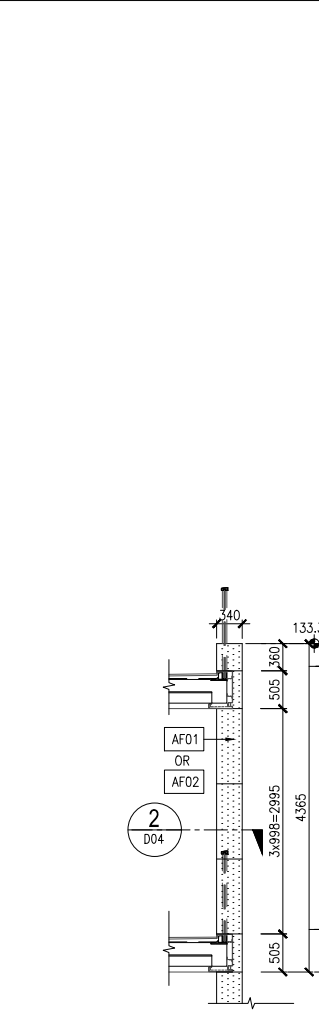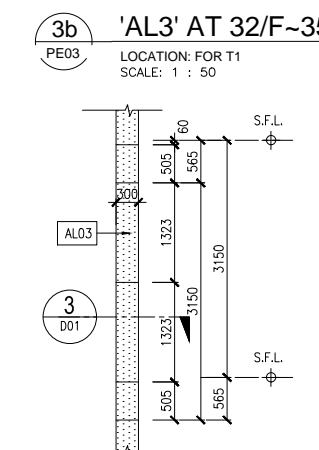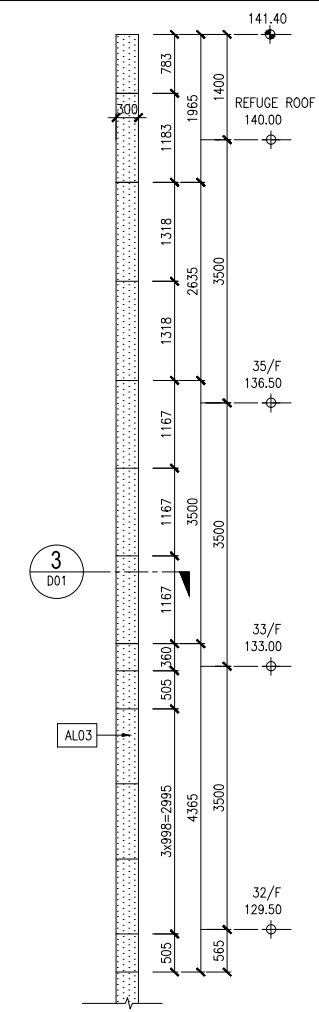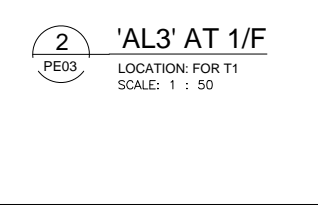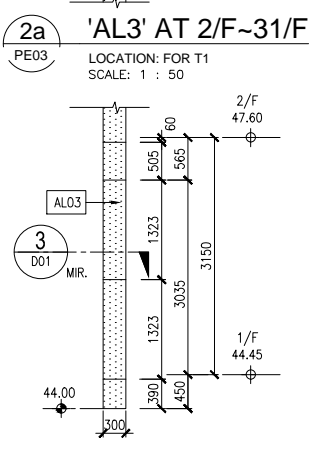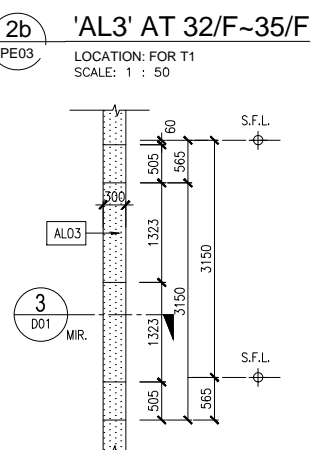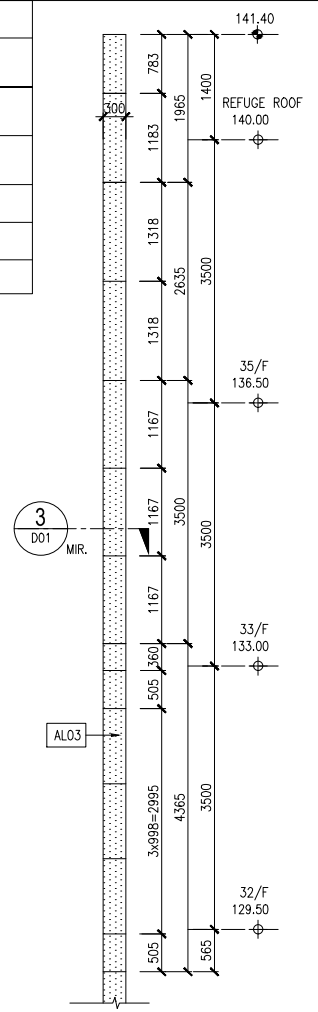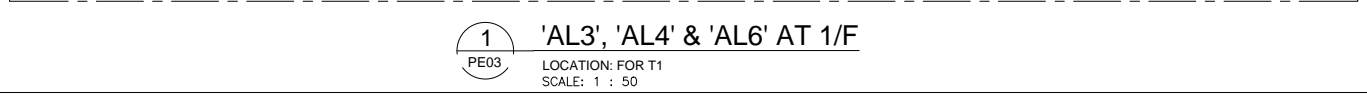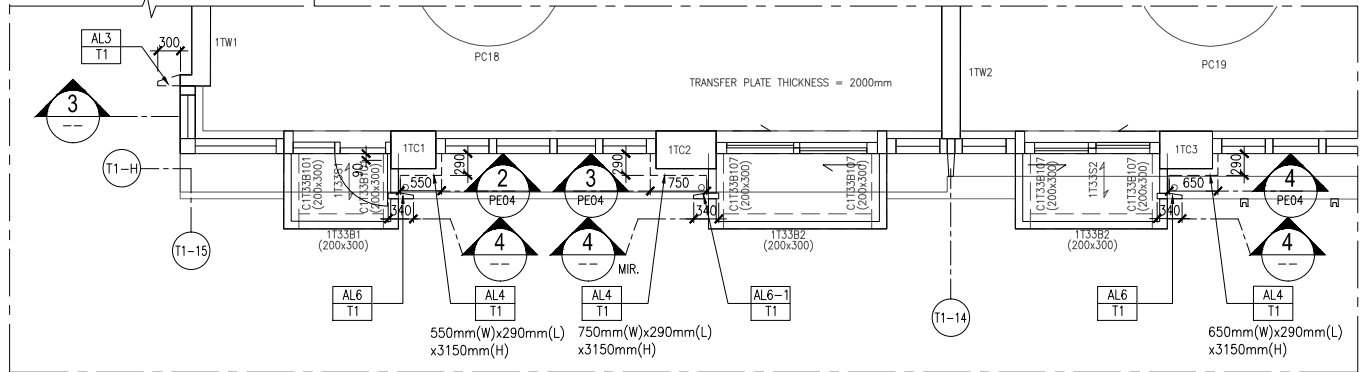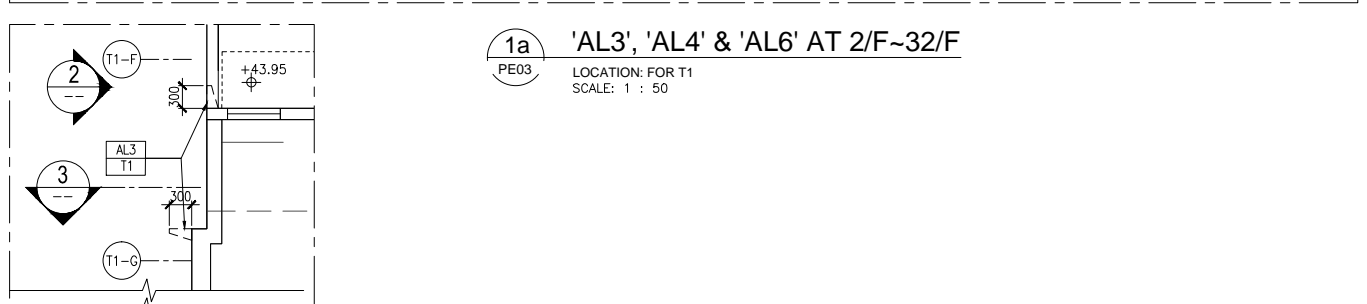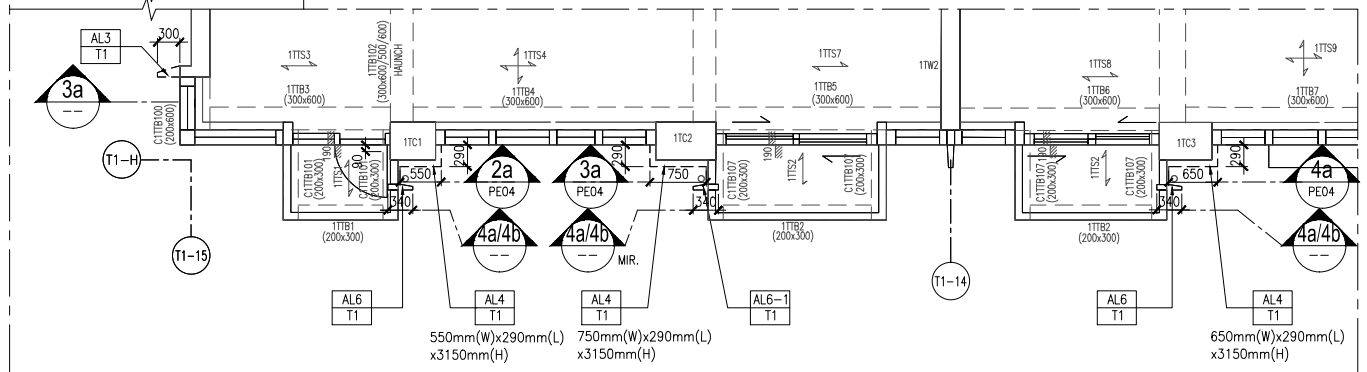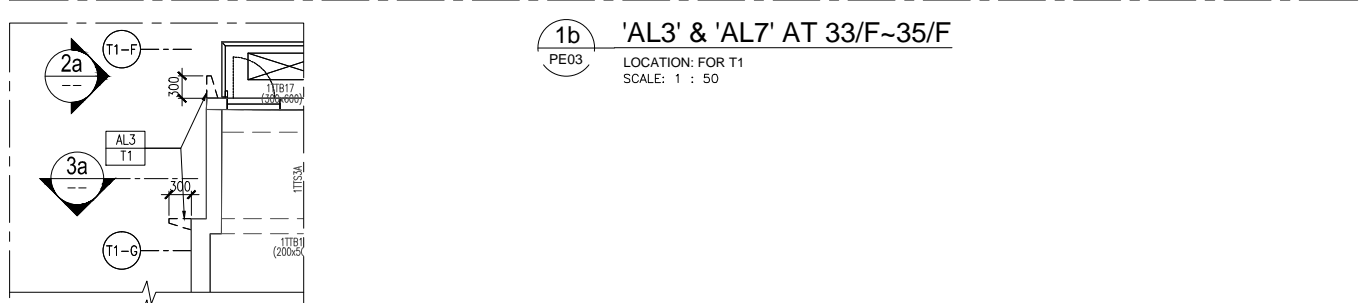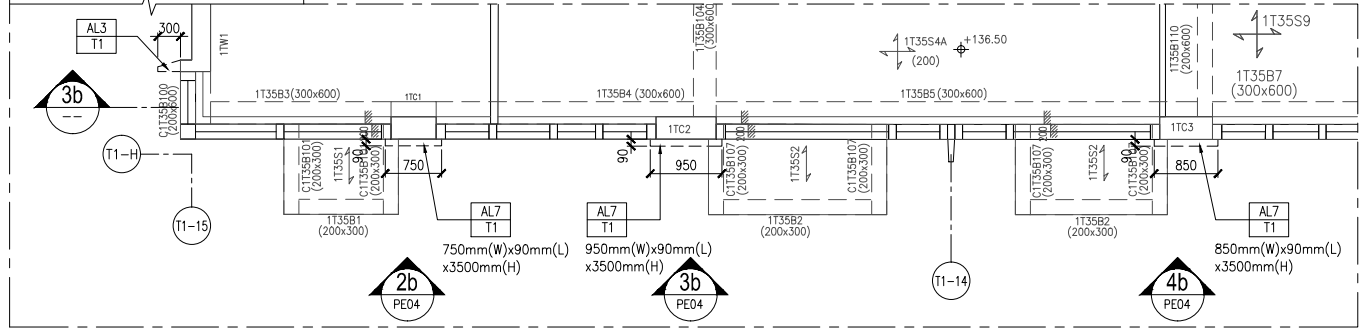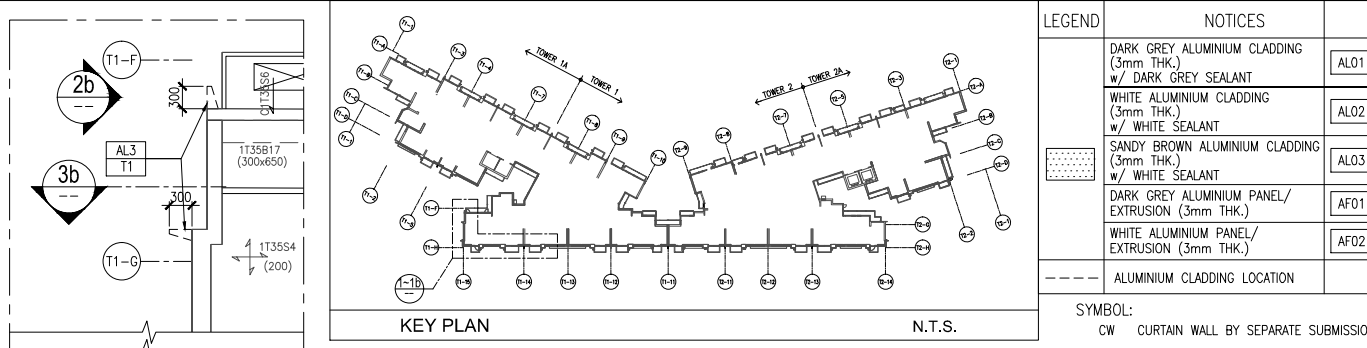

F.S.D. REF :

Note :

- All dimensions are in mm.
- All elevations are viewed from outside.
- All dimensions to be verified on site before fabrication.

GENERAL NOTES

Legend :

- F.F.L. -- Finished Floor Level
- S.F.L. -- Structural Floor Level
- (/R) -- Reversed Detail
- MIR. -- Mirror

X1 -- DETAIL MARK NO.
X001 -- REFER SHEET NO.

STRUCTURAL & FINISH FLOOR LEVEL FOR T1, T2, 1/F-32/F (LOW, HIGH ZONE) (4TH, 13TH, 14TH, 24TH FLOOR OMITTED)

FLOOR	S.F.L.	F.F.L.
1/F	+ 44.45	+ 44.50
2/F	+ 47.60	+ 47.65
3/F	+ 50.75	+ 50.80
5/F	+ 53.90	+ 53.95
6/F	+ 57.05	+ 57.10
7/F	+ 60.20	+ 60.25
8/F	+ 63.35	+ 63.40
9/F	+ 66.50	+ 66.55
10/F	+ 69.65	+ 69.70
11/F	+ 72.80	+ 72.85
12/F	+ 75.95	+ 76.00
15/F	+ 79.10	+ 79.15
16/F	+ 82.25	+ 82.30
17/F	+ 85.40	+ 85.45
18/F	+ 88.55	+ 88.60
19/F	+ 91.70	+ 91.75
20/F	+ 94.85	+ 94.90
21/F	+ 98.00	+ 98.05
22/F	+ 101.15	+ 101.20
23/F	+ 104.30	+ 104.35
25/F	+ 107.45	+ 107.50
26/F	+ 110.60	+ 110.65
27/F	+ 113.75	+ 113.80
28/F	+ 116.90	+ 116.95
29/F	+ 120.05	+ 120.10
30/F	+ 123.20	+ 123.25
31/F	+ 126.35	+ 126.40
32/F	+ 129.50	+ 129.55
33/F	+ 133.00	+ 133.05
35/F	+ 136.50	+ 136.55
R/F	+ 140.00	+ 140.05

A	14/04/2020	GENERAL REVISED	BY
NO.	DATE	REVISED	

CLIENT :
佳明集團控股有限公司
GRAND MING GROUP HOLDINGS LIMITED

MAIN CONTRACTOR :
GRAND TECH CONSTRUCTION CO. LTD.

ARCHITECT :
WONG TUNG PARTNERS LIMITED
ARCHITECTS & PLANNERS


STRUCTURAL ENGINEER :
C M WONG & ASSOCIATES LTD

美特鋁質有限公司
MIDI ALUMINIUM FABRICATOR LTD.
Units 6-8, Sunray Industrial Centre, 1/F
610 Cha Kwo Ling Road, Kowloon
Tel: 23489211-4 Fax: (852) 2772666


PROJECT :
RESIDENTIAL DEVELOPMENT AT
TSING YI TOWN LOT 190 SAI SHAN ROAD

TITLE :
PARTIAL PLAN & PARTIAL ELEVATION OF
ALUM. CLADDING AT T1 1/F-35/F


JOB NO. :	J851
DRAWN BY : DL	DATE : 18-11-2019
CHKD BY :	SCALE A1: 1 : 50
DWG. NO. : J851-ACF-PE03	REV. : A

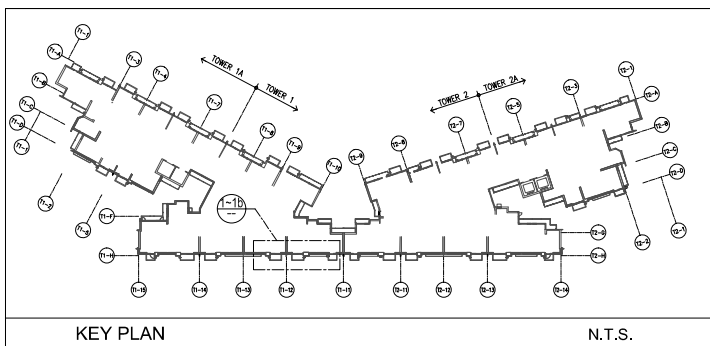


LEGEND		NOTICES	
[Pattern]	DARK GREY ALUMINIUM CLADDING (3mm THK.) w/ DARK GREY SEALANT	AL01	
[Pattern]	WHITE ALUMINIUM CLADDING (3mm THK.) w/ WHITE SEALANT	AL02	
[Pattern]	SANDY BROWN ALUMINIUM CLADDING (3mm THK.) w/ WHITE SEALANT	AL03	
[Pattern]	DARK GREY ALUMINIUM PANEL/ EXTRUSION (3mm THK.)	AF01	
[Pattern]	WHITE ALUMINIUM PANEL/ EXTRUSION (3mm THK.)	AF02	
[Pattern]	ALUMINIUM CLADDING LOCATION		

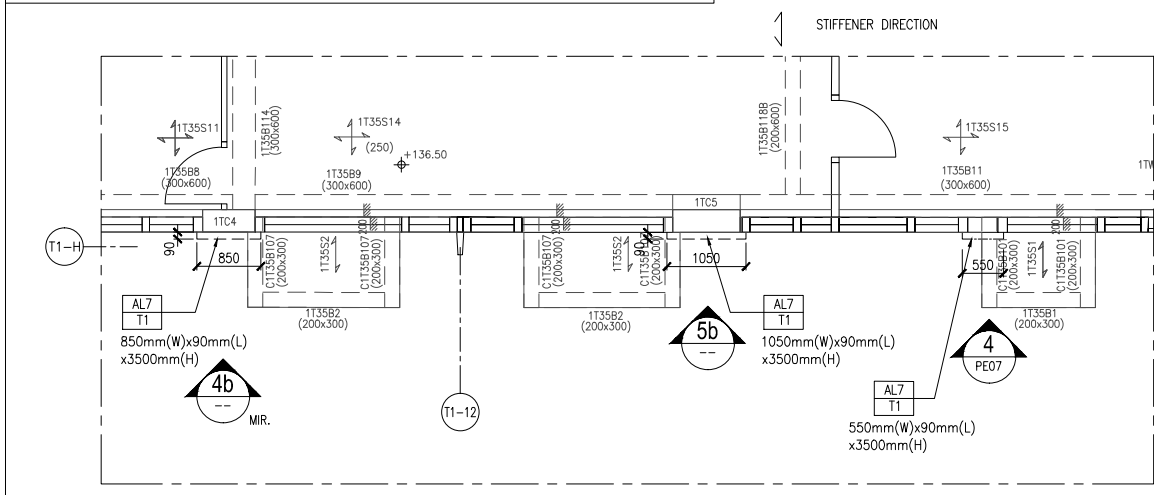


1b 'AL7' AT 33/F~35/F
PE04 LOCATION: FOR T1
SCALE: 1 : 50

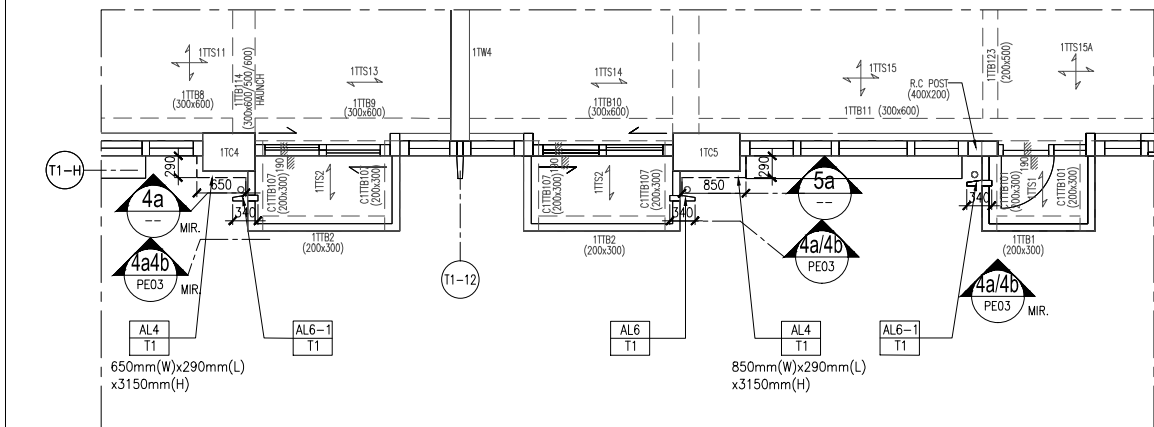


1a 'AL4', 'AL6' & 'AL6-1' AT 2/F~31/F
PE04 LOCATION: FOR T1
SCALE: 1 : 50

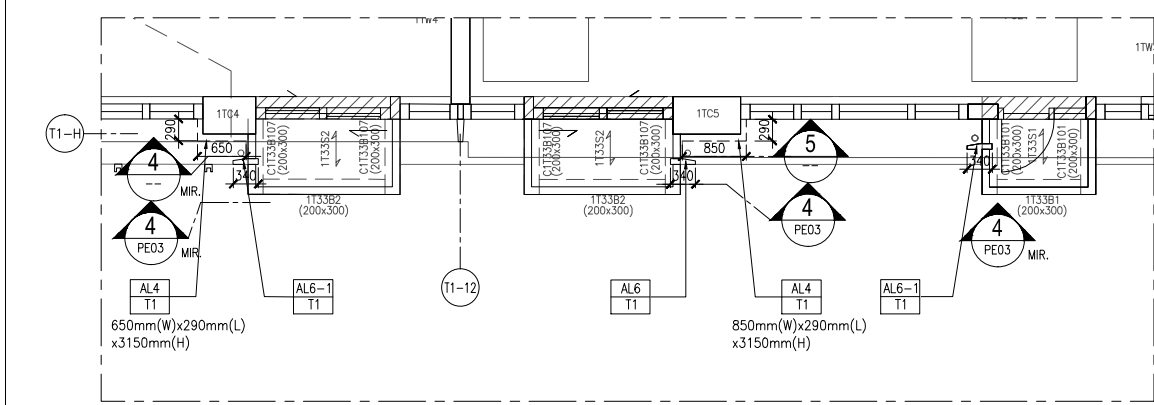


1 'AL4', 'AL6' & 'AL6-1' AT 1/F
PE04 LOCATION: FOR T1
SCALE: 1 : 50

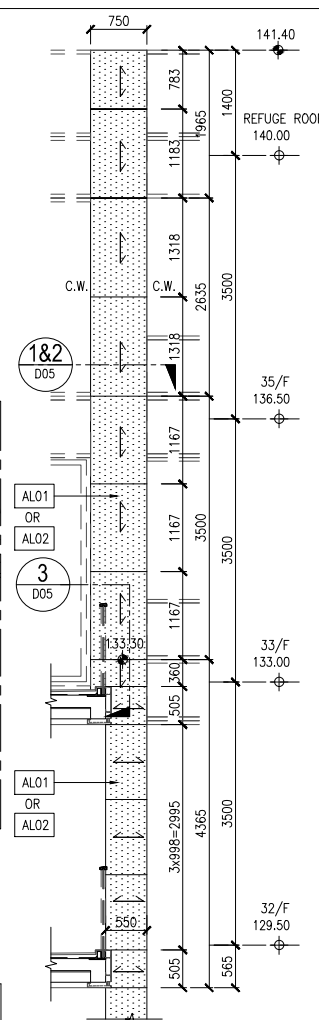


2b 'AL7' AT 32/F~35/F
PE04 LOCATION: REFER TO DWG PE03 (T1)
SCALE: 1 : 50

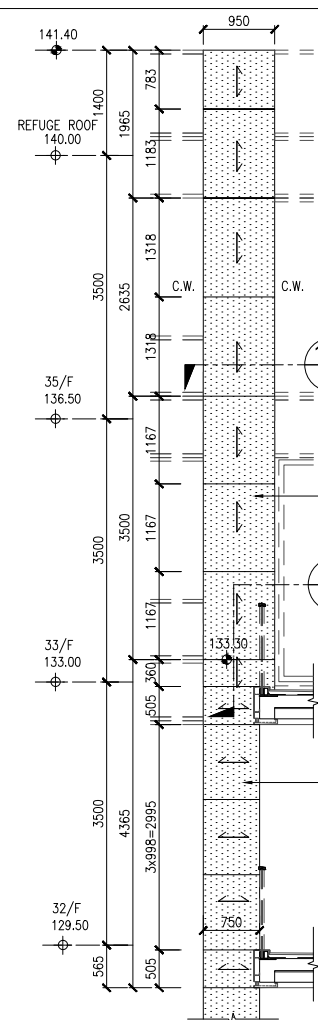


3b 'AL7' AT 32/F~35/F
PE04 LOCATION: REFER TO DWG PE03 (T1)
SCALE: 1 : 50

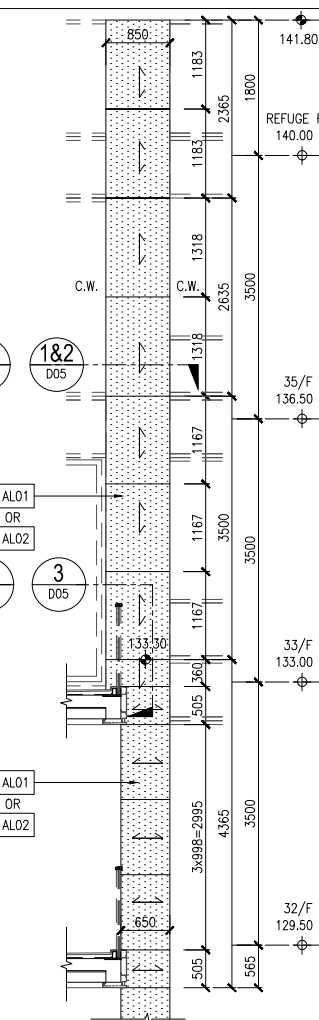


4b 'AL7' AT 32/F~35/F
PE04 LOCATION: FOR T1 & T2
SCALE: 1 : 50

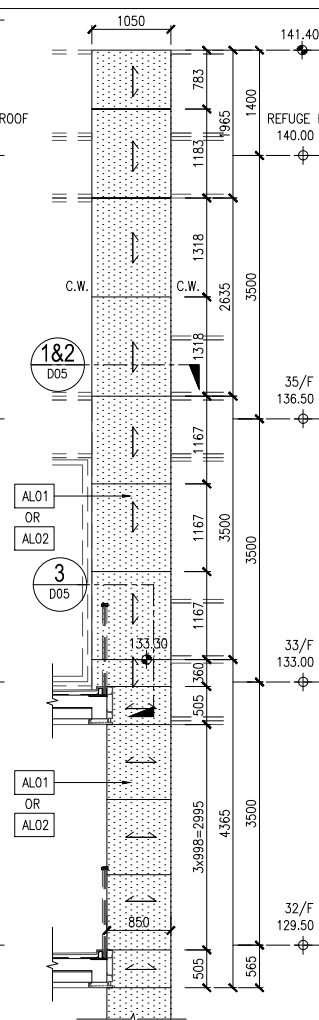


5b 'AL7' AT 32/F~35/F
PE04 LOCATION: FOR T1
SCALE: 1 : 50

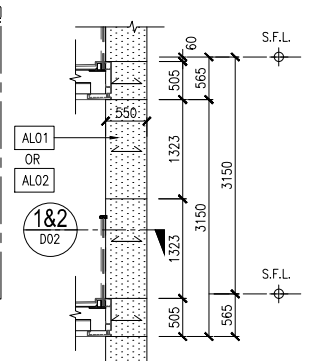


2a 'AL4' AT 2/F~31/F
PE04 LOCATION: REFER TO DWG PE03 (T1)
SCALE: 1 : 50

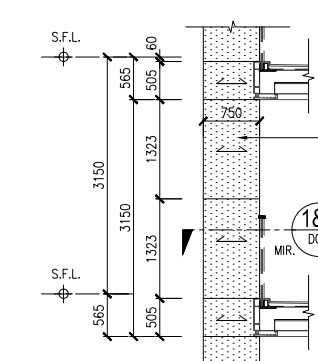


3a 'AL4' AT 2/F~31/F
PE04 LOCATION: REFER TO DWG PE03 (T1)
SCALE: 1 : 50

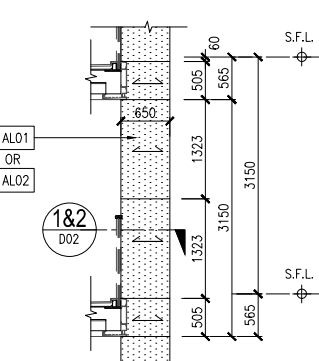


4a 'AL4' AT 2/F~31/F
PE04 LOCATION: FOR T1 & T2
SCALE: 1 : 50

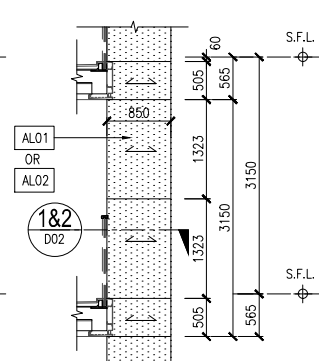


5a 'AL4' AT 2/F~31/F
PE04 LOCATION: FOR T1
SCALE: 1 : 50

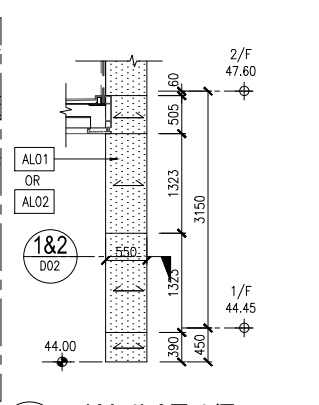


2 'AL4' AT 1/F
PE04 LOCATION: REFER TO DWG PE03 (T1)
SCALE: 1 : 50

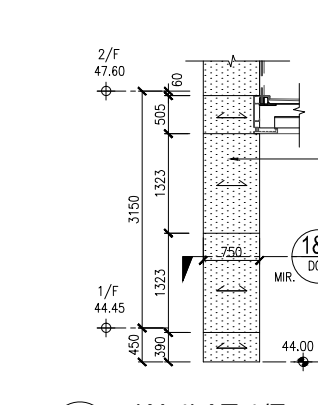

3 'AL4' AT 1/F
PE04 LOCATION: REFER TO DWG PE03 (T1)
SCALE: 1 : 50

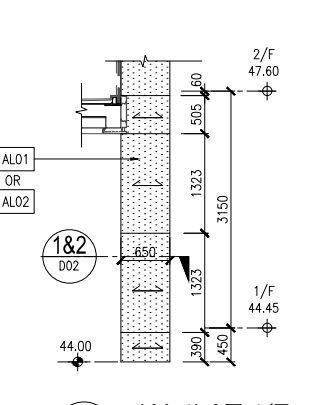

4 'AL4' AT 1/F
PE04 LOCATION: FOR T1 & T2
SCALE: 1 : 50

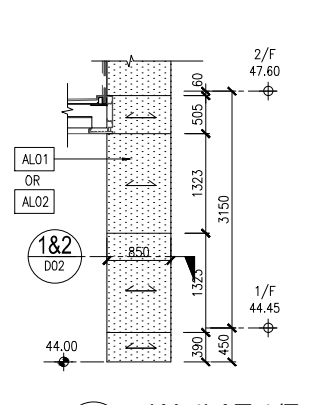

5 'AL4' AT 1/F
PE04 LOCATION: FOR T1
SCALE: 1 : 50

F.S.D. REF :

Note :

- All dimensions are in mm.
- All elevations are viewed from outside.
- All dimensions to be verified on site before fabrication.

GENERAL NOTES

Legend :

- F.F.L. --- Finished Floor Level
- S.F.L. --- Structural Floor Level
- (/R) --- Reversed Detail
- MIR. --- Mirror

X1 --- DETAIL MARK NO.
X001 --- REFER SHEET NO.

STRUCTURAL & FINISH FLOOR LEVEL FOR T1, T2, 1/F~32/F (LOW, HIGH ZONE) (4TH, 13TH, 14TH, 24TH FLOOR OMITTED)

FLOOR	S.F.L.	F.F.L.
1/F	+ 44.45	+ 44.50
2/F	+ 47.60	+ 47.65
3/F	+ 50.75	+ 50.80
5/F	+ 53.90	+ 53.95
6/F	+ 57.05	+ 57.10
7/F	+ 60.20	+ 60.25
8/F	+ 63.35	+ 63.40
9/F	+ 66.50	+ 66.55
10/F	+ 69.65	+ 69.70
11/F	+ 72.80	+ 72.85
12/F	+ 75.95	+ 76.00
15/F	+ 79.10	+ 79.15
16/F	+ 82.25	+ 82.30
17/F	+ 85.40	+ 85.45
18/F	+ 88.55	+ 88.60
19/F	+ 91.70	+ 91.75
20/F	+ 94.85	+ 94.90
21/F	+ 98.00	+ 98.05
22/F	+ 101.15	+ 101.20
23/F	+ 104.30	+ 104.35
25/F	+ 107.45	+ 107.50
26/F	+ 110.60	+ 110.65
27/F	+ 113.75	+ 113.80
28/F	+ 116.90	+ 116.95
29/F	+ 120.05	+ 120.10
30/F	+ 123.20	+ 123.25
31/F	+ 126.35	+ 126.40
32/F	+ 129.50	+ 129.55
33/F	+ 133.00	+ 133.05
35/F	+ 136.50	+ 136.55
R/F	+ 140.00	+ 140.05

A	14/04/2020	GENERAL REVISED
NO.	DATE	REVISED
		BY

CLIENT :

佳明集團控股有限公司
GRAND MING GROUP HOLDINGS LIMITED

MAIN CONTRACTOR :

GRAND TECH CONSTRUCTION CO. LTD.

ARCHITECT :

WONG TUNG PARTNERS LIMITED
ARCHITECTS & PLANNERS

STRUCTURAL ENGINEER :

C M WONG & ASSOCIATES LTD

美特鋁質有限公司
MIDI ALUMINIUM FABRICATOR LTD.

Units 6-8, Sunray Industrial Centre, 1/F
610 Cha Kwo Ling Road, Kowloon
Tel: 23489211-4 Fax: (852) 2727666


PROJECT :

RESIDENTIAL DEVELOPMENT AT TSING YI TOWN LOT 190 SAI SHAN ROAD

TITLE :


PARTIAL PLAN & PARTIAL ELEVATION OF ALUM. CLADDING AT T1 1/F~35/F

JOB NO. :	J851
DRAWN BY :	DL
DATE :	18-11-2019
CHKD BY :	SCALE A1: 1 : 50
DWG. NO. :	J851-ACF-PE04
REV. :	A

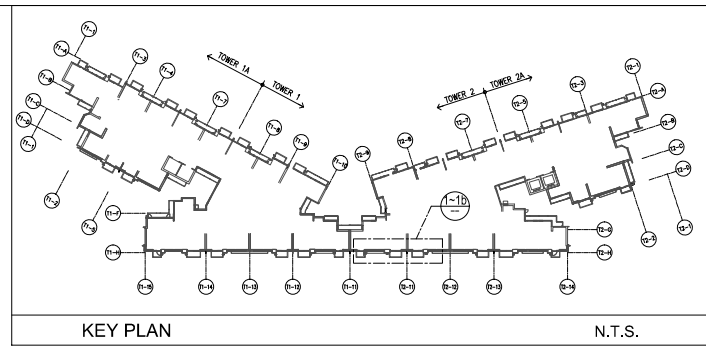


LEGEND		NOTICES	
[Pattern]	DARK GREY ALUMINIUM CLADDING (3mm THK.) w/ DARK GREY SEALANT	AL01	
[Pattern]	WHITE ALUMINIUM CLADDING (3mm THK.) w/ WHITE SEALANT	AL02	
[Pattern]	SANDY BROWN ALUMINIUM CLADDING (3mm THK.) w/ WHITE SEALANT	AL03	
[Pattern]	DARK GREY ALUMINIUM PANEL/ EXTRUSION (3mm THK.)	AF01	
[Pattern]	WHITE ALUMINIUM PANEL/ EXTRUSION (3mm THK.)	AF02	
[Pattern]	ALUMINIUM CLADDING LOCATION		


SYMBOL:
 CW CURTAIN WALL BY SEPARATE SUBMISSION
 STIFFENER DIRECTION

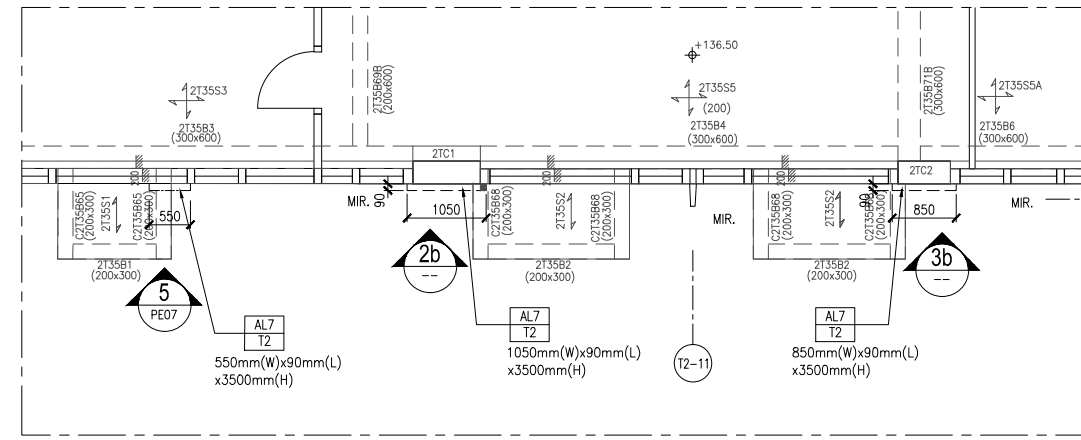


1b 'AL7' AT 33/F~35/F
 LOCATION: FOR T2
 SCALE: 1 : 50

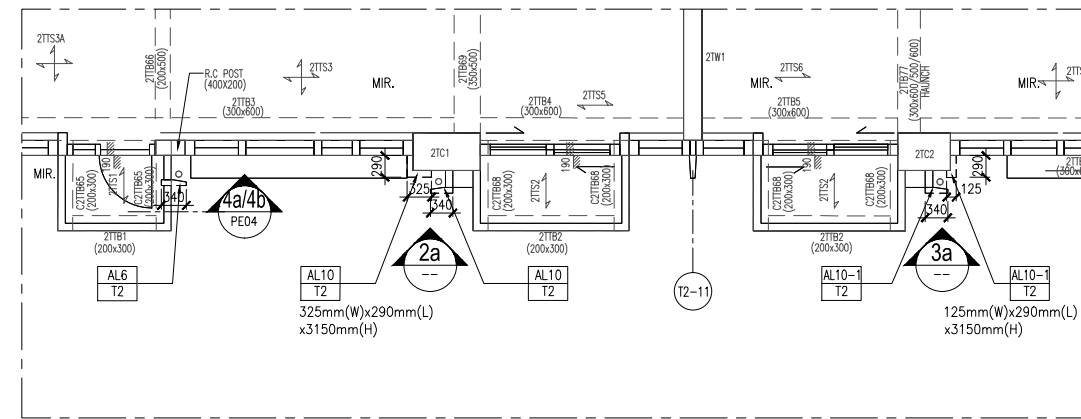


1a 'AL6', 'AL10' & 'AL10-1' AT 2/F~32/F
 LOCATION: FOR T2
 SCALE: 1 : 50

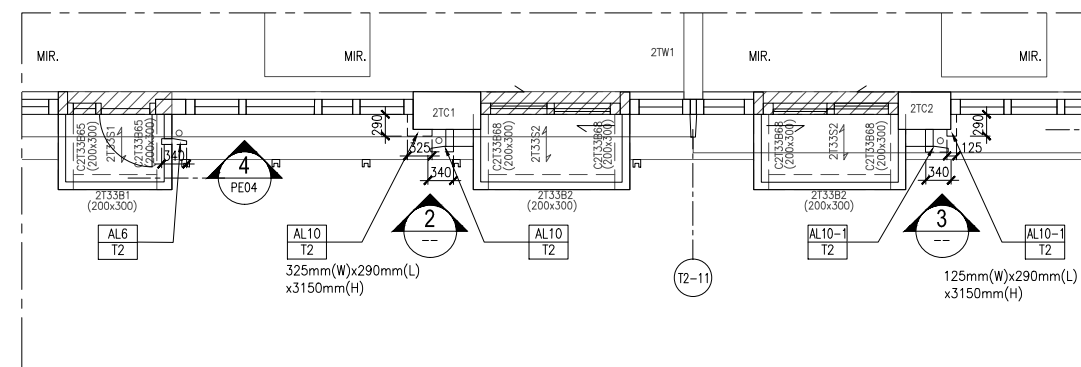


1 'AL6', 'AL10' & 'AL10-1' AT 1/F
 LOCATION: FOR T2
 SCALE: 1 : 50

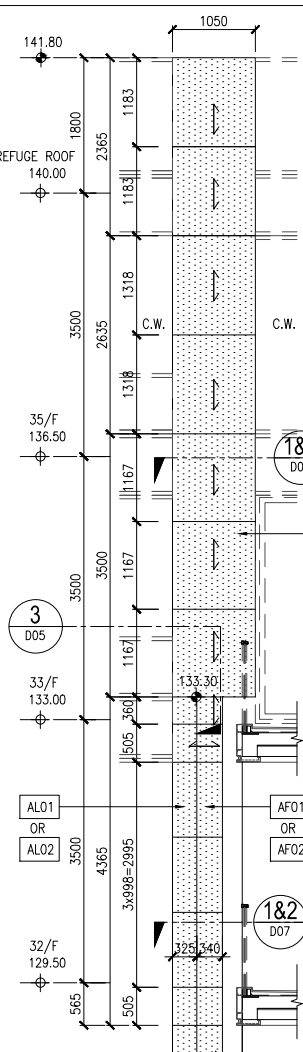


2b 'AL7' AT 33/F~35/F
 LOCATION: FOR T2
 SCALE: 1 : 50

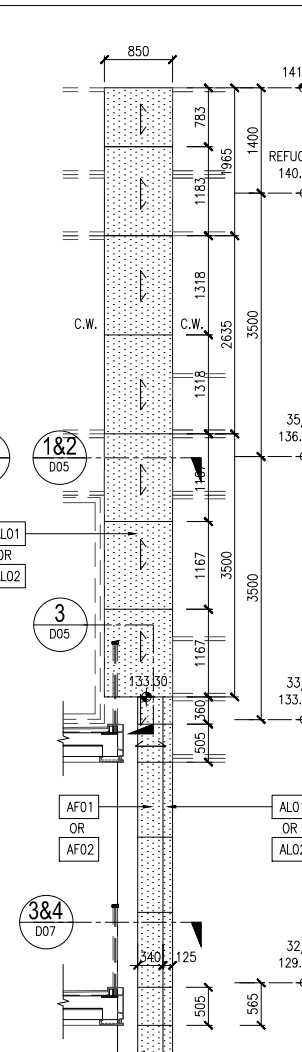


3b 'AL7' AT 33/F~35/F
 LOCATION: FOR T2
 SCALE: 1 : 50

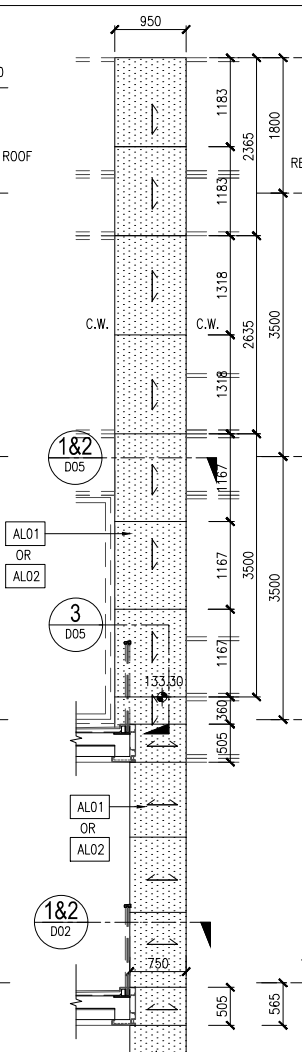


4b 'AL7' AT 33/F~35/F
 LOCATION: REFER TO DWG PE06 (T2)
 SCALE: 1 : 50

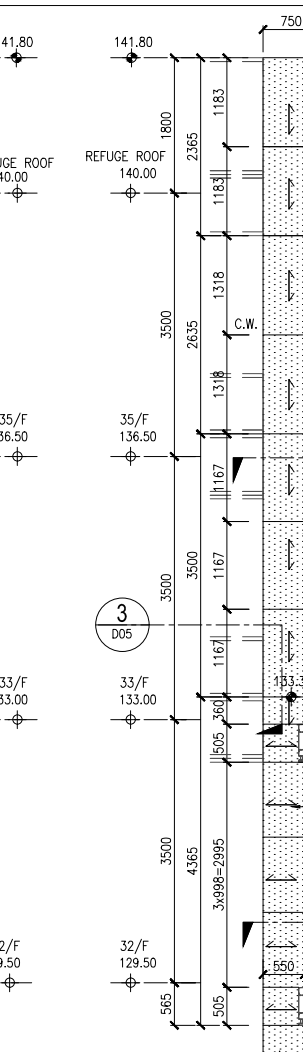


5b 'AL7' AT 33/F~35/F
 LOCATION: REFER TO DWG PE06 (T2)
 SCALE: 1 : 50

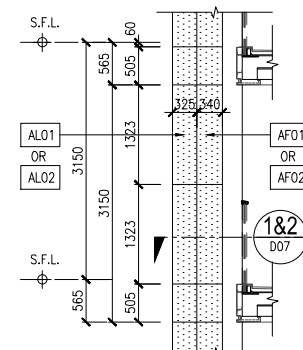


2a 'AL10' AT 2/F~32/F
 LOCATION: FOR T2
 SCALE: 1 : 50

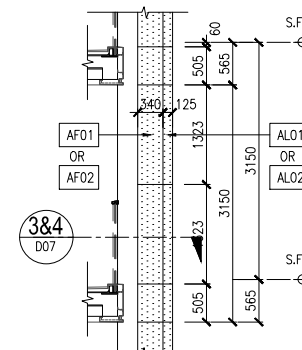


3a 'AL10-1' AT 2/F~32/F
 LOCATION: FOR T2
 SCALE: 1 : 50

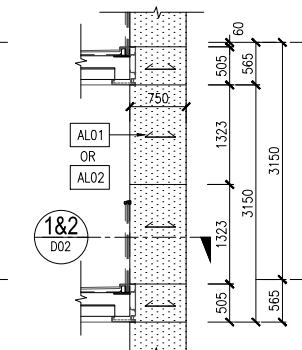


4a 'AL4' AT 2/F~32/F
 LOCATION: REFER TO DWG PE06 (T2)
 SCALE: 1 : 50

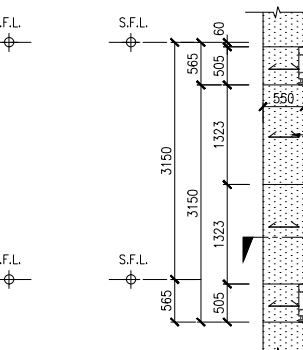


5a 'AL4' AT 2/F~32/F
 LOCATION: REFER TO DWG PE06 (T2)
 SCALE: 1 : 50

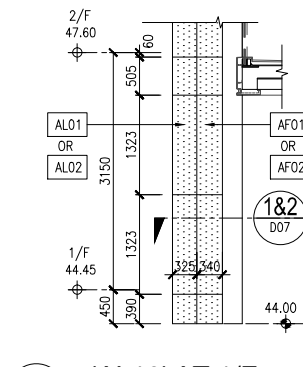


2 'AL10' AT 1/F
 LOCATION: FOR T2
 SCALE: 1 : 50

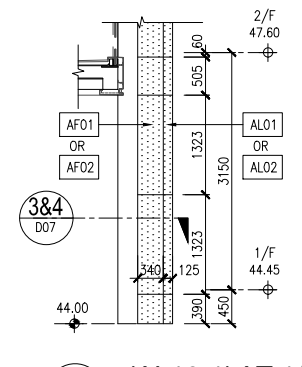

3 'AL10-1' AT 1/F
 LOCATION: FOR T2
 SCALE: 1 : 50

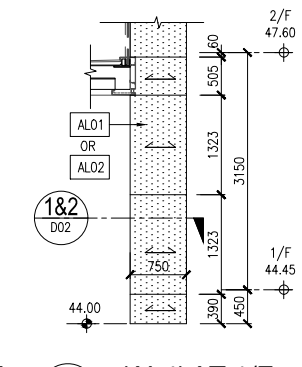

4 'AL4' AT 1/F
 LOCATION: REFER TO DWG PE06 (T2)
 SCALE: 1 : 50

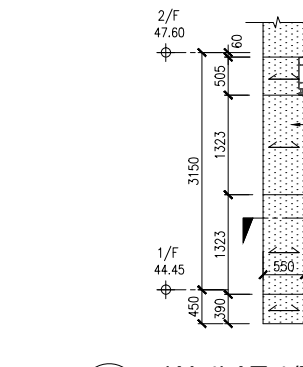

5 'AL4' AT 1/F
 LOCATION: REFER TO DWG PE06 (T2)
 SCALE: 1 : 50

F.S.D. REF :
 Note :
 1. All dimensions are in mm.
 2. All elevations are viewed from outside.
 3. All dimensions to be verified on site before fabrication.

GENERAL NOTES
Legend :
 1. F.F.L. --- Finished Floor Level
 2. S.F.L. --- Structural Floor Level
 3. (R) --- Reversed Detail
 4. MIR. --- Mirror

X1 --- DETAIL MARK NO.
 X001 --- REFER SHEET NO.

STRUCTURAL & FINISH FLOOR LEVEL FOR T1, T2, 1/F~32/F (LOW, HIGH ZONE) (4TH, 13TH, 14TH, 24TH FLOOR OMITTED)		
FLOOR	S.F.L.	F.F.L.
1/F	+ 44.45	+ 44.50
2/F	+ 47.60	+ 47.65
3/F	+ 50.75	+ 50.80
5/F	+ 53.90	+ 53.95
6/F	+ 57.05	+ 57.10
7/F	+ 60.20	+ 60.25
8/F	+ 63.35	+ 63.40
9/F	+ 66.50	+ 66.55
10/F	+ 69.65	+ 69.70
11/F	+ 72.80	+ 72.85
12/F	+ 75.95	+ 76.00
15/F	+ 79.10	+ 79.15
16/F	+ 82.25	+ 82.30
17/F	+ 85.40	+ 85.45
18/F	+ 88.55	+ 88.60
19/F	+ 91.70	+ 91.75
20/F	+ 94.85	+ 94.90
21/F	+ 98.00	+ 98.05
22/F	+ 101.15	+ 101.20
23/F	+ 104.30	+ 104.35
25/F	+ 107.45	+ 107.50
26/F	+ 110.60	+ 110.65
27/F	+ 113.75	+ 113.80
28/F	+ 116.90	+ 116.95
29/F	+ 120.05	+ 120.10
30/F	+ 123.20	+ 123.25
31/F	+ 126.35	+ 126.40
32/F	+ 129.50	+ 129.55
33/F	+ 133.00	+ 133.05
35/F	+ 136.50	+ 136.55
R/F	+ 140.00	+ 140.05

A.	14/04/2020	GENERAL	REVISED	BY
NO.	DATE	REVISION		

CLIENT :
佳明集團控股有限公司
 GRAND MING GROUP HOLDINGS LIMITED

MAIN CONTRACTOR :
GRAND TECH CONSTRUCTION CO. LTD.

ARCHITECT :
WONG TUNG PARTNERS LIMITED
 ARCHITECTS & PLANNERS



STRUCTURAL ENGINEER :
C M WONG & ASSOCIATES LTD

美特鋁質有限公司
 MIDI ALUMINIUM FABRICATOR LTD.
 Units 6-8, Sunray Industrial Centre, 1/F
 610 Cha Kwo Ling Road, Kowloon
 Tel: 23489211-4 Fax: (852) 2772666

PROJECT :
 RESIDENTIAL DEVELOPMENT AT
 TSING YI TOWN LOT 190 SAI SHAN ROAD


TITLE :
 PARTIAL PLAN & PARTIAL ELEVATION OF
 ALUM. CLADDING AT T2 1/F~35/F

JOB NO. : J851
 DRAWN BY : DL DATE : 18-11-2019
 CHKD BY : SCALE A1: 1 : 50
 DWG. NO. : J851-ACF-PE05 REV. : A

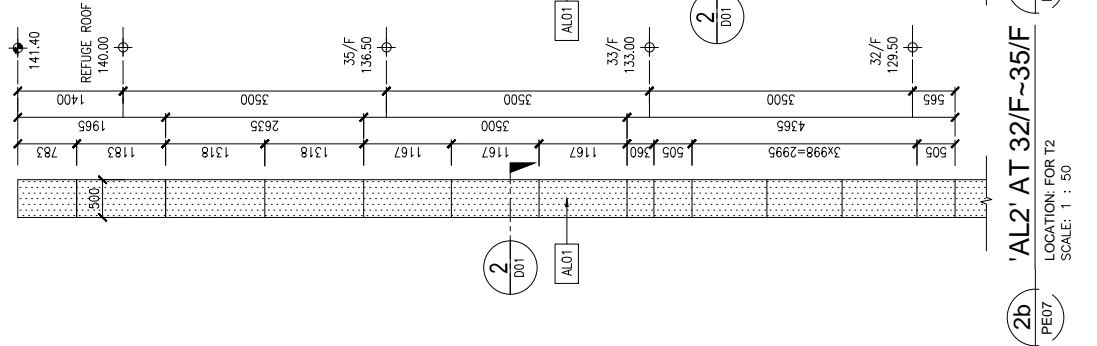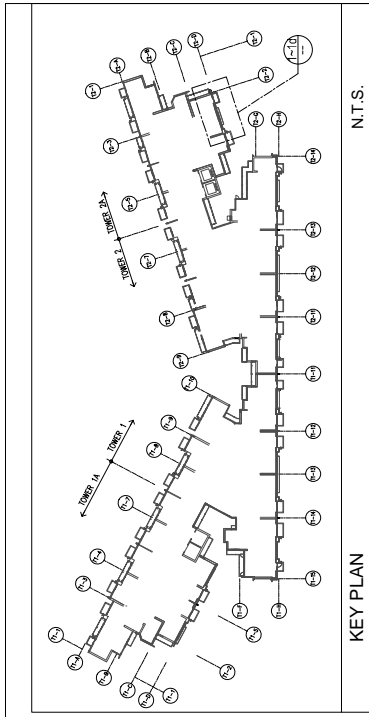


5 'AL7' AT 32/F~35/F
LOCATION: REFER TO DWG PE05 (T2)
SCALE: 1 : 50

4 'AL7' AT 32/F~35/F
LOCATION: REFER TO DWG PE04 (T1)
SCALE: 1 : 50

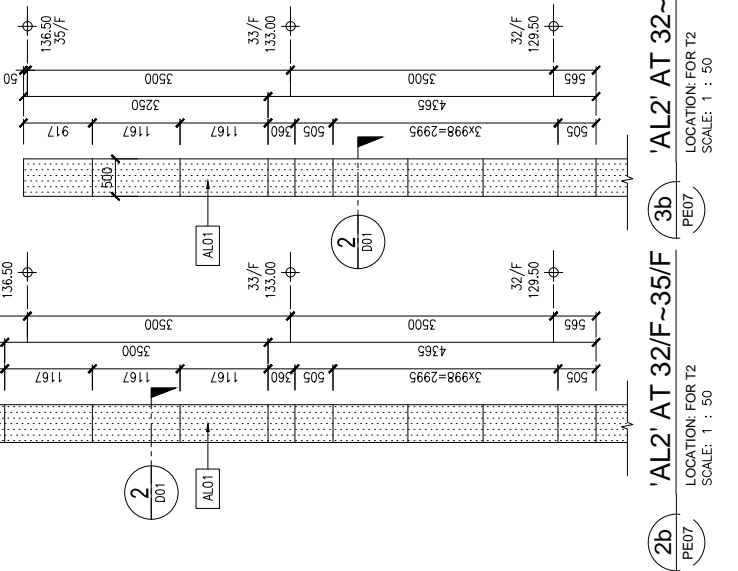


2b 'AL2' AT 32/F~35/F
LOCATION: FOR T2
SCALE: 1 : 50

3b 'AL2' AT 32-33/F
LOCATION: FOR T2
SCALE: 1 : 50

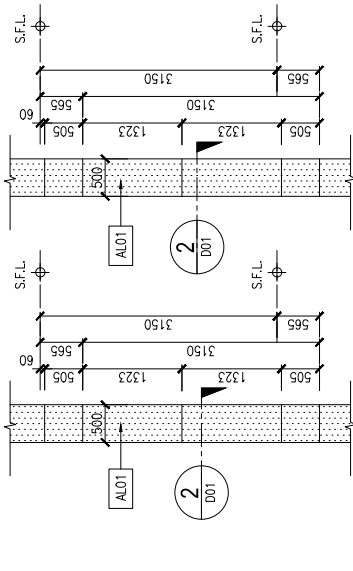


2a 'AL2' AT 2/F~31/F
LOCATION: FOR T2
SCALE: 1 : 50

3a 'AL2' AT 2/F~31/F
LOCATION: FOR T2
SCALE: 1 : 50

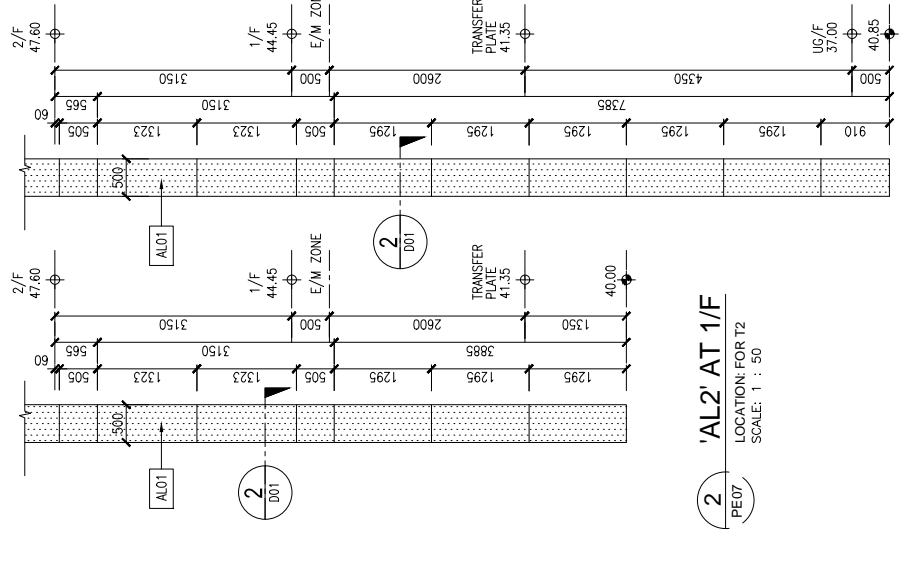


2 'AL2' AT 1/F
LOCATION: FOR T2
SCALE: 1 : 50


3 'AL2' AT 1/F
LOCATION: FOR T2
SCALE: 1 : 50

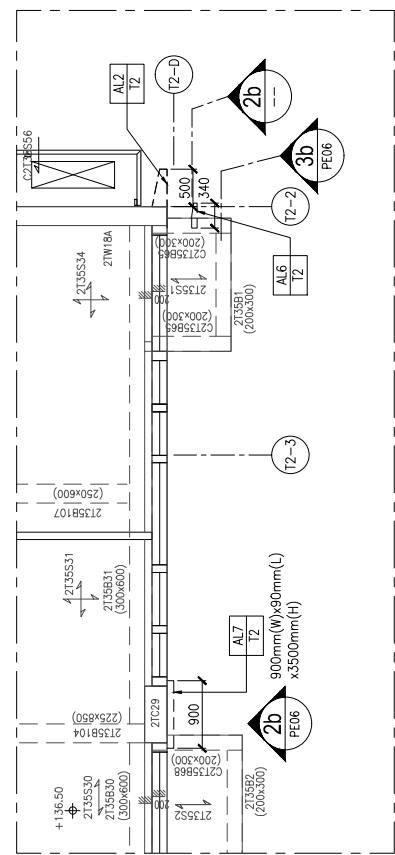


1c 'AL2' & 'AL7' AT 35/F
LOCATION: FOR T2
SCALE: 1 : 50

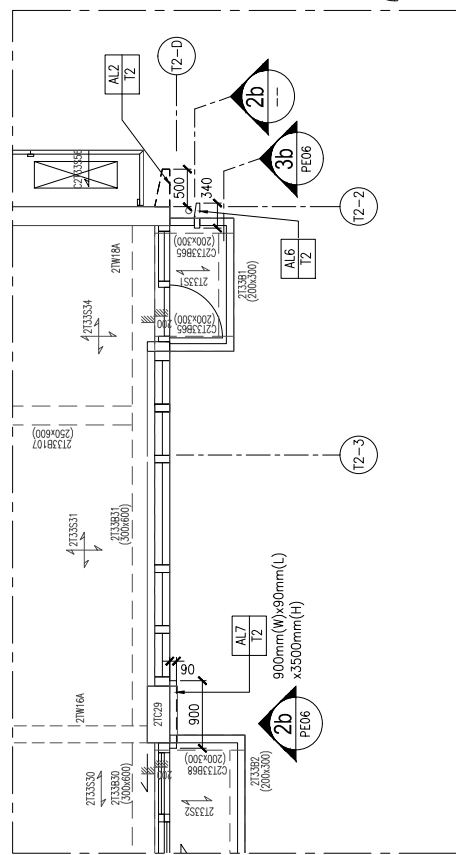

1b 'AL2', 'AL6' & 'AL7' AT 33/F
LOCATION: FOR T2
SCALE: 1 : 50

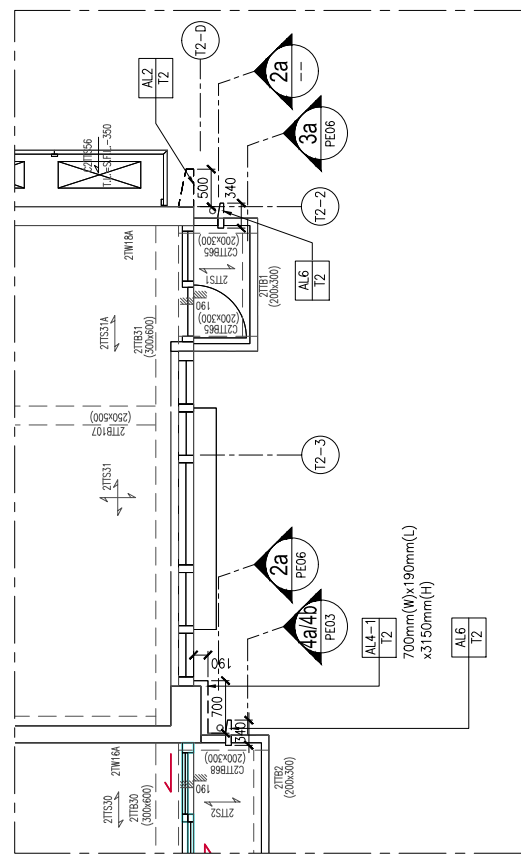

1a 'AL2', 'AL4-1' & 'AL6' AT 2/F~32/F
LOCATION: FOR T2
SCALE: 1 : 50

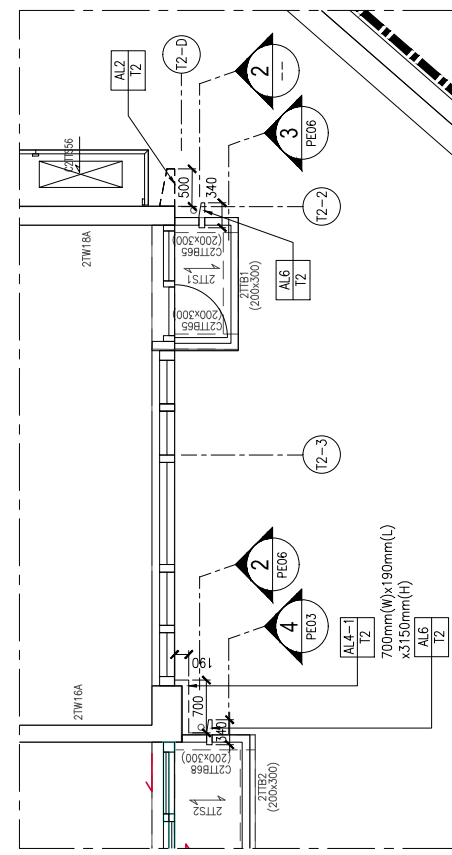

1 'AL2', 'AL4-1' & 'AL6' AT 1/F
LOCATION: FOR T2
SCALE: 1 : 50

LEGEND	NOTICES	AL01	AL02	AL03	AF01	AF02
	DARK GREY ALUMINIUM CLADDING (3mm THK.) w/ DARK GREY SEALANT					
	WHITE ALUMINIUM CLADDING (3mm THK.) w/ WHITE SEALANT					
	SANDY BROWN ALUMINIUM CLADDING (3mm THK.) w/ WHITE SEALANT					
	DARK GREY ALUMINIUM PANEL/ EXTRUSION (3mm THK.)					
	WHITE ALUMINIUM PANEL/ EXTRUSION (3mm THK.)					
	ALUMINIUM CLADDING LOCATION					

SYMBOL: CW CURTAIN WALL BY SEPARATE SUBMISSION

- F.S.D. REF :
1. All dimensions are in mm.
 2. All elevations are viewed from outside.
 3. All dimensions to be verified on site before fabrication.

GENERAL NOTES

Legend :

1. F.F.L. --- Finished Floor Level
2. S.F.L. --- Structural Floor Level
3. (R) --- Reversed Detail
4. MIR. --- Mirror

X1 --- DETAIL MARK NO.
X001 --- REFER SHEET NO.

STRUCTURAL & FINISH FLOOR LEVEL FOR T1, T2, 1/F~32/F (LOW, HIGH ZONE) (4TH, 13TH, 14TH, 24TH FLOOR OMITTED)

FLOOR	S.F.L.	F.F.L.
1/F	+ 44.45	+ 44.50
2/F	+ 47.60	+ 47.65
3/F	+ 50.75	+ 50.80
5/F	+ 53.90	+ 53.95
6/F	+ 57.05	+ 57.10
7/F	+ 60.20	+ 60.25
8/F	+ 63.35	+ 63.40
9/F	+ 66.50	+ 66.55
10/F	+ 69.65	+ 69.70
11/F	+ 72.80	+ 72.85
12/F	+ 75.95	+ 76.00
15/F	+ 79.10	+ 79.15
16/F	+ 82.25	+ 82.30
17/F	+ 85.40	+ 85.45
18/F	+ 88.55	+ 88.60
19/F	+ 91.70	+ 91.75
20/F	+ 94.85	+ 94.90
21/F	+ 98.00	+ 98.05
22/F	+ 101.15	+ 101.20
23/F	+ 104.30	+ 104.35
25/F	+ 107.45	+ 107.50
26/F	+ 110.60	+ 110.65
27/F	+ 113.75	+ 113.80
28/F	+ 116.90	+ 116.95
29/F	+ 120.05	+ 120.10
30/F	+ 123.20	+ 123.25
31/F	+ 126.35	+ 126.40
32/F	+ 129.50	+ 129.55
33/F	+ 132.65	+ 132.70
35/F	+ 135.80	+ 135.85
R/F	+ 140.00	+ 140.05

A	14/04/2020	GENERAL REVISED
NO.	DATE	REVISED BY

CLIENT :
佳明集團控股有限公司
GRAND MING GROUP HOLDINGS LIMITED

MAIN CONTRACTOR :
GRAND TECH CONSTRUCTION CO. LTD.

ARCHITECT :
WONG TUNG PARTNERS LIMITED
ARCHITECTS & PLANNERS

STRUCTURAL ENGINEER :
C M WONG & ASSOCIATES LTD

美特鋁質有限公司
MIDI ALUMINIUM FABRICATOR LTD.
Units 6-8, Sunray Industrial Centre, 1/F
610 Cha Kwo Ling Road, Kowloon
Tel:23489211-4 Fax:(852)27727666

PROJECT :
RESIDENTIAL DEVELOPMENT AT TSING YI TOWN LOT 190 SAI SHAN ROAD

TITLE :
PARTIAL PLAN & PLAN ELEVATION OF ALUM. CLADDING AT T2 1/F~35/F

JOB NO. : J851

DRAWN BY : DL DATE : 18-11-2019

CHKD BY : SCALE A1: 1 : 50

DWG. NO. : J851-ACF-PE07 REV. : A

LEGEND	NOTICES
[Pattern]	AL01
[Pattern]	AL02
[Pattern]	AL03
[Pattern]	AF01
[Pattern]	AF02
[Pattern]	ALUMINIUM CLADDING LOCATION

NOTICES

DARK GREY ALUMINIUM CLADDING (3mm THK.)
w/ DARK GREY SEALANT (3mm THK.)


WHITE ALUMINIUM CLADDING (3mm THK.)
w/ WHITE SEALANT (3mm THK.)

SANDY BROWN ALUMINIUM CLADDING (3mm THK.)
w/ WHITE SEALANT (3mm THK.)


DARK GREY ALUMINIUM PANEL/ EXTRUSION (3mm THK.)

WHITE ALUMINIUM PANEL/ EXTRUSION (3mm THK.)


ALUMINIUM CLADDING LOCATION

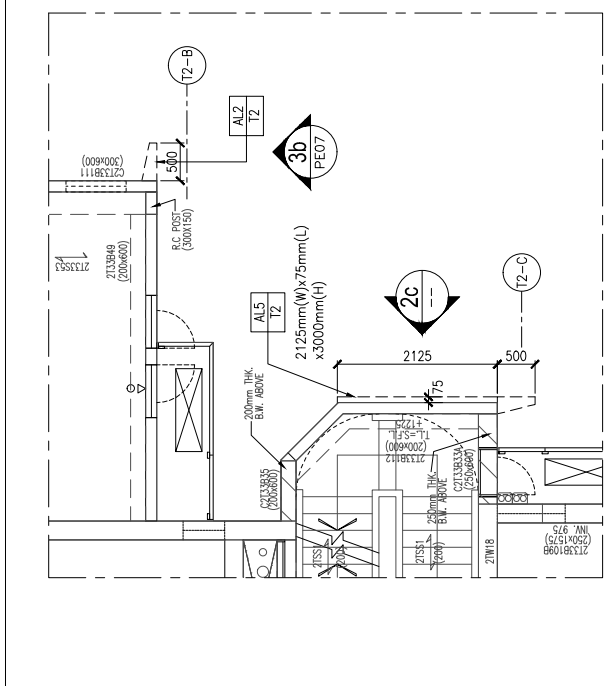


1c 'AL2' & 'AL5' AT 33/F
LOCATION: FOR T2
SCALE: 1 : 50

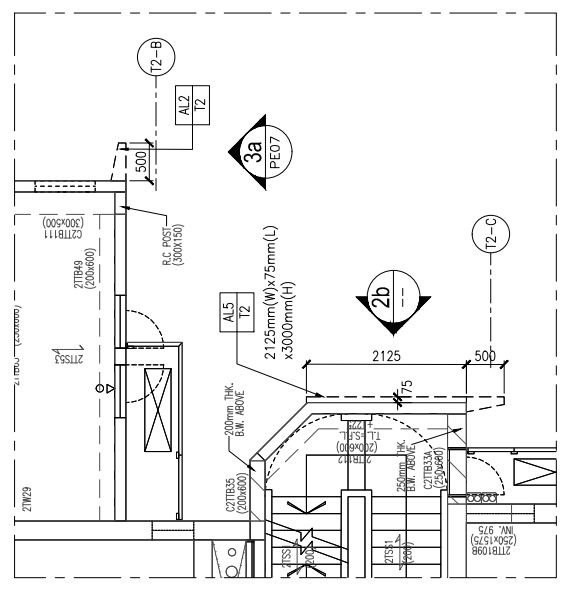


1b 'AL2' & 'AL5' 2/F-32/F
LOCATION: FOR T2
SCALE: 1 : 50

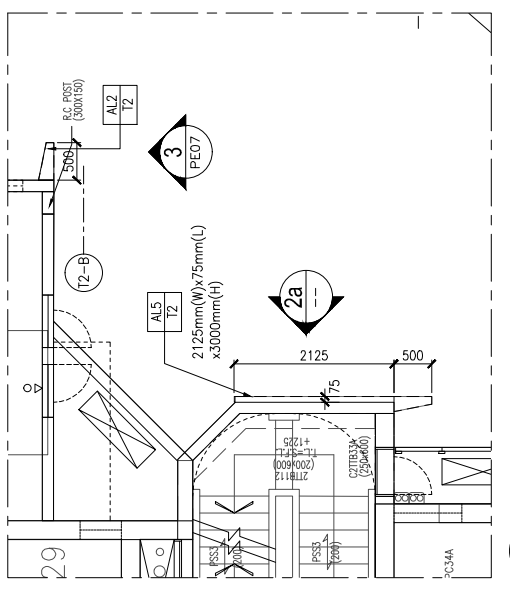


1a 'AL2' & 'AL5' AT 1/F
LOCATION: FOR T2
SCALE: 1 : 50

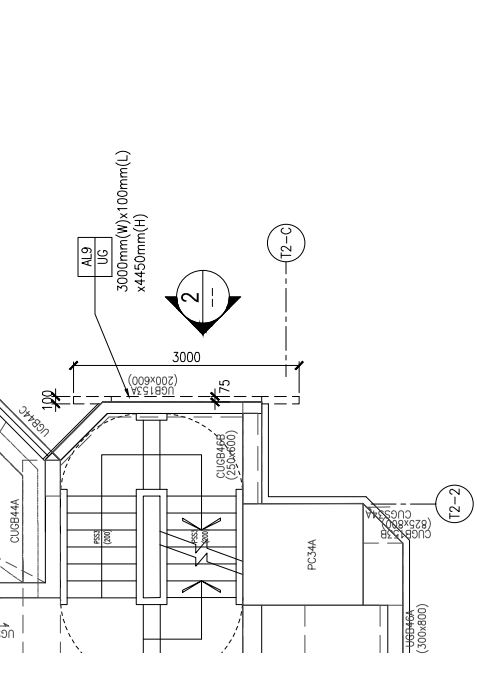


1 'AL9' AT UG/F
LOCATION: FOR T2
SCALE: 1 : 50

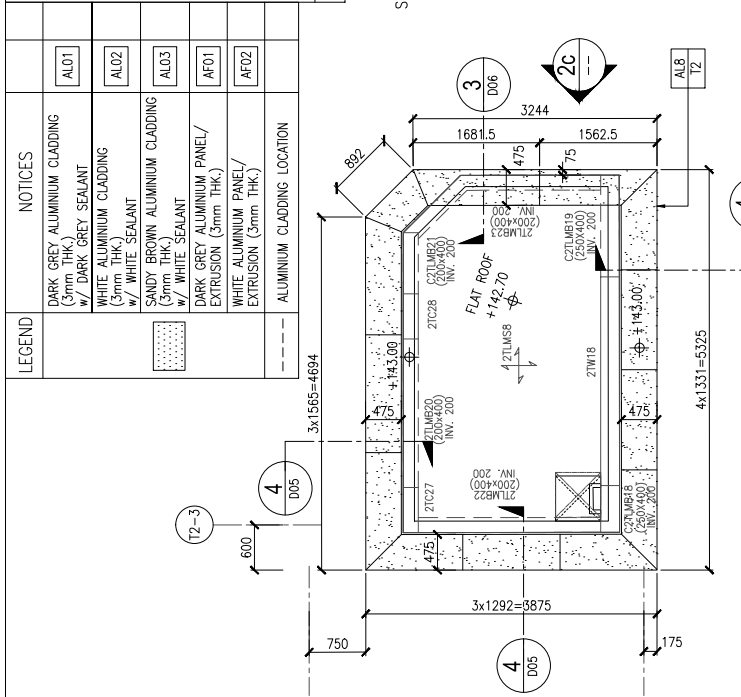


4 'AL8' AT TOP ROOF
LOCATION: FOR T2
SCALE: 1 : 50

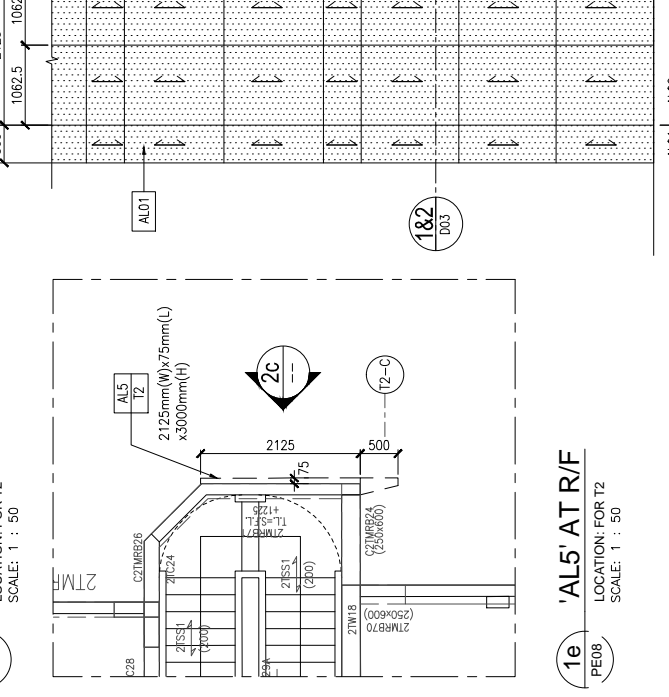


1f 'AL5' AT R/F
LOCATION: FOR T2
SCALE: 1 : 50

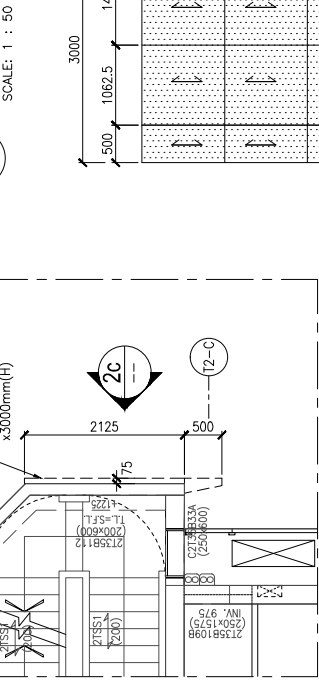


1e 'AL5' AT R/F
LOCATION: FOR T2
SCALE: 1 : 50

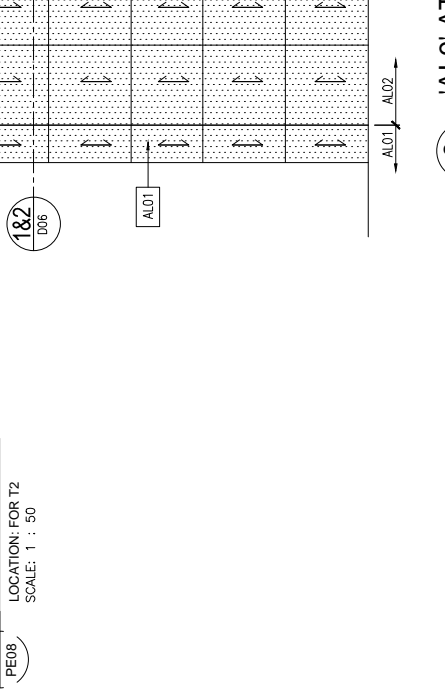


1d 'AL5' AT 35/F
LOCATION: FOR T2
SCALE: 1 : 50

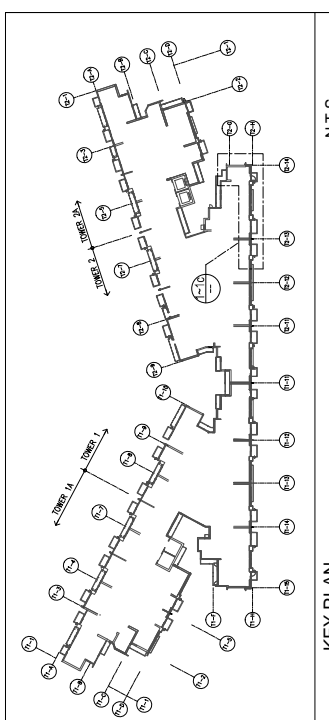

KEY PLAN
N.T.S.

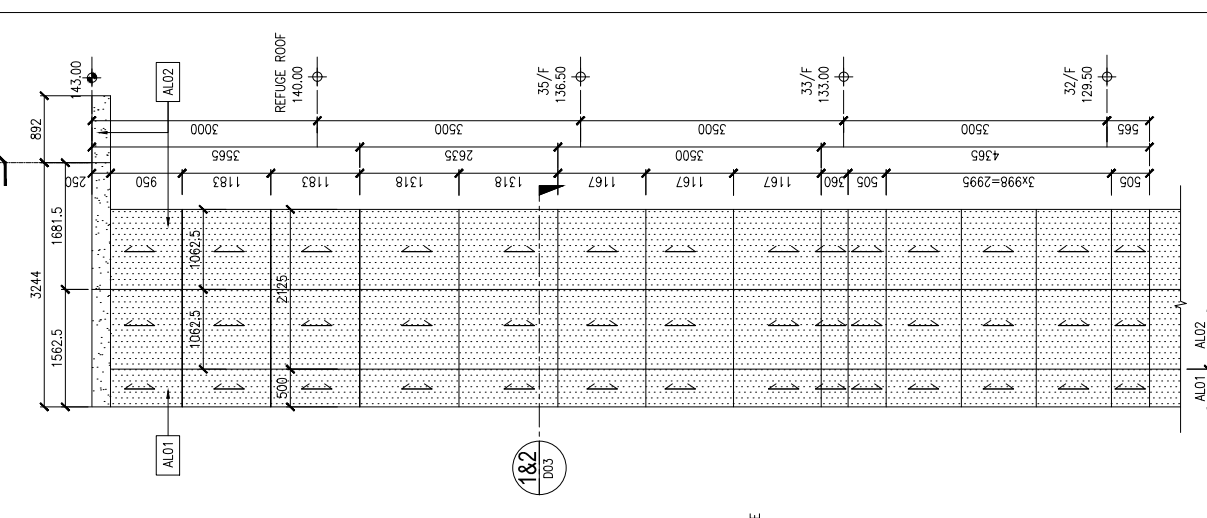

2c 'AL5' AT 32-35/F
LOCATION: FOR T2
SCALE: 1 : 50

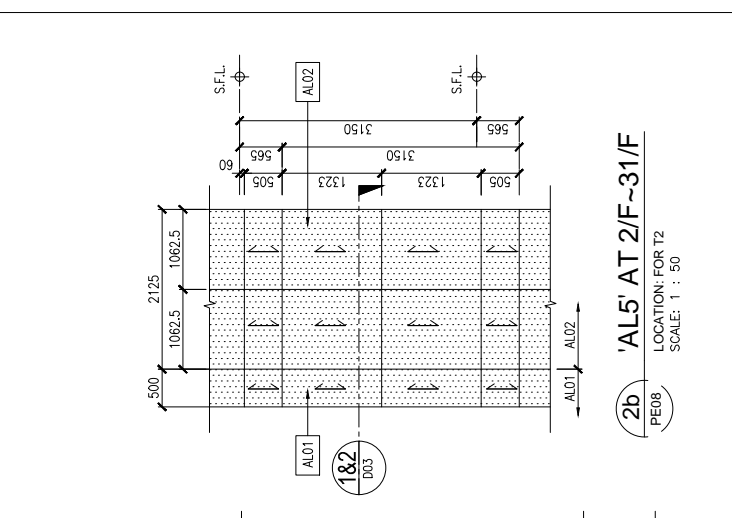

2b 'AL5' AT 2/F-31/F
LOCATION: FOR T2
SCALE: 1 : 50

F.S.D. REF :

Note :

- All dimensions are in mm.
- All elevations are viewed from outside.
- All dimensions to be verified on site before fabrication.

GENERAL NOTES

Legend :

- F.F.L. -- Finished Floor Level
- S.F.L. -- Structural Floor Level
- (R) -- Reversed Detail
- MIR -- Mirror

X1 -- DETAIL MARK NO.
X001 -- REFER SHEET NO.

STRUCTURAL & FINISH FLOOR LEVEL FOR T1 & T2, 1/F-32/F (LOW, HIGH ZONE)

FLOOR	S.F.L.	F.F.L.
LG/F	+ 32.45	+ 32.50
UG/F	+ 37.00	+ 37.05
1/F	+ 44.45	+ 44.50
2/F	+ 47.60	+ 47.65
3/F	+ 50.75	+ 50.80
5/F	+ 53.90	+ 53.95
6/F	+ 57.05	+ 57.10
7/F	+ 60.20	+ 60.25
8/F	+ 63.35	+ 63.40
9/F	+ 66.50	+ 66.55
10/F	+ 69.65	+ 69.70
11/F	+ 72.80	+ 72.85
12/F	+ 75.95	+ 76.00
15/F	+ 79.10	+ 79.15
16/F	+ 82.25	+ 82.30
17/F	+ 85.40	+ 85.45
18/F	+ 88.55	+ 88.60
19/F	+ 91.70	+ 91.75
20/F	+ 94.85	+ 94.90
21/F	+ 98.00	+ 98.05
22/F	+ 101.15	+ 101.20
23/F	+ 104.30	+ 104.35
25/F	+ 107.45	+ 107.50
26/F	+ 110.60	+ 110.65
27/F	+ 113.75	+ 113.80
28/F	+ 116.90	+ 116.95
29/F	+ 120.05	+ 120.10
30/F	+ 123.20	+ 123.25
31/F	+ 126.35	+ 126.40
32/F	+ 129.50	+ 129.55
33/F	+ 133.00	+ 133.05
35/F	+ 136.50	+ 136.55
R/F	+ 140.00	+ 140.05

A	14/04/2020	GENERAL REVISED
NO.	DATE	REVISED
		BY

CLIENT :

佳明集團控股有限公司
GRAND MING GROUP HOLDINGS LIMITED

MAIN CONTRACTOR :

GRAND TECH CONSTRUCTION CO. LTD.

ARCHITECT :

WONG TUNG & PARTNERS LIMITED
ARCHITECTS & PLANNERS

STRUCTURAL ENGINEER :

C M WONG & ASSOCIATES LTD

美特鋁質有限公司
MIDI ALUMINIUM FABRICATOR LTD.

Units 6-8, Sunray Industrial Centre, 1/F
610 Cho Kwo Ling Road, Kowloon
Tel: 23489211-4 Fax: (852) 2772666

PROJECT :

RESIDENTIAL DEVELOPMENT AT TSING YI TOWN LOT 190 SAI SHAN ROAD

TITLE :


PARTIAL PLAN & PARTIAL ELEVATION OF ALUM. CLADDING AT T2 1/F-35/F

JOB NO. : J851

DRAWN BY : DL DATE : 18-11-2019

CHKD BY : SCALE A1: 1 : 50


DWG. NO. : J851-ACF-PE08 REV. : A

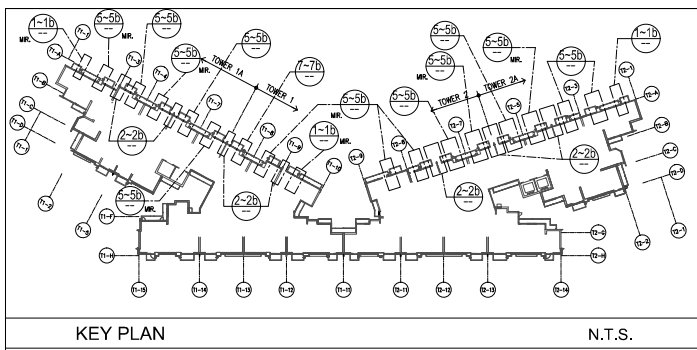

LEGEND		NOTICES	
	DARK GREY ALUMINIUM CLADDING (3mm THK.) w/ DARK GREY SEALANT	AL01	
	WHITE ALUMINIUM CLADDING (3mm THK.) w/ WHITE SEALANT	AL02	
	SANDY BROWN ALUMINIUM CLADDING (3mm THK.) w/ WHITE SEALANT	AL03	
	DARK GREY ALUMINIUM PANEL/ EXTRUSION (3mm THK.)	AF01	
	WHITE ALUMINIUM PANEL/ EXTRUSION (3mm THK.)	AF02	
	ALUMINIUM CLADDING LOCATION		


KEY PLAN

N.T.S.

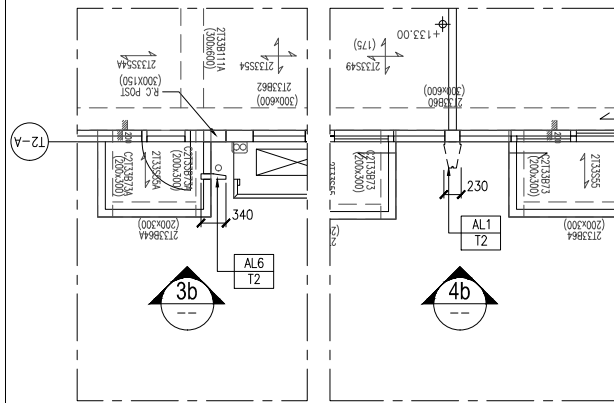


1b 'AL6'
PE09 LOCATION: FOR T1 & T2
SCALE: 1 : 50
AT 32/F~33/F


2b 'AL1'
PE09 LOCATION: FOR T1 & T2
SCALE: 1 : 50
AT 32/F~33/F

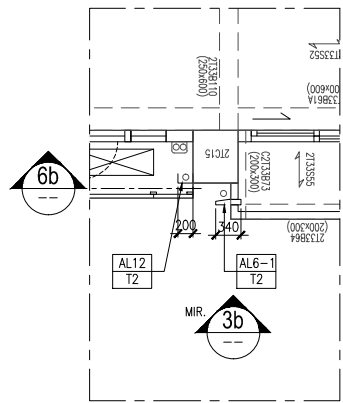

5b 'AL6-1' & 'AL12'
PE09 LOCATION: FOR T1 & T2
SCALE: 1 : 50
AT 32/F~33/F

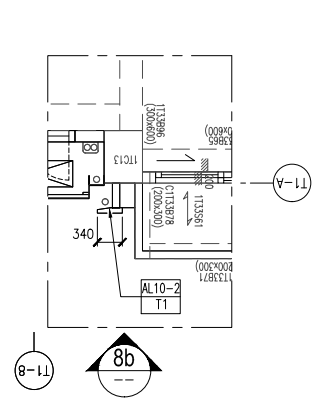


7b 'AL10-2'
PE09 LOCATION: FOR T1
SCALE: 1 : 50
AT 32/F~33/F

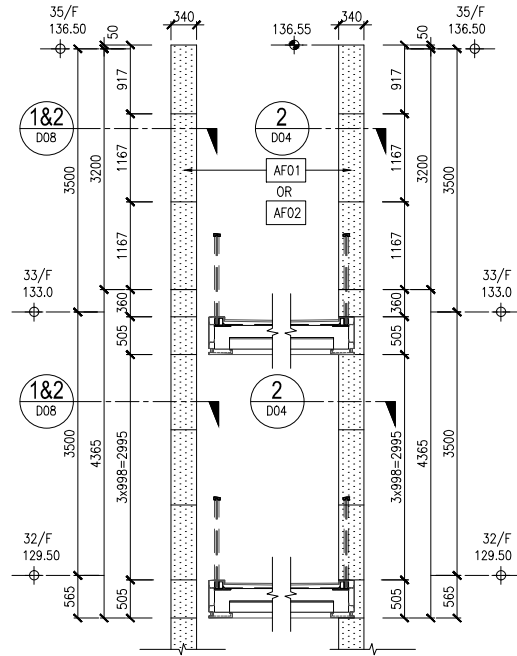


8b 'AL10-2'
PE09 LOCATION: FOR T1
SCALE: 1 : 50
AT 32/F~33/F


3b 'AL6-1'
PE09 LOCATION: FOR T1 & T2
SCALE: 1 : 50
AT 32/F~33/F

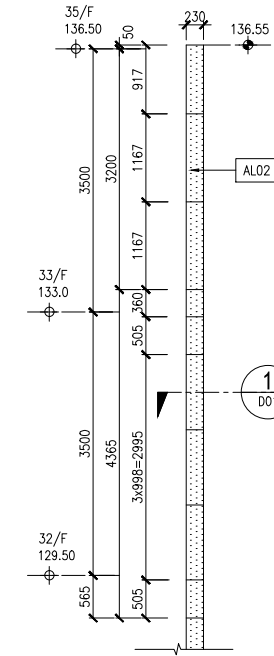

4b 'AL1'
PE09 LOCATION: FOR T1 & T2
SCALE: 1 : 50
AT 32/F~33/F

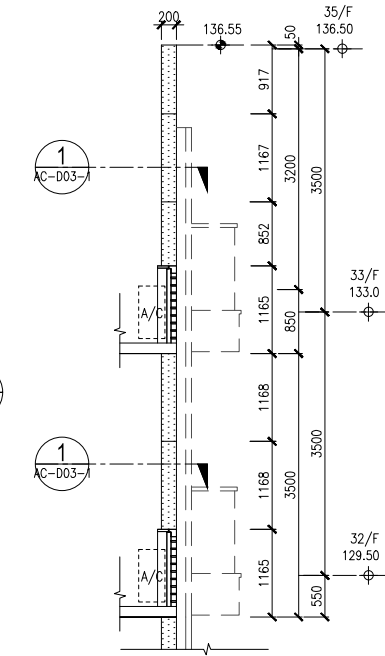


6b 'AL12'
PE09 LOCATION: FOR T1 & T2
SCALE: 1 : 50
AT 32/F~33/F

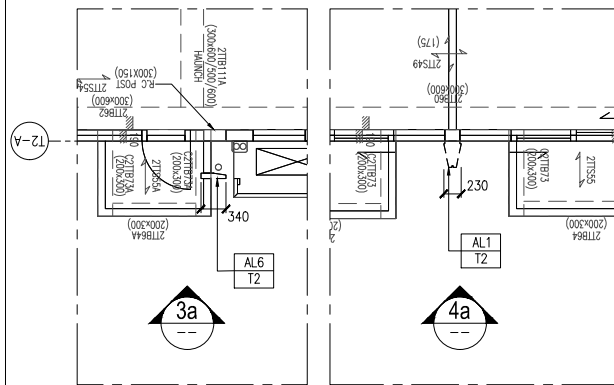


1a 'AL6'
PE09 LOCATION: FOR T1 & T2
SCALE: 1 : 50
AT 2/F~31/F


2a 'AL1'
PE09 LOCATION: FOR T1 & T2
SCALE: 1 : 50
AT 2/F~31/F

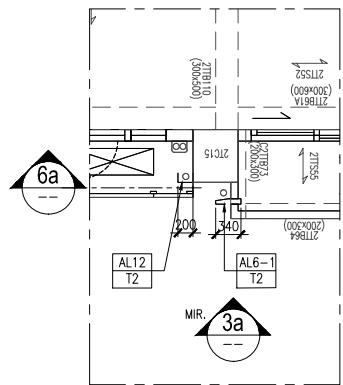

5a 'AL6-1' & 'AL12'
PE09 LOCATION: FOR T1 & T2
SCALE: 1 : 50
AT 2/F~31/F

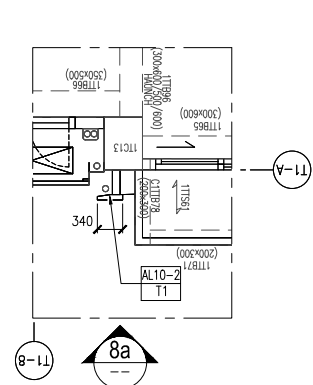


7a 'AL10-2'
PE09 LOCATION: FOR T1
SCALE: 1 : 50
AT 2/F~31/F

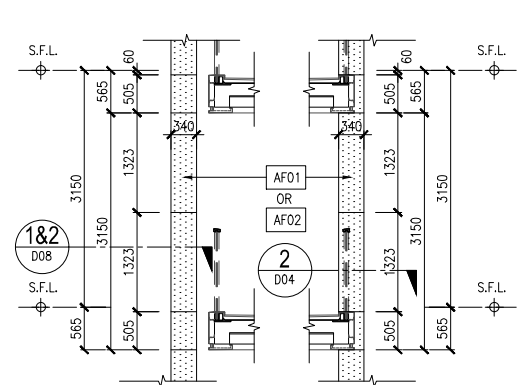


8a 'AL10-2'
PE09 LOCATION: FOR T1
SCALE: 1 : 50
AT 2/F~31/F


3a 'AL6-1'
PE09 LOCATION: FOR T1 & T2
SCALE: 1 : 50
AT 2/F~31/F

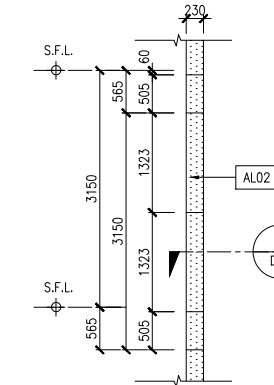

4a 'AL1'
PE09 LOCATION: FOR T1 & T2
SCALE: 1 : 50
AT 2/F~31/F

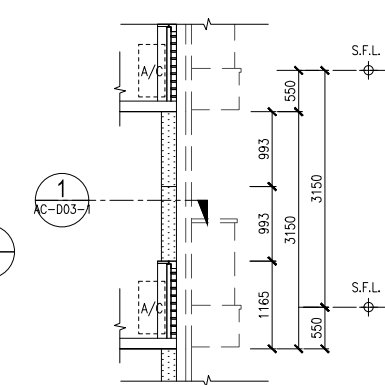


6a 'AL12'
PE09 LOCATION: FOR T1 & T2
SCALE: 1 : 50
AT 2/F~31/F

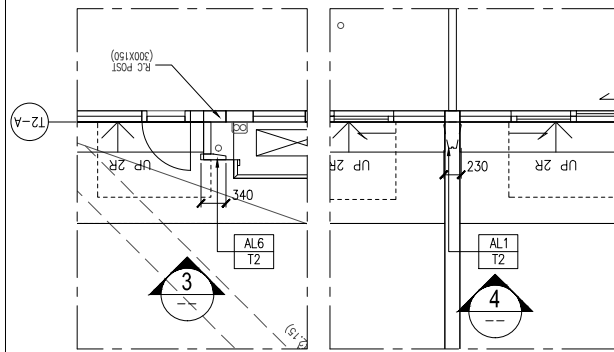


1 'AL6' AT 1/F
PE09 LOCATION: FOR T1 & T2
SCALE: 1 : 50


2 'AL1' AT 1/F
PE09 LOCATION: FOR T1 & T2
SCALE: 1 : 50

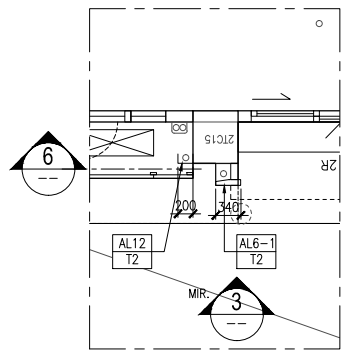

5 'AL6-1' & 'AL12'
PE09 LOCATION: FOR T1 & T2
SCALE: 1 : 50
AT 1/F

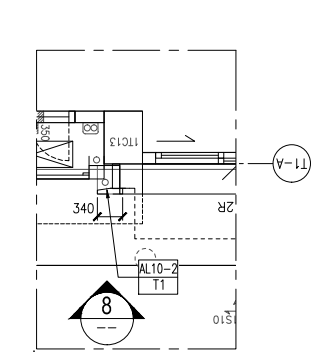


7 'AL10-2'
PE09 LOCATION: FOR T1
SCALE: 1 : 50
AT 1/F

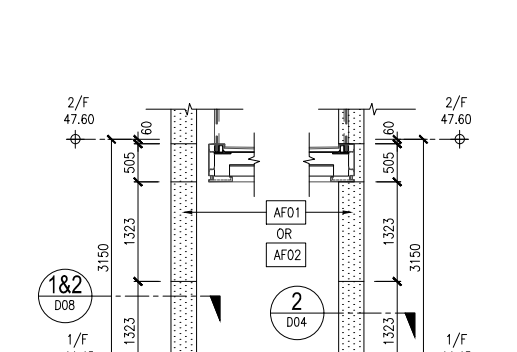


8 'AL10-2' AT 1/F
PE09 LOCATION: FOR T1
SCALE: 1 : 50

3 'AL6-1' AT 1/F
PE09 LOCATION: FOR T1 & T2
SCALE: 1 : 50

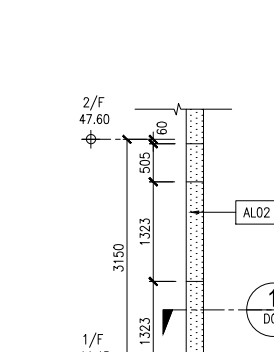

4 'AL1' AT 1/F
PE09 LOCATION: FOR T1 & T2
SCALE: 1 : 50

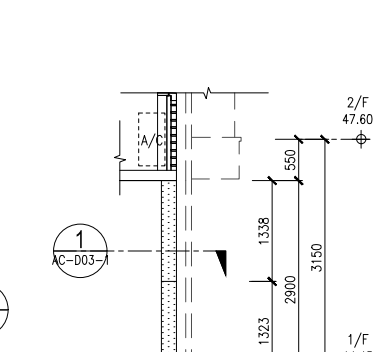

6 'AL12' AT 1/F
PE09 LOCATION: FOR T1 & T2
SCALE: 1 : 50

F.S.D. REF :

Note :

- All dimensions are in mm.
- All elevations are viewed from outside.
- All dimensions to be verified on site before fabrication.

GENERAL NOTES

Legend :

- F.F.L. --- Finished Floor Level
- S.F.L. --- Structural Floor Level
- (R) --- Reversed Detail
- MIR. --- Mirror

X1 --- DETAIL MARK NO.
X001 --- REFER SHEET NO.

STRUCTURAL & FINISH FLOOR LEVEL FOR T1, T2, 1/F~32/F (LOW, HIGH ZONE) (4TH, 13TH, 14TH, 24TH FLOOR OMITTED)		
FLOOR	S.F.L.	F.F.L.
1/F	+ 44.45	+ 44.50
2/F	+ 47.60	+ 47.65
3/F	+ 50.75	+ 50.80
5/F	+ 53.90	+ 53.95
6/F	+ 57.05	+ 57.10
7/F	+ 60.20	+ 60.25
8/F	+ 63.35	+ 63.40
9/F	+ 66.50	+ 66.55
10/F	+ 69.65	+ 69.70
11/F	+ 72.80	+ 72.85
12/F	+ 75.95	+ 76.00
15/F	+ 79.10	+ 79.15
16/F	+ 82.25	+ 82.30
17/F	+ 85.40	+ 85.45
18/F	+ 88.55	+ 88.60
19/F	+ 91.70	+ 91.75
20/F	+ 94.85	+ 94.90
21/F	+ 98.00	+ 98.05
22/F	+ 101.15	+ 101.20
23/F	+ 104.30	+ 104.35
25/F	+ 107.45	+ 107.50
26/F	+ 110.60	+ 110.65
27/F	+ 113.75	+ 113.80
28/F	+ 116.90	+ 116.95
29/F	+ 120.05	+ 120.10
30/F	+ 123.20	+ 123.25
31/F	+ 126.35	+ 126.40
32/F	+ 129.50	+ 129.55
33/F	+ 133.00	+ 133.05
35/F	+ 136.50	+ 136.55
R/F	+ 140.00	+ 140.05

A	14/04/2020	GENERAL	REVISED
NO.	DATE	REVISED	BY

CLIENT :
佳明集團控股有限公司
GRAND MING GROUP HOLDINGS LIMITED

MAIN CONTRACTOR :
GRAND TECH CONSTRUCTION CO. LTD.

ARCHITECT :
WONG TUNG & PARTNERS LIMITED
ARCHITECTS & PLANNERS

STRUCTURAL ENGINEER :
C M WONG & ASSOCIATES LTD

美特鋁質有限公司
MIDI ALUMINIUM FABRICATOR LTD.
Units 6-8, Sunray Industrial Centre, 1/F
610 Cha Kwo Ling Road, Kowloon
Tel:23489211-4 Fax:(852)2772666

PROJECT :
RESIDENTIAL DEVELOPMENT AT
TSING YI TOWN LOT 190 SAI SHAN ROAD


TITLE :
PARTIAL PLAN & PARTIAL ELEVATION OF
ALUM. CLADDING AT T2 1/F~35/F

JOB NO. : J851


DRAWN BY : DL DATE : 18-11-2019

CHKD BY : SCALE A1: 1 : 50


DWG. NO. : J851-ACF-PE09 REV. : A

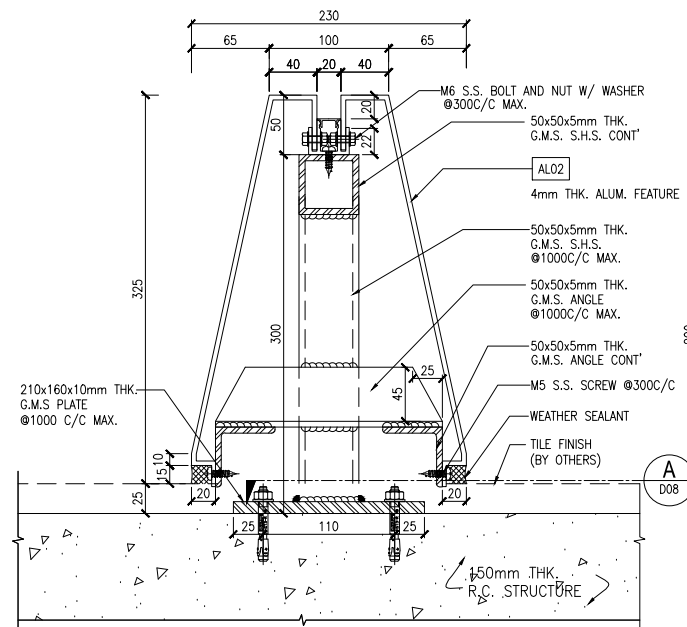


1 TYPICAL DETAIL OF ALUMINIUM CLADDING (AL1)
D01 SCALE: 1 : 3

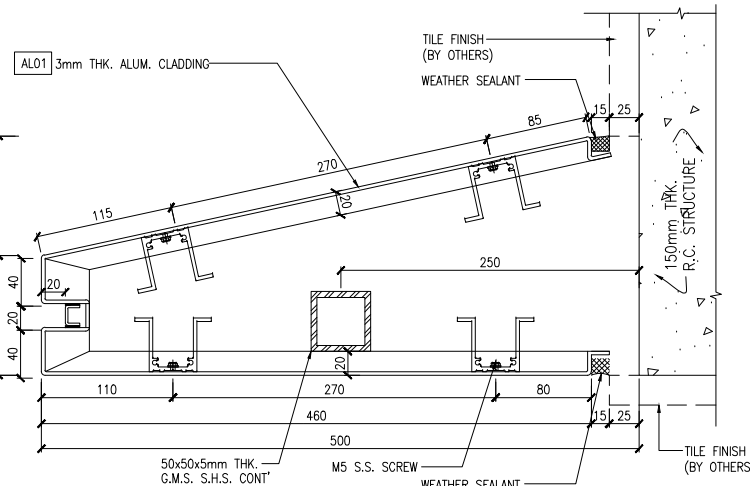


2 TYPICAL DETAIL OF ALUMINIUM CLADDING (AL2)
D01 SCALE: 1 : 3 (FOR TYPICAL)

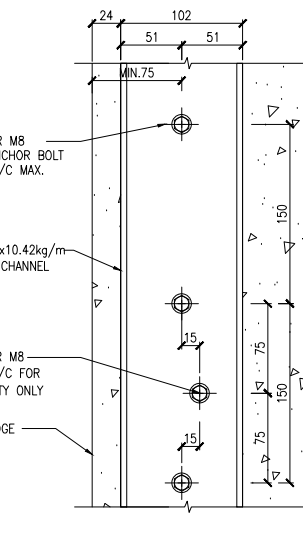


A ELEVATION DETAIL
D01 SCALE: 1 : 3

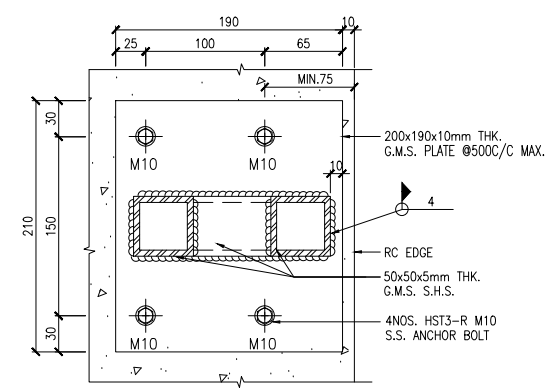


B ELEVATION DETAIL
D01 SCALE: 1 : 3

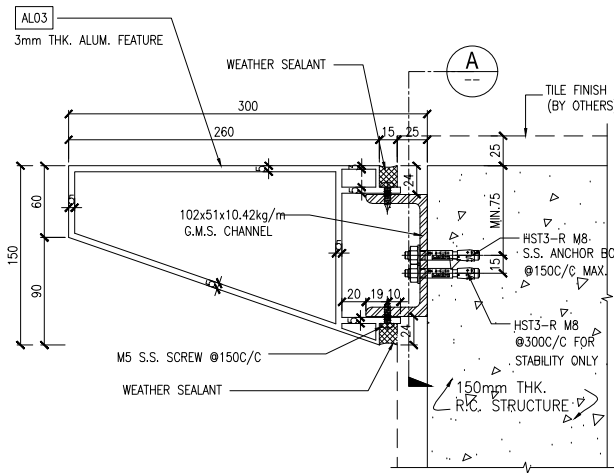


3 TYPICAL DETAIL OF ALUMINIUM CLADDING (AL3)
D01 SCALE: 1 : 3

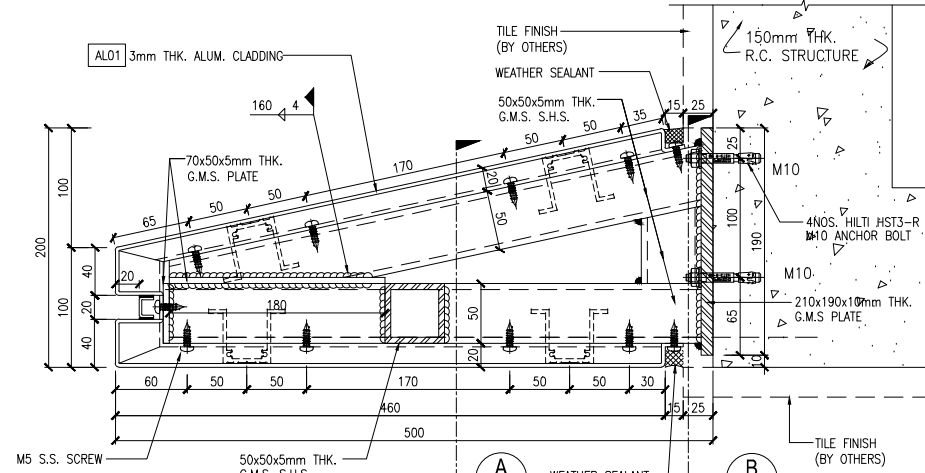


2a TYPICAL DETAIL OF ALUMINIUM CLADDING (AL2)
D01 SCALE: 1 : 3 (FOR HOR. JOINT)

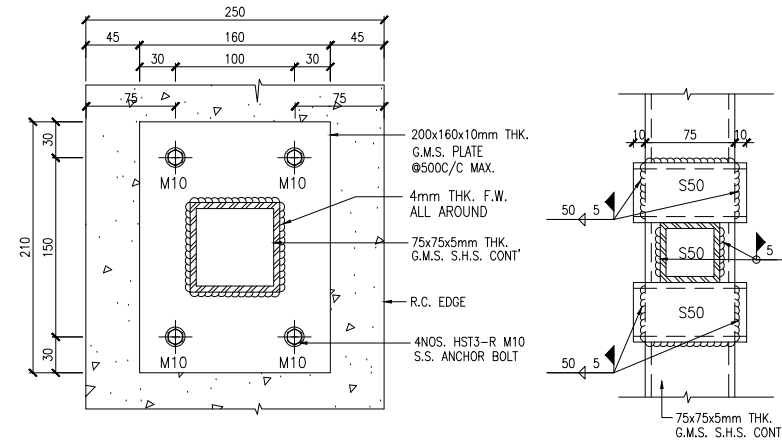


C ELEVATION DETAIL
D01 SCALE: 1 : 3

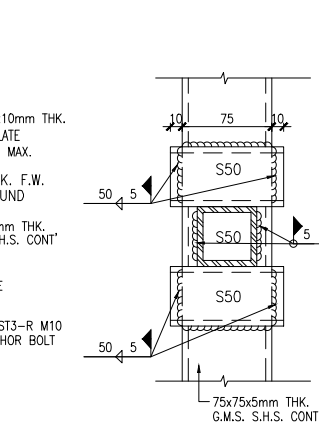

D TYP. SECTION DETAIL
D01 SCALE: 1 : 3

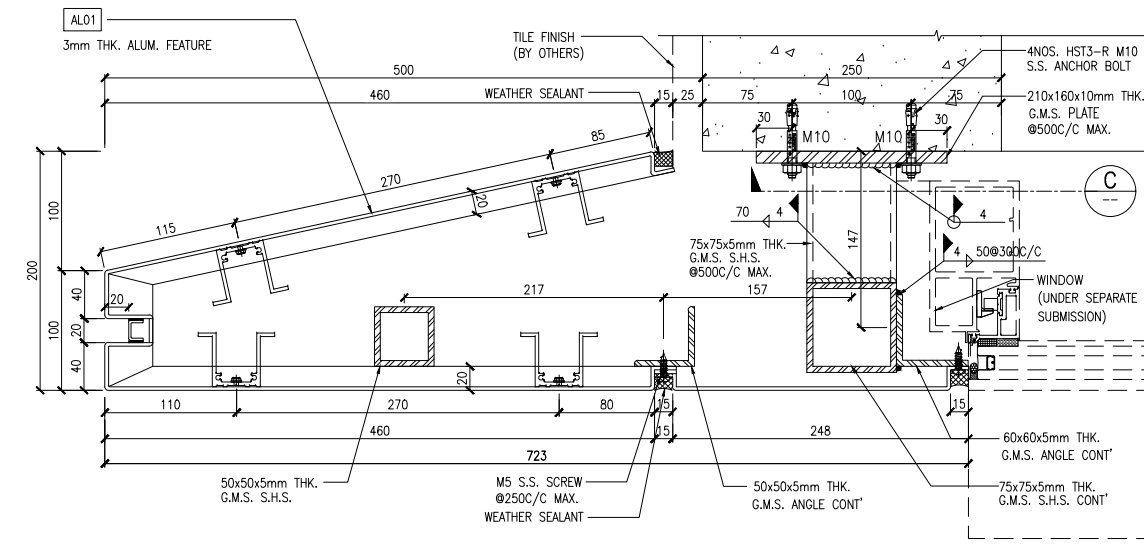

4 TYPICAL DETAIL OF ALUMINIUM CLADDING (AL2-1)
D01 SCALE: 1 : 3 (FOR TYPICAL)

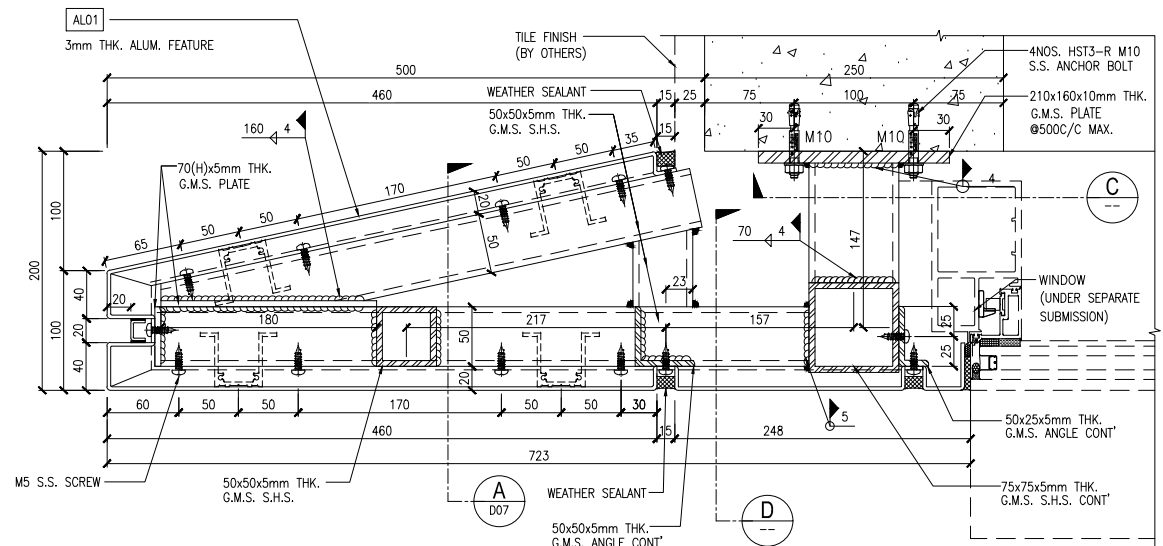

4a TYPICAL DETAIL OF ALUMINIUM CLADDING (AL2-1)
D01 SCALE: 1 : 3 (FOR HORI. JOINT)

F.S.D. REF :

Note :

- All dimensions are in mm.
- All elevations are viewed from outside.
- All dimensions to be verified on site before fabrication.

GENERAL NOTES

Legend :

- F.F.L--- Finished Floor Level
- S.F.L--- Structural Floor Level
- (R) --- Reversed Detail
- MIR. --- Mirror

- (X1) --- DETAIL MARK NO.
(X001) --- REFER SHEET NO.

NOTES:

- ALL WELDING OF STEEL FRAME TO BE 4mm F.W. ON TWO SIDES MIN. LENGTH=40mm AT EACH SIDE, UNLESS OTHERWISE STATED.
- ALL ANGLES TO BE 50x50x5mm THK. G.M.S. UNLESS OTHERWISE STATED.
- GRANITE FIXING TYPES & GRANITE TYPICAL FIXING DETAILS REFER DWG. DT-1.

ANCHOR BOLT LEGEND :

- HILTI HST3-R M8
- M10 HILTI HST3-R M10
- M5 S.S. SCREW @300C/C MAX.
- M5 STUD BOLT @250C/C MAX.
- M6 S.S. BOLT

- SITE WELD
- WELD ALL ROUND
- LOCATION OF WELD
- DEPTH OF WELD
- WELD ON ARROW SIDE
- LENGTH OF WELD
- WELD ON OTHER SIDE

NO.	DATE	GENERAL REVISED	BY
A/01/01/2020			

CLIENT :

佳明集團控股有限公司
GRAND MING GROUP HOLDINGS LIMITED

MAIN CONTRACTOR :

GRAND TECH CONSTRUCTION CO. LTD.

ARCHITECT : WONG TUNG & PARTNERS LIMITED
ARCHITECTS & PLANNERS



STRUCTURAL ENGINEER :

C M WONG & ASSOCIATES LTD

美特鋁質有限公司
MIDI ALUMINIUM FABRICATOR LTD.

Units 6-8, Sunray Industrial Centre, 1/F
610 Cho Kwo Ling Road, Kowloon
Tel:23489211-4 Fax:(852)2727666

PROJECT :

RESIDENTIAL DEVELOPMENT AT
TSING YI TOWN LOT 190 SAI SHAN ROAD

TITLE :

TYPICAL DETAILS AL1~AL3
(ALUMINIUM CLADDING)


JOB NO. : J851

DRAWN BY : DL DATE : 18-11-2019


CHKD BY : SCALE A1: 1:3

DWG. NO. : J851-ACF-D01


REV. : A

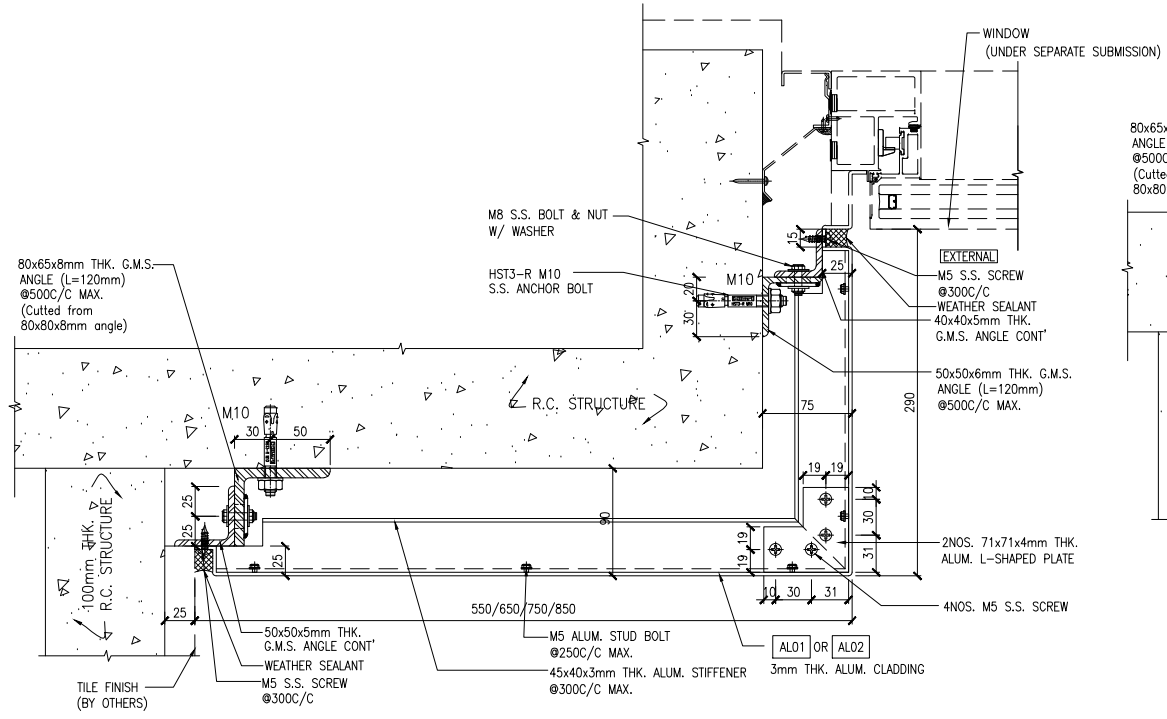


1 PLAN DETAIL OF ALUMINIUM CLADDING (AL4)
 SCALE: 1 : 3 (FOR 1/F~32/F TYPICAL)

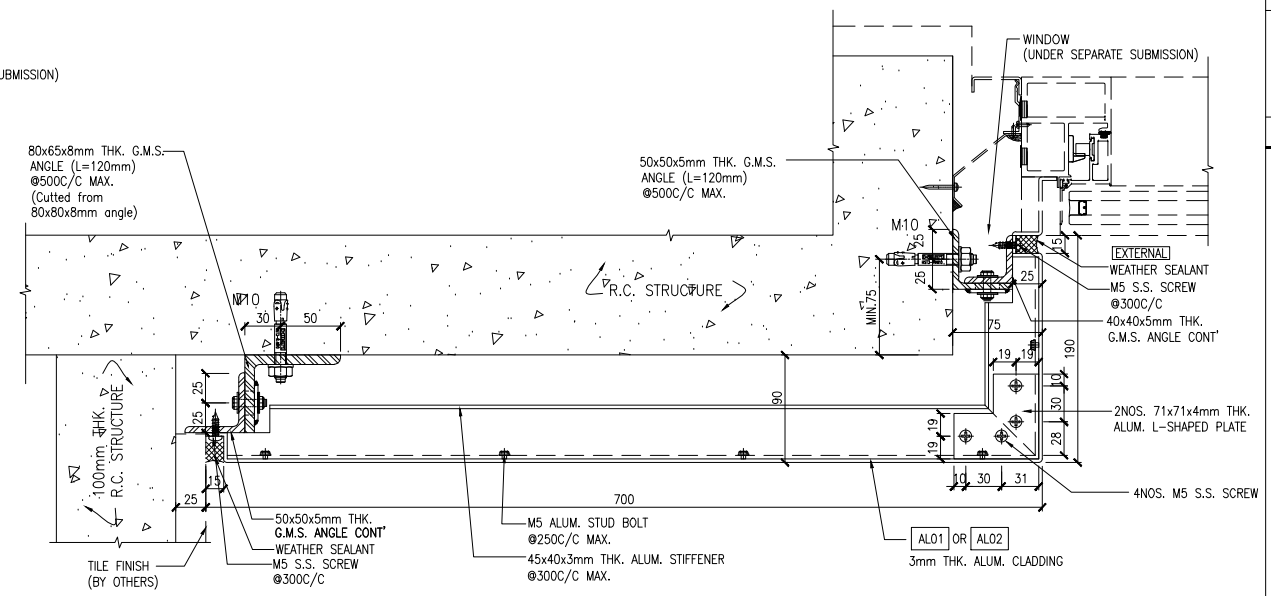


3 PLAN DETAIL OF ALUMINIUM CLADDING (AL4-1)
 SCALE: 1 : 3 (FOR 1/F~32/F TYPICAL)

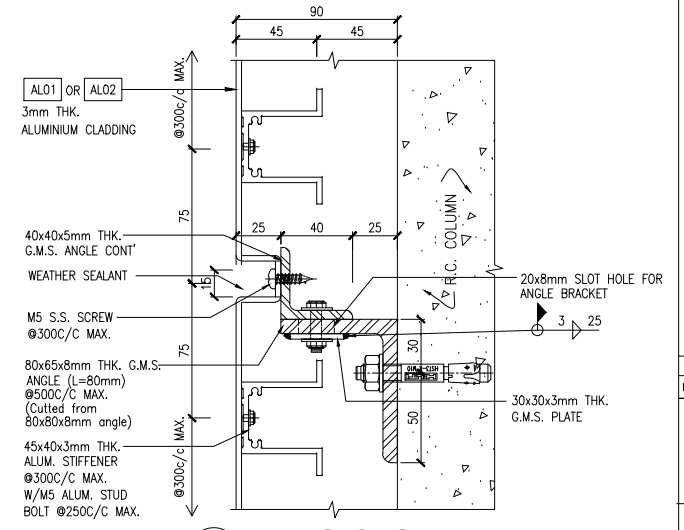

A TYP. SECTION DETAIL
 SCALE: 1 : 2

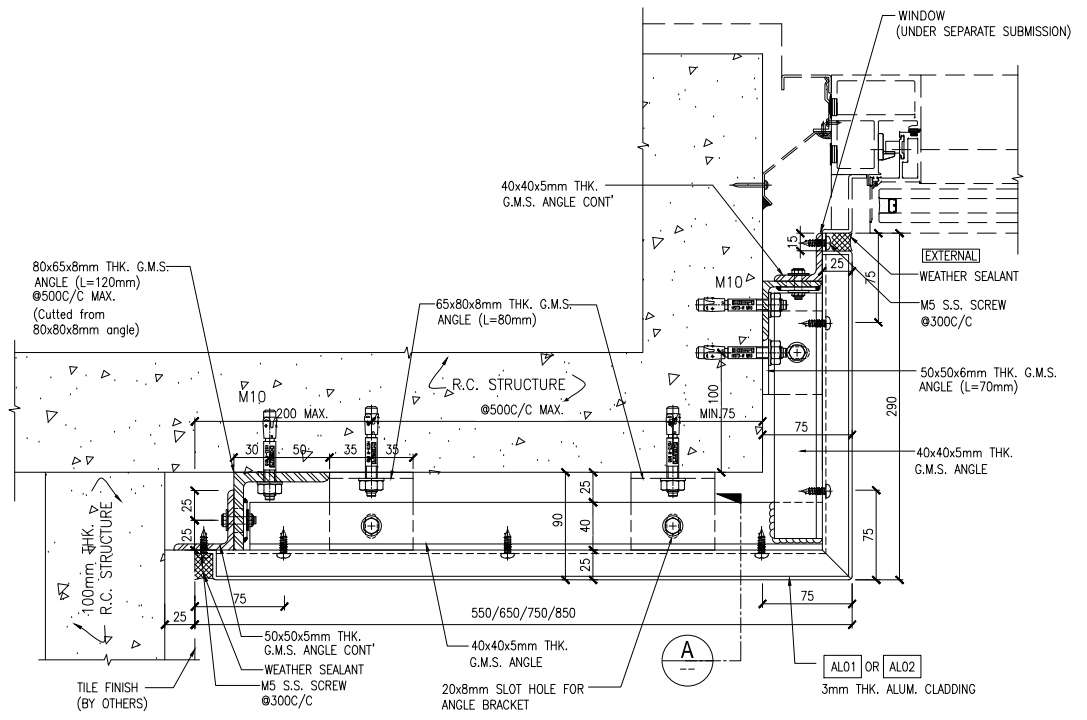

1 PLAN DETAIL OF ALUMINIUM CLADDING (AL4)
 SCALE: 1 : 3 (FOR 1/F~32/F HOR. JOINT)

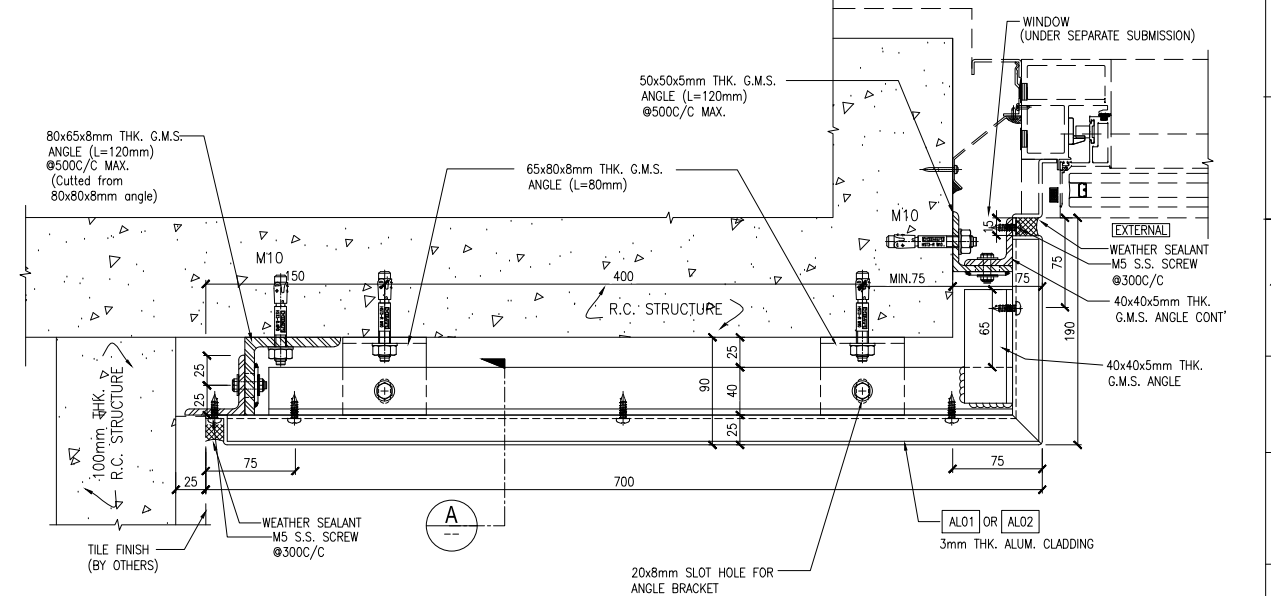


4 PLAN DETAIL OF ALUMINIUM CLADDING (AL4-1)
 SCALE: 1 : 3 (FOR 1/F~32/F HOR. JOINT)

F.S.D. REF :
 Note :
 1. All dimensions are in mm.
 2. All elevations are viewed from outside.
 3. All dimensions to be verified on site before fabrication.

GENERAL NOTES
Legend :
 1. F.F.L--- Finished Floor Level
 2. S.F.L--- Structural Floor Level
 3. (R) --- Reversed Detail
 4. MIR. --- Mirror
 (X1) --- DETAIL MARK NO.
 (X001) --- REFER SHEET NO.

NOTES:
 1. ALL WELDING OF STEEL FRAME TO BE 4mm F.W. ON TWO SIDES MIN. LENGTH=40mm AT EACH SIDE, UNLESS OTHERWISE STATED.
 2. ALL ANGLES TO BE 50x50x5mm THK. G.M.S. UNLESS OTHERWISE STATED.
 3. GRANITE FIXING TYPES & GRANITE TYPICAL FIXING DETAILS REFER DWG. DT-1.
ANCHOR BOLT LEGEND :

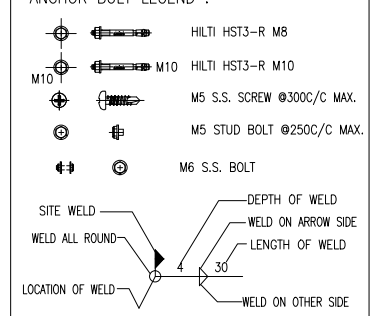

NO.	DATE	GENERAL REVISED	BY
A	19/03/2020		

CLIENT :
佳明集團控股有限公司
 GRAND MING GROUP HOLDINGS LIMITED

MAIN CONTRACTOR :
GRAND TECH CONSTRUCTION CO. LTD.

ARCHITECT : **WONG TUNG & PARTNERS LIMITED**
 ARCHITECTS & PLANNERS

STRUCTURAL ENGINEER :
C M WONG & ASSOCIATES LTD

美特銘質有限公司
MIDI ALUMINIUM FABRICATOR LTD.
 Units 6-8, Sunray Industrial Centre, 1/F
 610 Cho Kwo Ling Road, Kowloon
 Tel:23489211-4 Fax:(852)27727666

PROJECT :
RESIDENTIAL DEVELOPMENT AT TSING YI TOWN LOT 190 SAI SHAN ROAD

TITLE :
TYPICAL DETAILS AL4 & AL4-1 (ALUMINIUM CLADDING)

JOB NO. :	J851
DRAWN BY : DL	DATE : 18-11-2019
CHKD BY :	SCALE A1: AS SHOWN
DWG. NO. :	J851-ACF-D02
REV. :	A

F.S.D. REF :

- Note :
1. All dimensions are in mm.
 2. All elevations are viewed from outside.
 3. All dimensions to be verified on site before fabrication.

GENERAL NOTES

- Legend :
1. F.F.L.-- Finished Floor Level
 2. S.F.L.-- Structural Floor Level
 3. (R) -- Reversed Detail
 4. MIR. -- Mirror

- Legend :
- X1 -- DETAIL MARK NO.
 - X001 -- REFER SHEET NO.

- NOTES:
1. ALL WELDING OF STEEL FRAME TO BE 4mm F.W. ON TWO SIDES MIN. LENGTH=40mm AT EACH SIDE, UNLESS OTHERWISE STATED.
 2. ALL ANGLES TO BE 50x50x5mm THK. G.M.S. UNLESS OTHERWISE STATED.
 3. GRANITE FIXING TYPES & GRANITE TYPICAL FIXING DETAILS REFER DWG. DT-1.

- ANCHOR BOLT LEGEND :
- HILTI HST3-R M8
 - M10 HILTI HST3-R M10
 - M5 S.S. SCREW @300C/C MAX.
 - M5 STUD BOLT @250C/C MAX.
 - M6 S.S. BOLT

- WELDING LEGEND :
- SITE WELD
 - WELD ALL ROUND
 - LOCATION OF WELD
 - DEPTH OF WELD
 - WELD ON ARROW SIDE
 - LENGTH OF WELD
 - WELD ON OTHER SIDE

A	19/03/2020	GENERAL REVISED	
NO.	DATE	REVISED	BY

CLIENT :

佳明集團控股有限公司
GRAND MING GROUP HOLDINGS LIMITED

MAIN CONTRACTOR :

GRAND TECH CONSTRUCTION CO. LTD.

ARCHITECT :

WONG TUNG & PARTNERS LIMITED
ARCHITECTS & PLANNERS



STRUCTURAL ENGINEER :

C M WONG & ASSOCIATES LTD

美特鋁質有限公司
MIDI ALUMINIUM FABRICATOR LTD.

Units 6-8, Sunray Industrial Centre, 1/F
610 Cha Kwo Ling Road, Kowloon
Tel:23489211-4 Fax:(852)27727666


PROJECT :

RESIDENTIAL DEVELOPMENT AT TSING YI TOWN LOT 190 SAI SHAN ROAD

TITLE :


TYPICAL DETAILS AL5 (ALUMINIUM CLADDING)

JOB NO. :	J851
DRAWN BY :	DL
DATE :	18-11-2019
CHKD BY :	SCALE A1: AS SHOWN
DWG. NO. :	J851-ACF-D03
REV. :	A

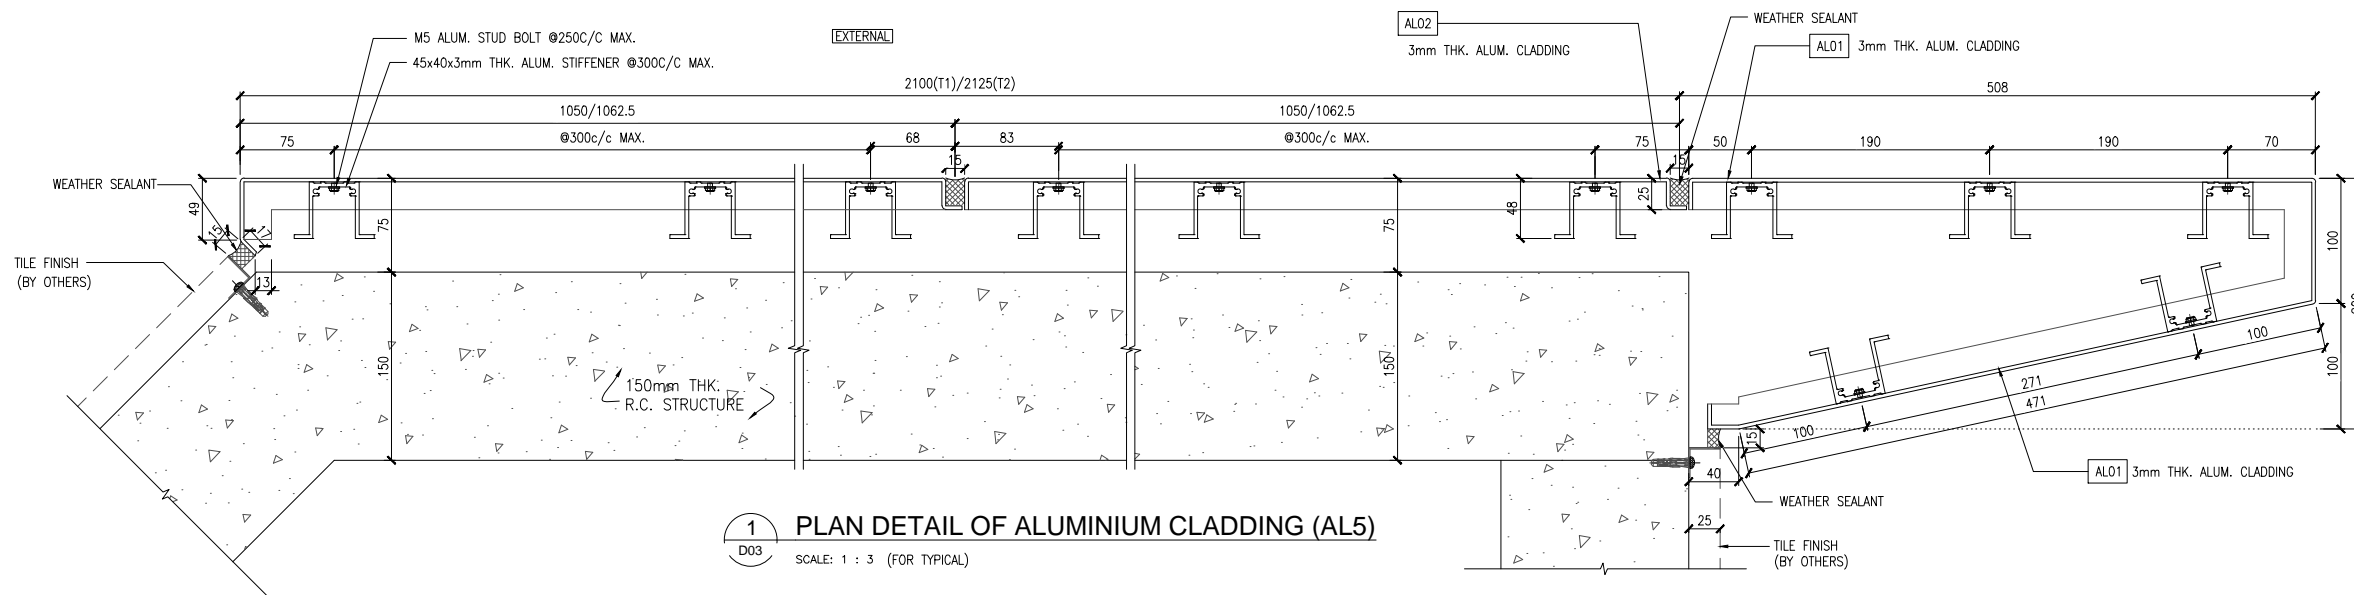


1 PLAN DETAIL OF ALUMINIUM CLADDING (AL5)

D03 SCALE: 1 : 3 (FOR TYPICAL)

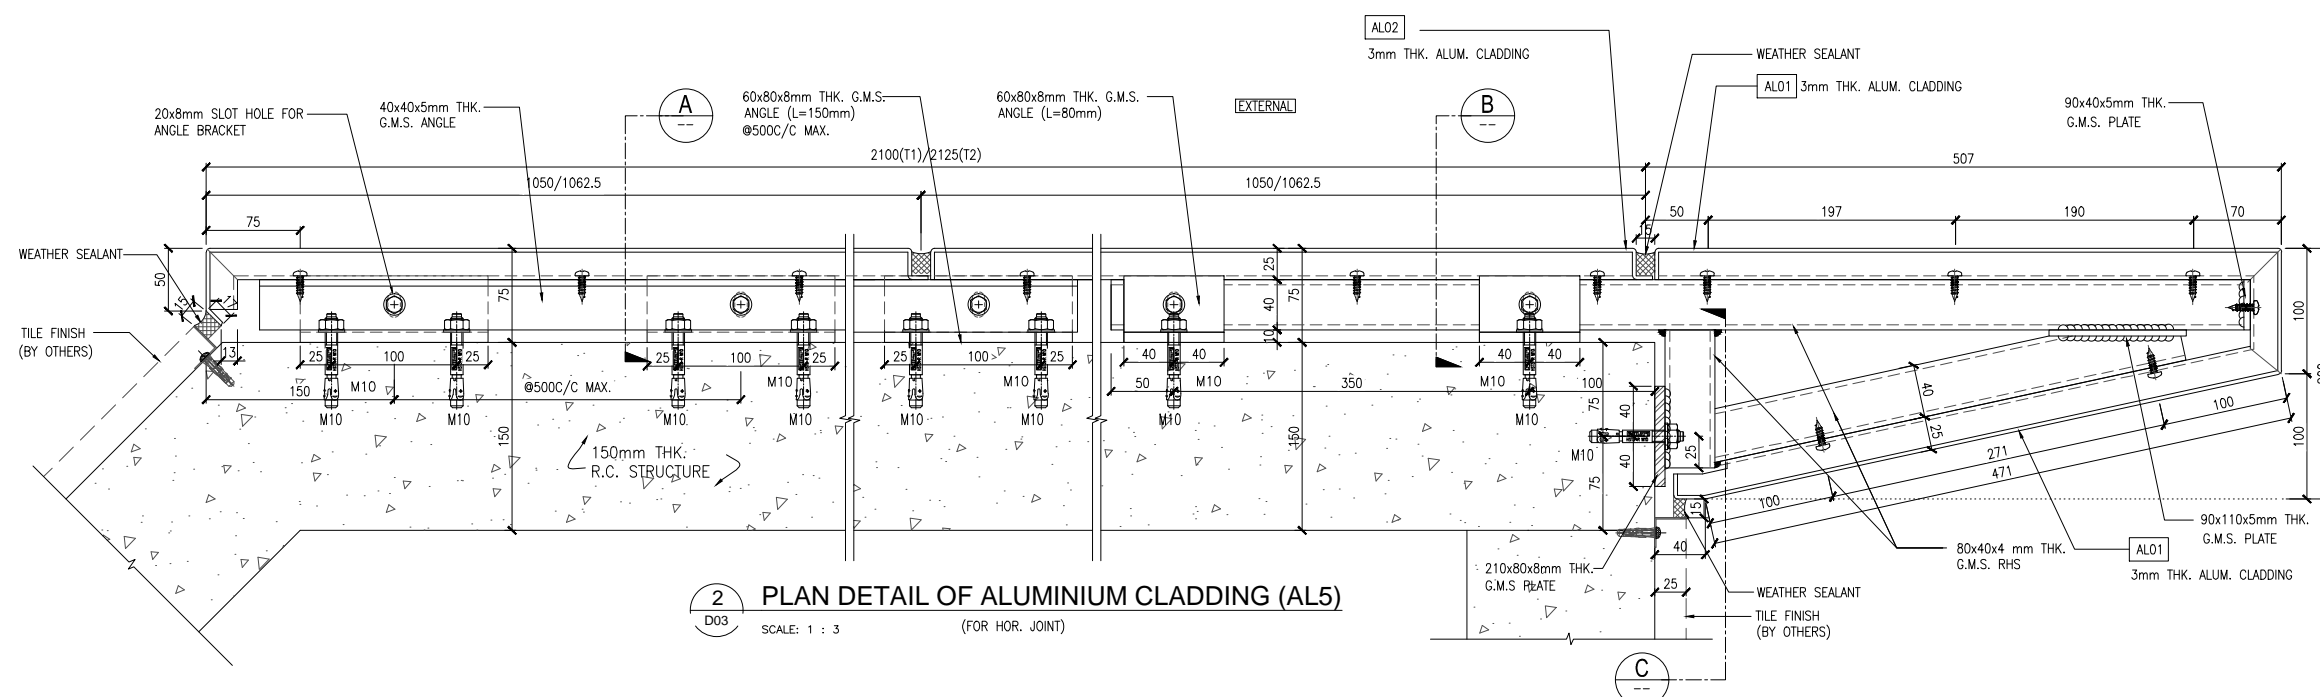


2 PLAN DETAIL OF ALUMINIUM CLADDING (AL5)

D03 SCALE: 1 : 3 (FOR HOR. JOINT)

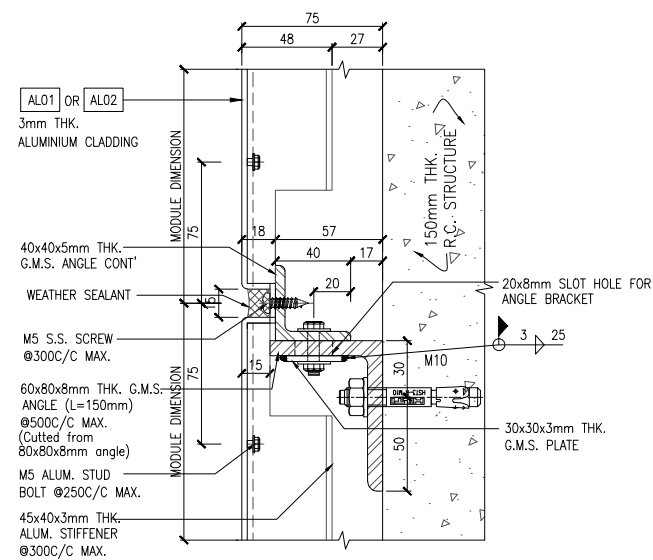


A TYP. SECTION DETAIL

D03 SCALE: 1 : 2

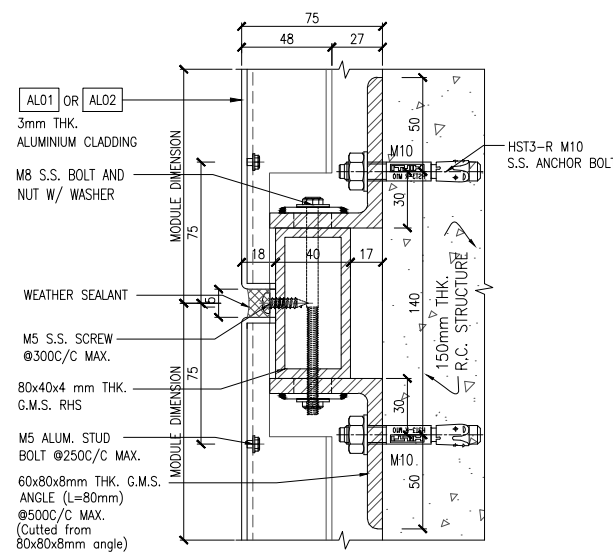


B TYP. SECTION DETAIL

D03 SCALE: 1 : 2

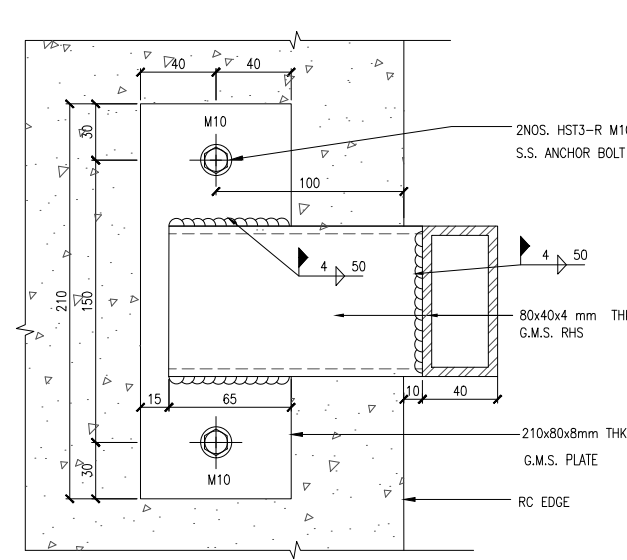


C TYP. SECTION DETAIL


D03 SCALE: 1 : 2

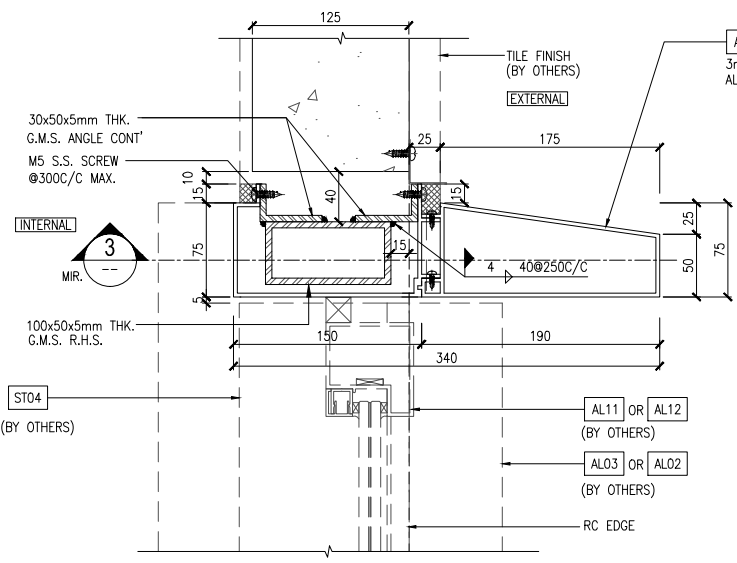


1 TYPICAL DETAIL OF ALUMINIUM CLADDING (AL6)
SCALE: 1 : 3

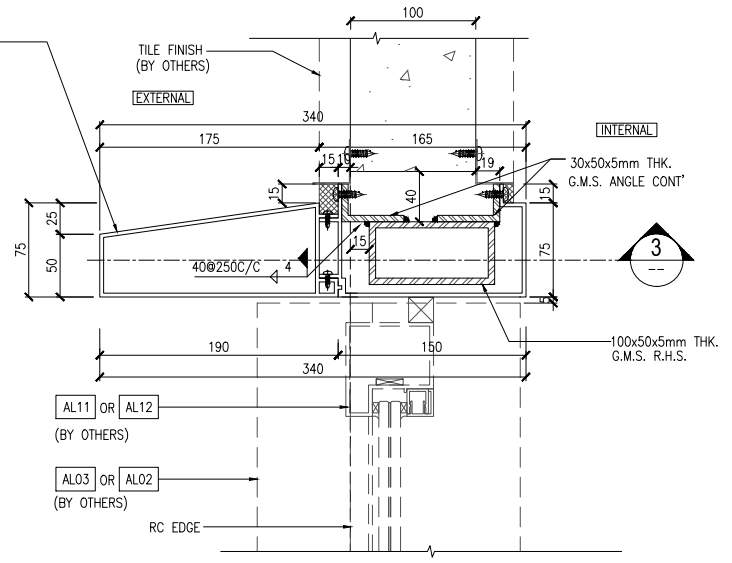


2 TYPICAL DETAIL OF ALUMINIUM CLADDING (AL6-1)
SCALE: 1 : 3

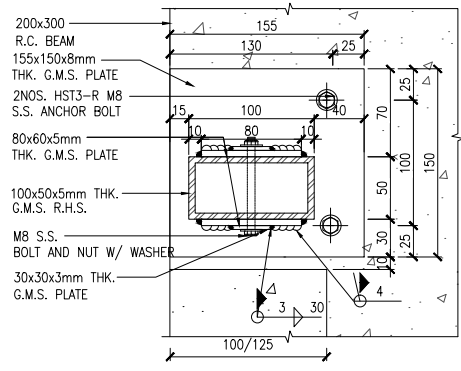


4 TOP FIXING PLAN DETAIL
SCALE: 1 : 3

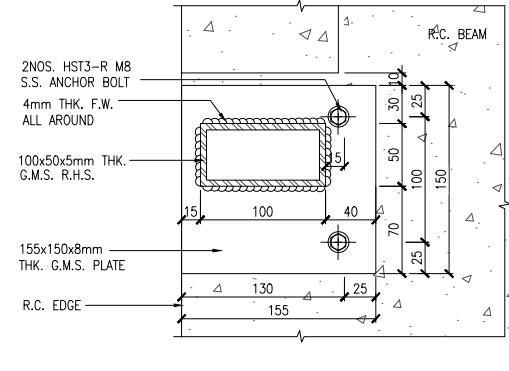

5 BOTTOM FIXING PLAN DETAIL
SCALE: 1 : 3

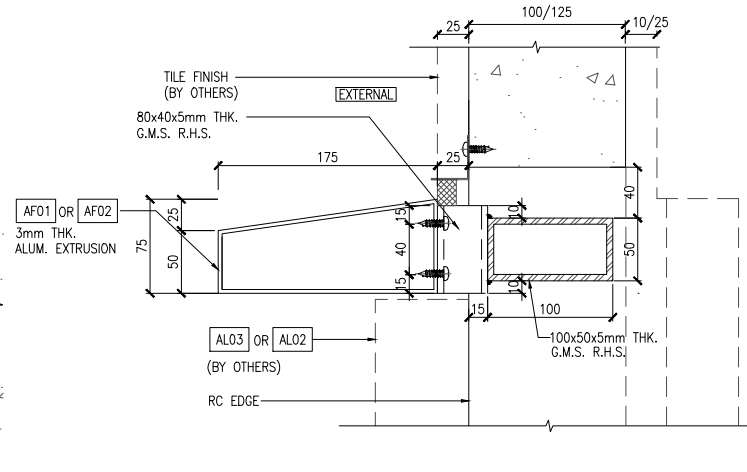

6 TYP. PLAN DETAIL
SCALE: 1 : 3

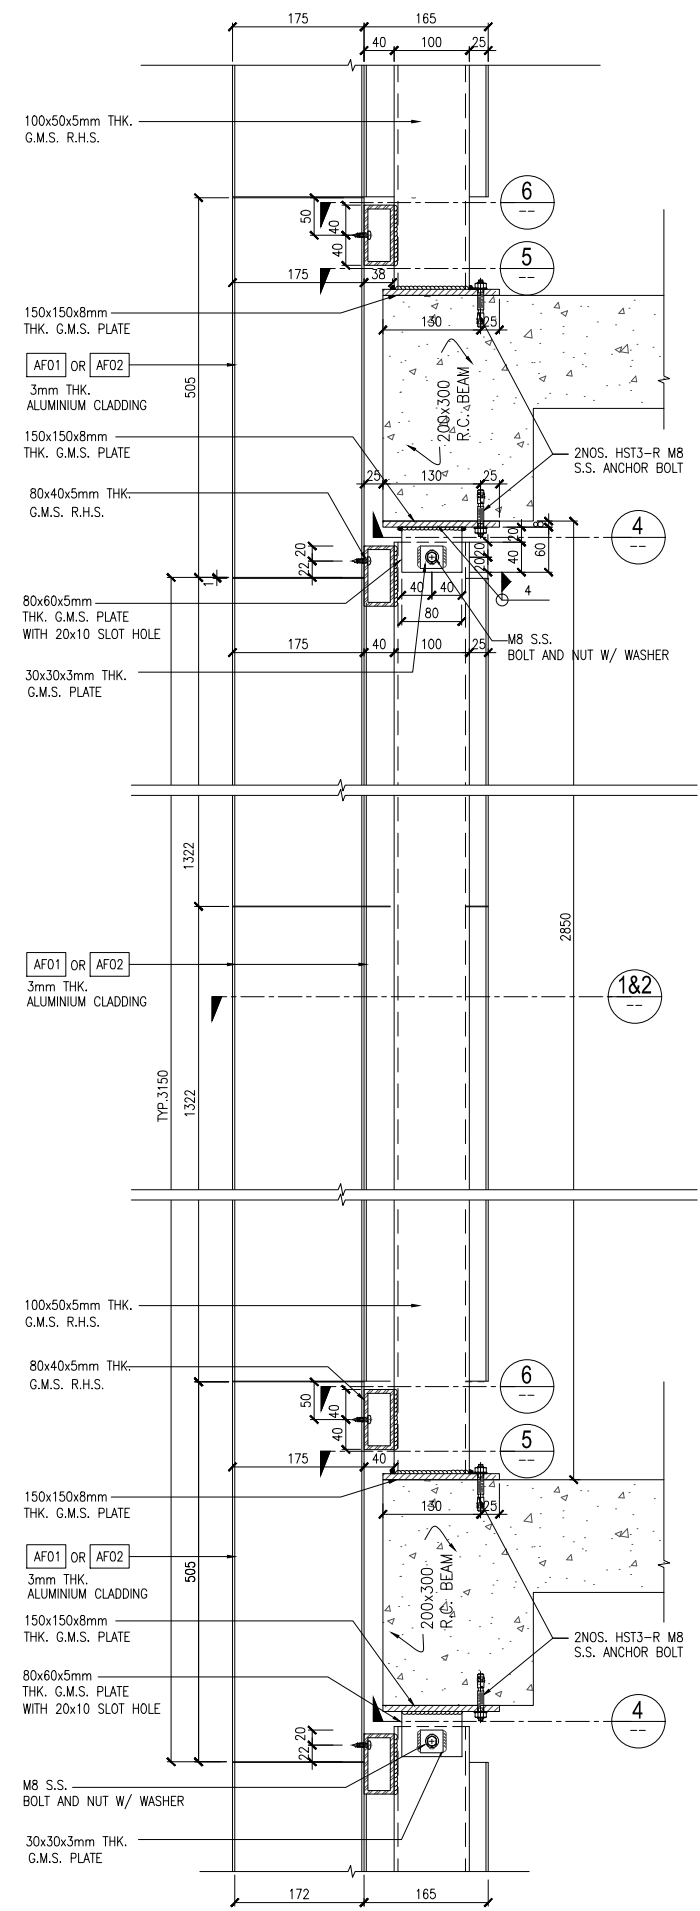

3 TYP. SECTION DETAIL
SCALE: 1 : 5

F.S.D. REF :

Note :

- All dimensions are in mm.
- All elevations are viewed from outside.
- All dimensions to be verified on site before fabrication.

GENERAL NOTES

Legend :

- F.F.L.-- Finished Floor Level
- S.F.L.-- Structural Floor Level
- (/R) -- Reversed Detail
- MIR. -- Mirror

X1 -- DETAIL MARK NO.
X001 -- REFER SHEET NO.

NOTES:

- ALL WELDING OF STEEL FRAME TO BE 4mm F.W. ON TWO SIDES MIN. LENGTH=40mm AT EACH SIDE, UNLESS OTHERWISE STATED.
- ALL ANGLES TO BE 50x50x5mm THK. G.M.S. UNLESS OTHERWISE STATED.
- GRANITE FIXING TYPES & GRANITE TYPICAL FIXING DETAILS REFER DWG. DT-1.

ANCHOR BOLT LEGEND :

HILTI HST3-R M8

M10 HILTI HST3-R M10

M5 S.S. SCREW @300C/C MAX.

M5 STUD BOLT @250C/C MAX.

M6 S.S. BOLT

SITE WELD

WELD ALL ROUND

LOCATION OF WELD

DEPTH OF WELD

WELD ON ARROW SIDE

LENGTH OF WELD

WELD ON OTHER SIDE

A	01/01/2020	GENERAL REVISED	
NO.	DATE	REVISED	BY

CLIENT :

佳明集團控股有限公司
GRAND MING GROUP HOLDINGS LIMITED

MAIN CONTRACTOR :

GRAND TECH CONSTRUCTION CO. LTD.

ARCHITECT :

WONG TUNG & PARTNERS LIMITED
ARCHITECTS & PLANNERS

STRUCTURAL ENGINEER :

C M WONG & ASSOCIATES LTD

美特鋁質有限公司
MIDI ALUMINIUM FABRICATOR LTD.

Units 6-8, Sunray Industrial Centre, 1/F
610 Cho Kwo Ling Road, Kowloon
Tel:23489211-4 Fax:(852)27727666

PROJECT :

RESIDENTIAL DEVELOPMENT AT
TSING YI TOWN LOT 190 SAI SHAN ROAD

TITLE :


TYPICAL DETAILS AL6 & AL6-1
(ALUMINIUM CLADDING)

JOB NO. : J851


DRAWN BY : DL DATE : 18-11-2019

CHKD BY : SCALE A1: AS SHOWN


DWG. NO. : J851-ACF-D04 REV. : A

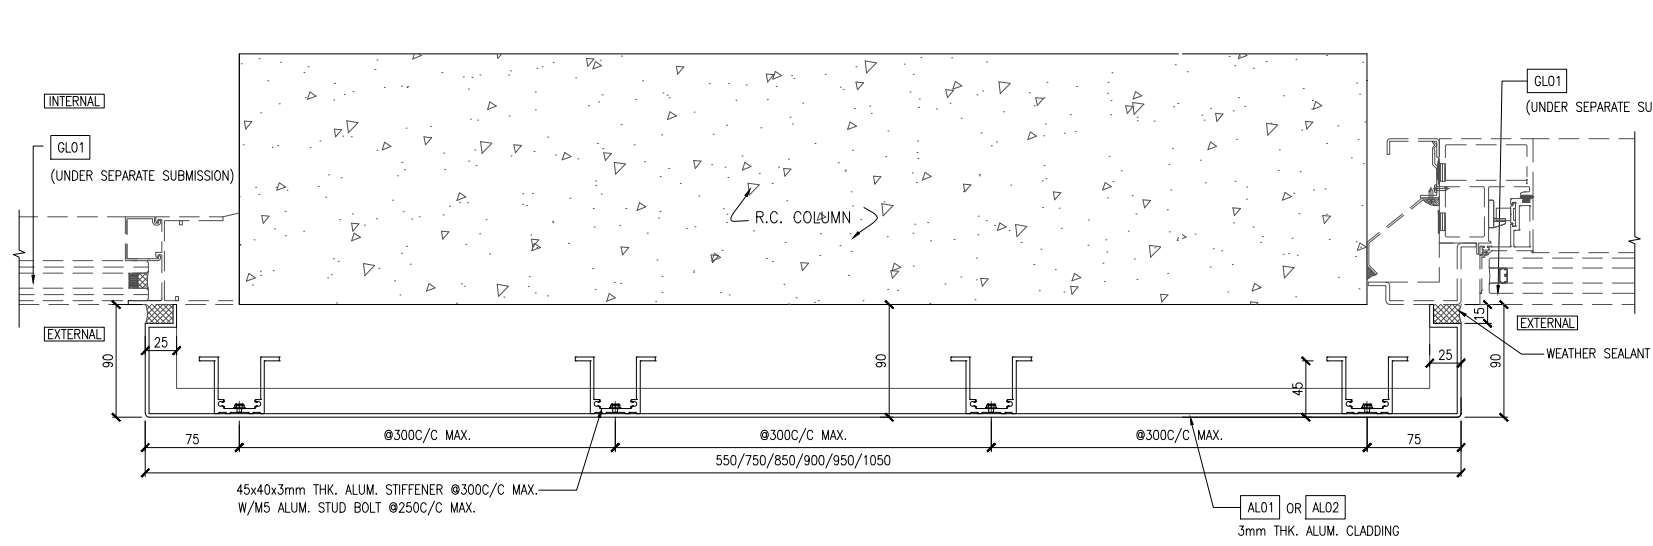


1 TYPICAL DETAIL OF ALUMINIUM CLADDING (AL7)
 SCALE: 1 : 3 (FOR 33/F&35/F)
 D05

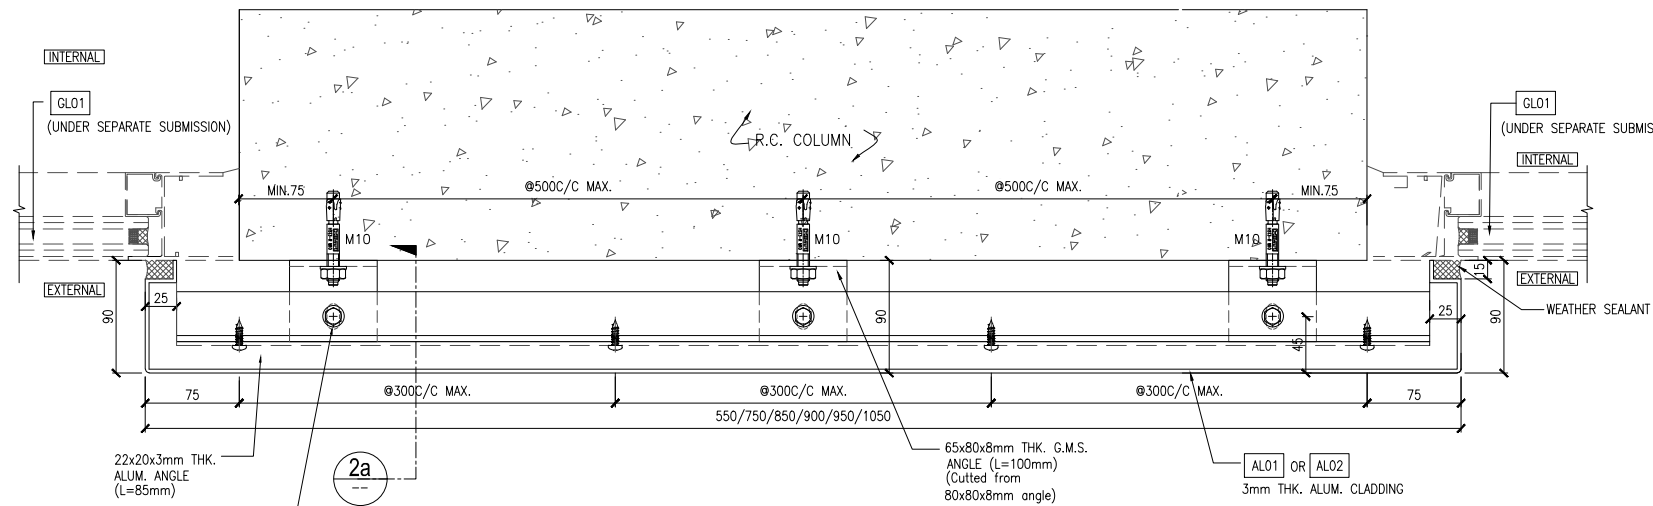


2 TYPICAL DETAIL OF ALUMINIUM CLADDING (AL7)
 SCALE: 1 : 3 (FOR 33/F&35/F)
 D05

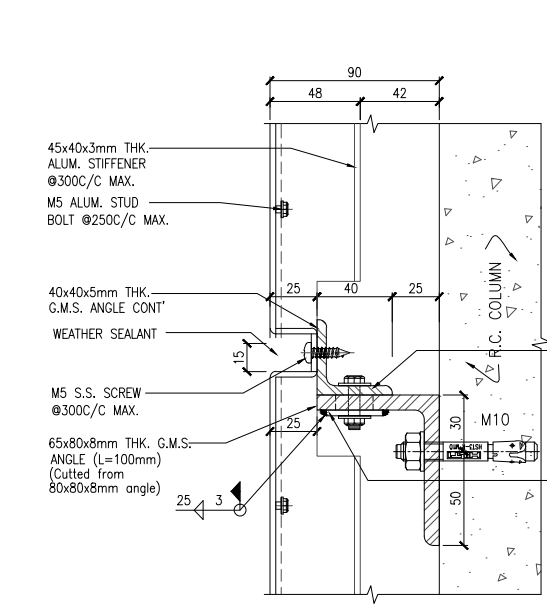


2a TYP. SECTION DETAIL
 SCALE: 1 : 2
 D05

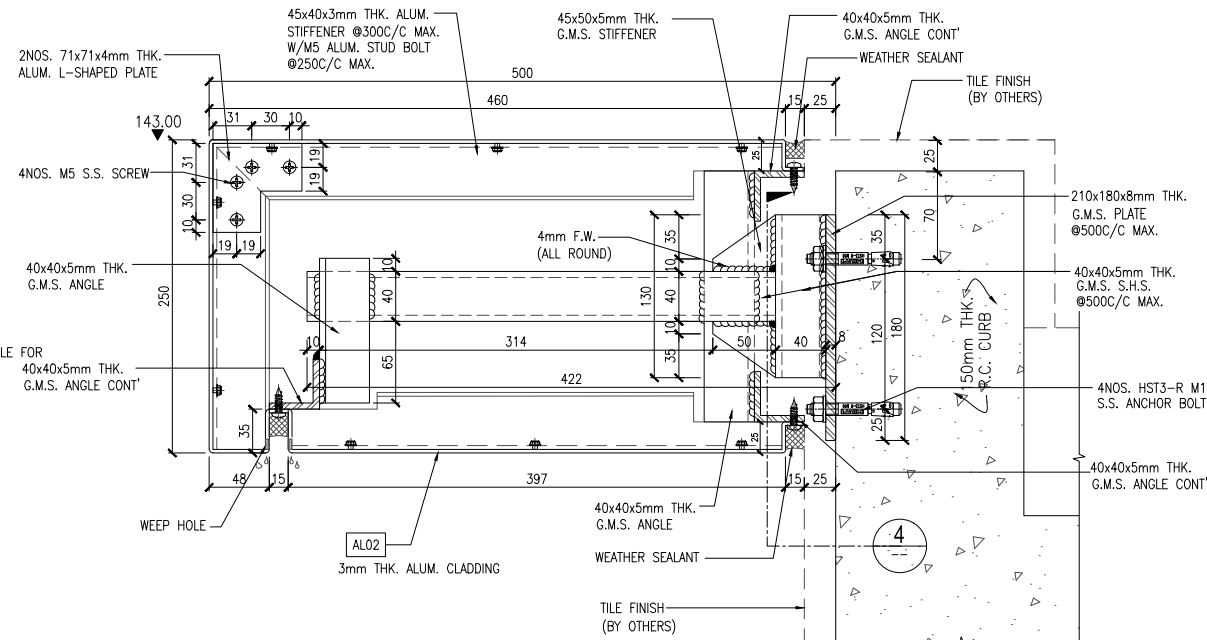

4 TYP. SECTION DETAIL OF ALUMINIUM CLADDING (AL8)
 SCALE: 1 : 3
 D05

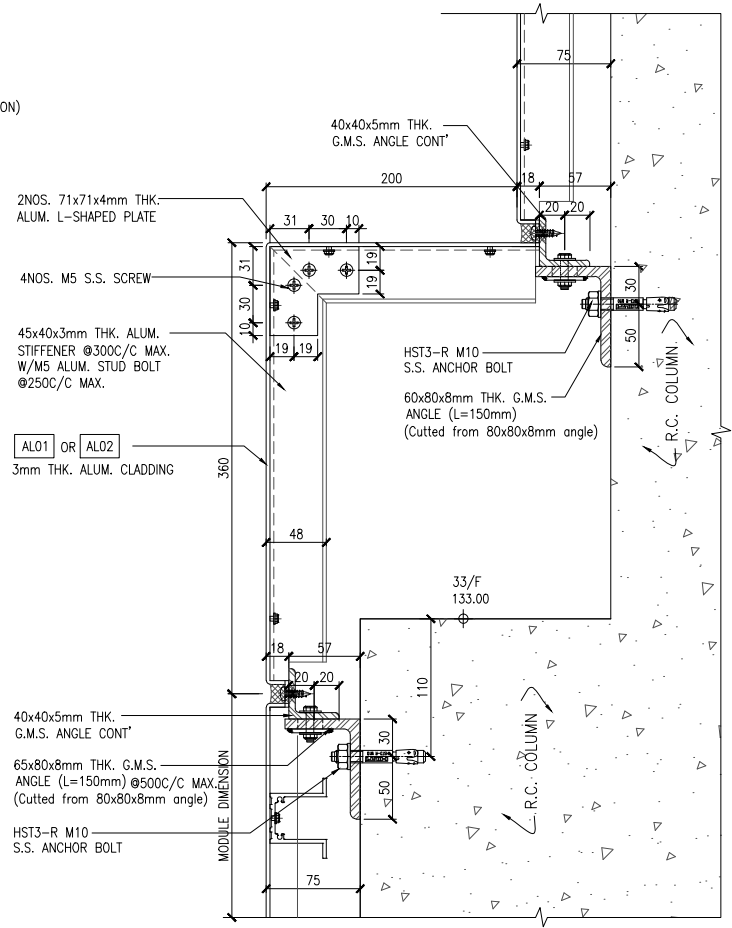

3 TYP. SECTION DETAIL
 SCALE: 1 : 3
 D05

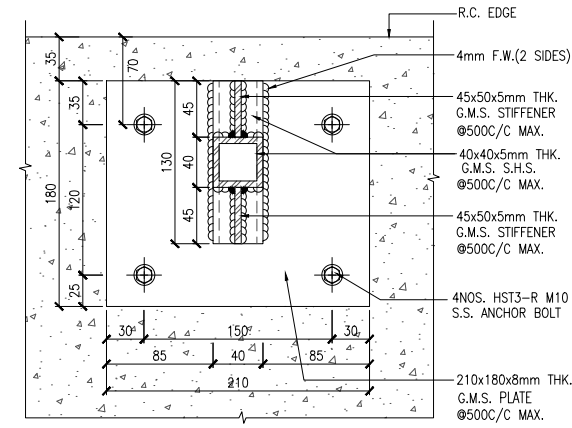

5 ELEVATION DETAIL
 SCALE: 1 : 3
 D-07

F.S.D. REF :
 Note :
 1. All dimensions are in mm.
 2. All elevations are viewed from outside.
 3. All dimensions to be verified on site before fabrication.

GENERAL NOTES

Legend :

1. F.F.L.-- Finished Floor Level
 2. S.F.L.-- Structural Floor Level
 3. (R) -- Reversed Detail
 4. MIR. -- Mirror

(X1) -- DETAIL MARK NO.
 (X001) -- REFER SHEET NO.

NOTES:

1. ALL WELDING OF STEEL FRAME TO BE 4mm F.W. ON TWO SIDES MIN. LENGTH=40mm AT EACH SIDE, UNLESS OTHERWISE STATED.
 2. ALL ANGLES TO BE 50x50x5mm THK. G.M.S. UNLESS OTHERWISE STATED.
 3. GRANITE FIXING TYPES & GRANITE TYPICAL FIXING DETAILS REFER DWG. DT-1.

ANCHOR BOLT LEGEND :

HILTI HST3-R M8
 HILTI HST3-R M10
 M5 S.S. SCREW @300C/C MAX.
 M5 STUD BOLT @250C/C MAX.
 M6 S.S. BOLT

SITE WELD
 WELD ALL ROUND
 LOCATION OF WELD

DEPTH OF WELD
 WELD ON ARROW SIDE
 LENGTH OF WELD
 WELD ON OTHER SIDE

NO.	DATE	GENERAL REVISED	BY
A	19/03/2020	GENERAL	
		REVISED	

CLIENT :
 佳明集團控股有限公司
 GRAND MING GROUP HOLDINGS LIMITED

MAIN CONTRACTOR :
 GRAND TECH CONSTRUCTION CO. LTD.

ARCHITECT :
 WONG TUNG & PARTNERS LIMITED
 ARCHITECTS & PLANNERS


STRUCTURAL ENGINEER :
 C M WONG & ASSOCIATES LTD

美特鋁質有限公司
 MIDI ALUMINIUM FABRICATOR LTD.
 Units 6-8, Sunray Industrial Centre, 1/F
 610 Cho Kwo Ling Road, Kowloon
 Tel:23489211-4 Fax:(852)27727666

PROJECT :
 RESIDENTIAL DEVELOPMENT AT
 TSING YI TOWN LOT 190 SAI SHAN ROAD


TITLE :
 TYPICAL DETAILS AL7 & AL8
 (ALUMINIUM CLADDING)

JOB NO. : J851
DRAWN BY : DL **DATE :** 18-11-2019
CHKD BY : **SCALE** A1: AS SHOWN
DWG. NO. : J851-ACF-D05 **REV. :** A

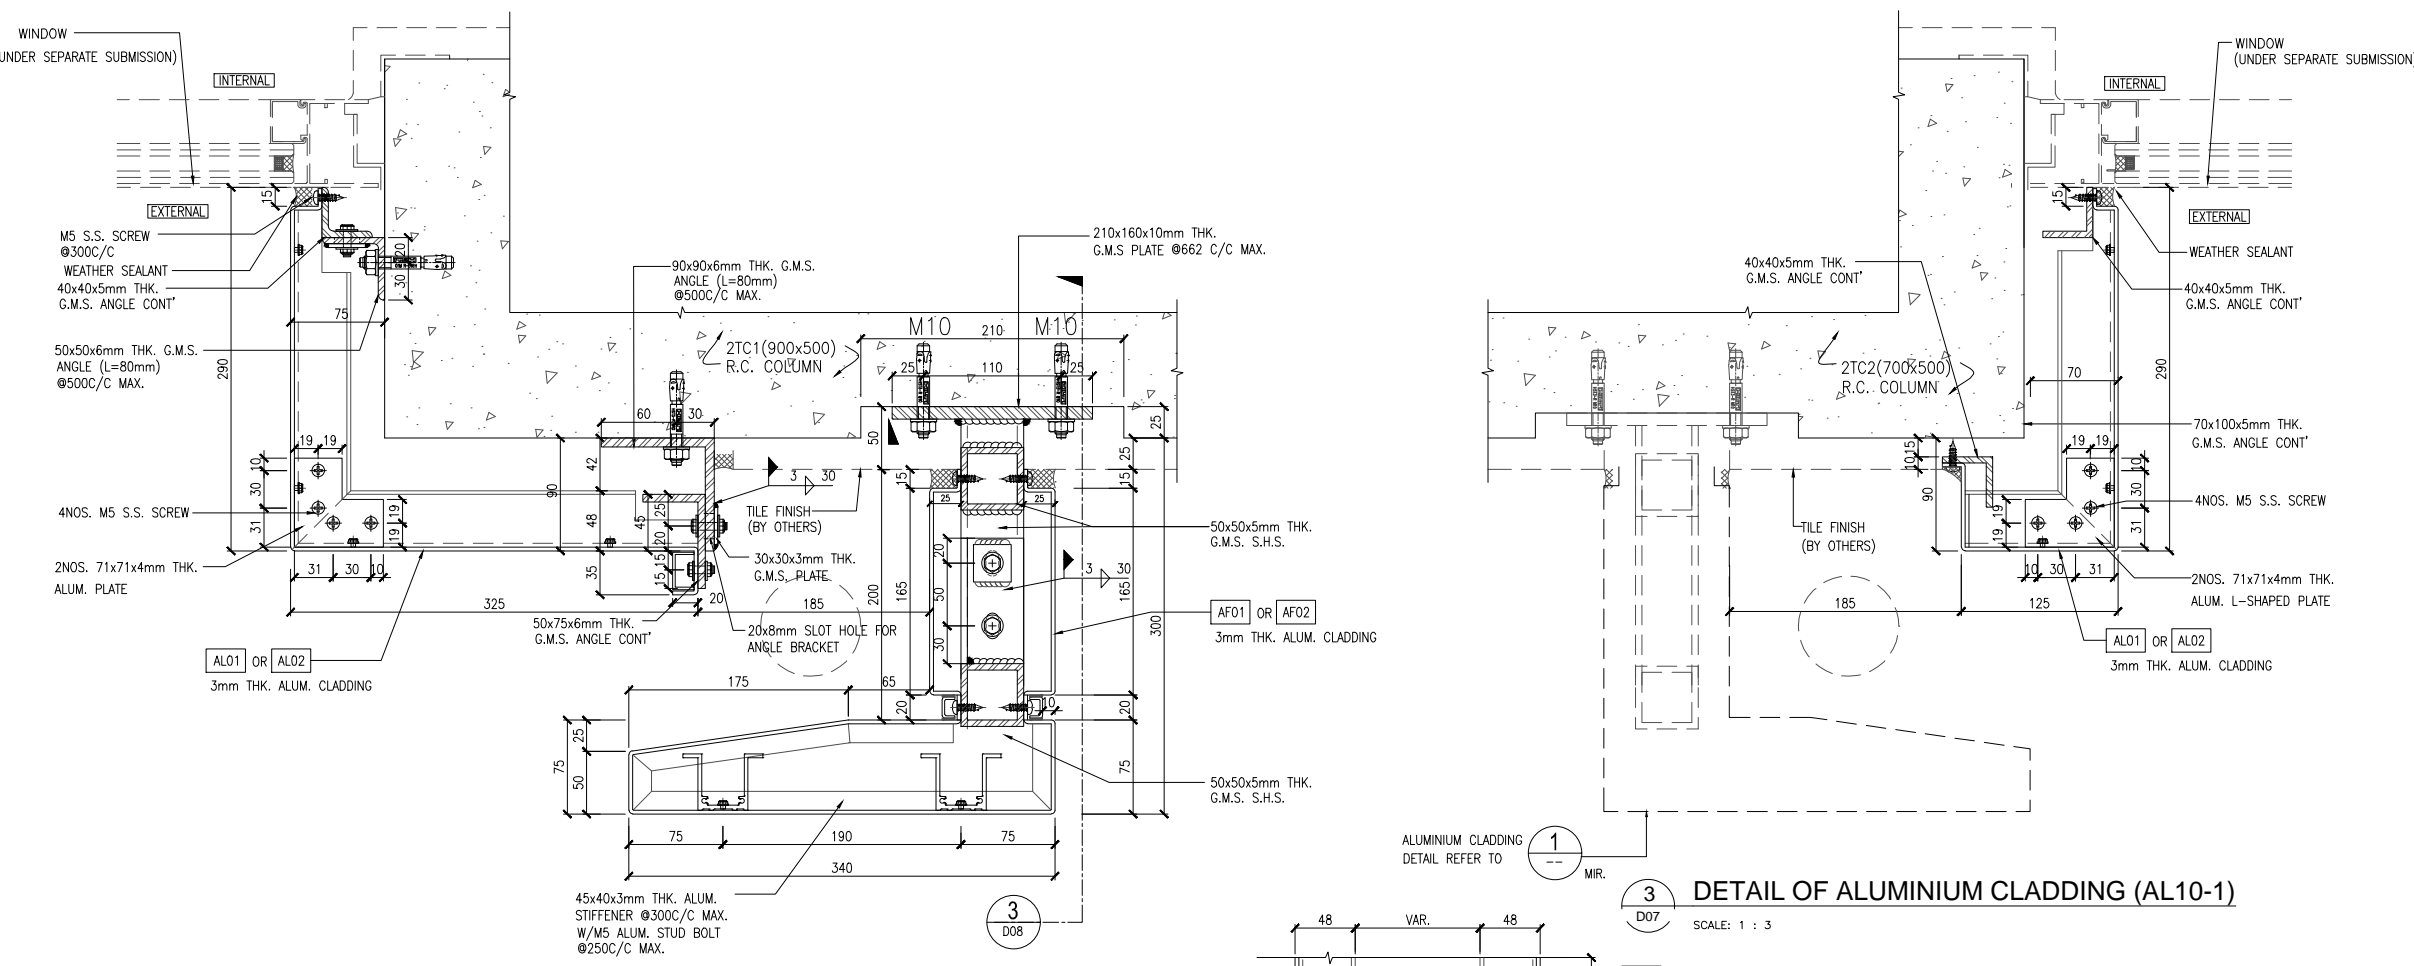


1 PLAN DETAIL OF ALUMINIUM CLADDING (AL10)
SCALE: 1 : 3

3 DETAIL OF ALUMINIUM CLADDING (AL10-1)
SCALE: 1 : 3

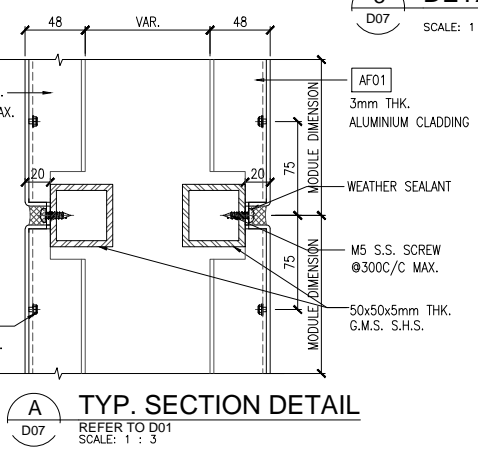

A TYP. SECTION DETAIL
REFER TO D01
SCALE: 1 : 3

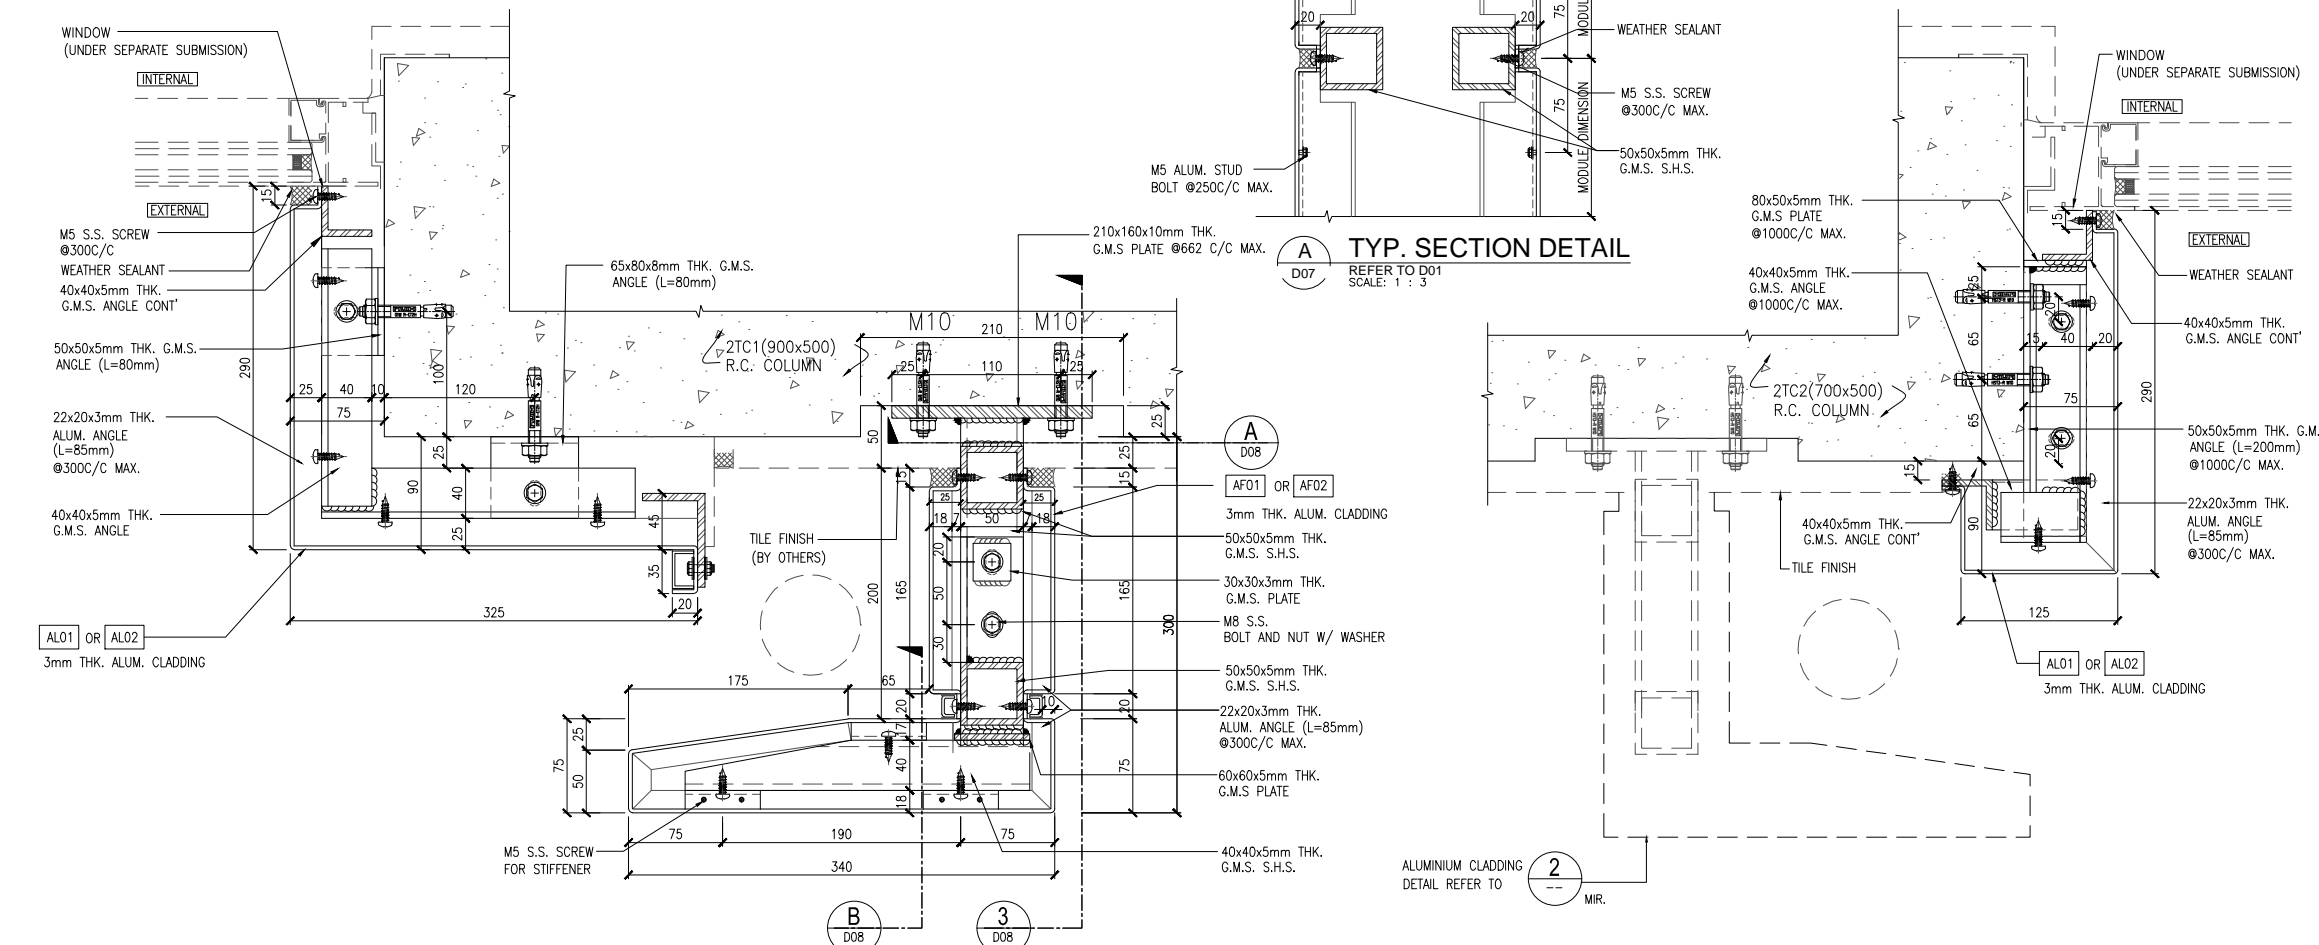

2 DETAIL OF ALUMINIUM CLADDING (10)
SCALE: 1 : 3

4 DETAIL OF ALUMINIUM CLADDING (AL10-1)
SCALE: 1 : 3

F.S.D. REF :
 Note :
 1. All dimensions are in mm.
 2. All elevations are viewed from outside.
 3. All dimensions to be verified on site before fabrication.

GENERAL NOTES

Legend :

1. F.F.L.-- Finished Floor Level
 2. S.F.L.-- Structural Floor Level
 3. (R) -- Reversed Detail
 4. MIR. -- Mirror

(X1) -- DETAIL MARK NO.
 (X001) -- REFER SHEET NO.

NOTES:

1. ALL WELDING OF STEEL FRAME TO BE 4mm F.W. ON TWO SIDES MIN. LENGTH=40mm AT EACH SIDE, UNLESS OTHERWISE STATED.
 2. ALL ANGLES TO BE 50x50x5mm THK. G.M.S. UNLESS OTHERWISE STATED.
 3. GRANITE FIXING TYPES & GRANITE TYPICAL FIXING DETAILS REFER DWG. DT-1.

ANCHOR BOLT LEGEND :

HILTI HST3-R M8
 M10 HILTI HST3-R M10
 M5 S.S. SCREW @300C/C MAX.
 M5 STUD BOLT @250C/C MAX.
 M6 S.S. BOLT

SITE WELD
 WELD ALL ROUND
 LOCATION OF WELD

DEPTH OF WELD
 WELD ON ARROW SIDE
 LENGTH OF WELD
 WELD ON OTHER SIDE

A	19/03/2020	GENERAL REVISED	
NO.	DATE	REVISED	BY

CLIENT :
佳明集團控股有限公司
 GRAND MING GROUP HOLDINGS LIMITED

MAIN CONTRACTOR :
GRAND TECH CONSTRUCTION CO. LTD.

ARCHITECT :
WONG TUNG & PARTNERS LIMITED
 ARCHITECTS & PLANNERS


STRUCTURAL ENGINEER :
C M WONG & ASSOCIATES LTD

美特鋁質有限公司
 MIDI ALUMINIUM FABRICATOR LTD.
 Units 6-8, Sunray Industrial Centre, 1/F
 610 Cha Kwo Ling Road, Kowloon
 Tel:23489211-4 Fax:(852)27727666

PROJECT :
 RESIDENTIAL DEVELOPMENT AT
 TSING YI TOWN LOT 190 SAI SHAN ROAD

TITLE :
 TYPICAL DETAILS AL10 & AL10-1
 (ALUMINIUM CLADDING)


JOB NO. : J851
 DRAWN BY : DL DATE : 18-11-2019
 CHKD BY : SCALE A1: 1 : 3
 DWG. NO. : J851-ACF-D07 REV. : A

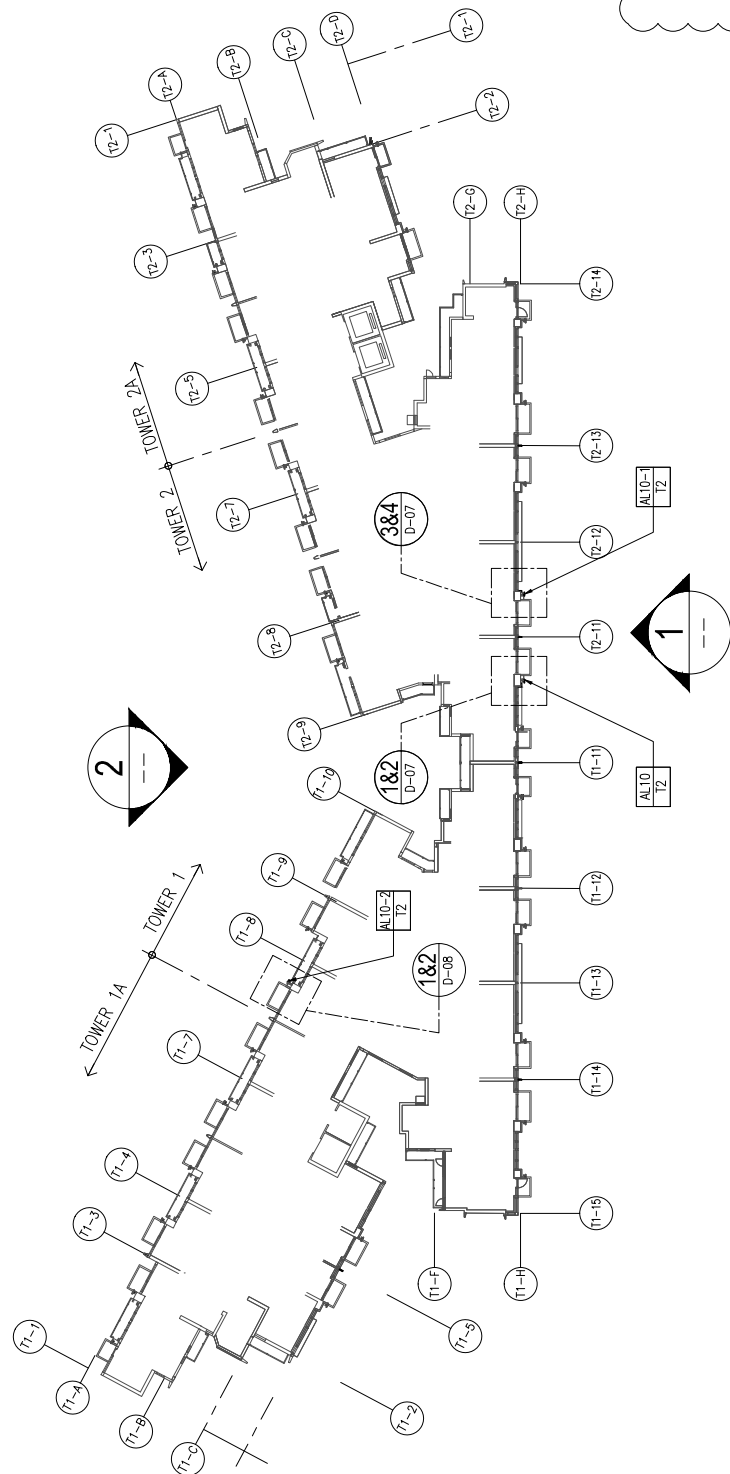

A KEY PLAN FOR 25mm R.C. RECESS

SCALE: N.T.S.


E-01.1

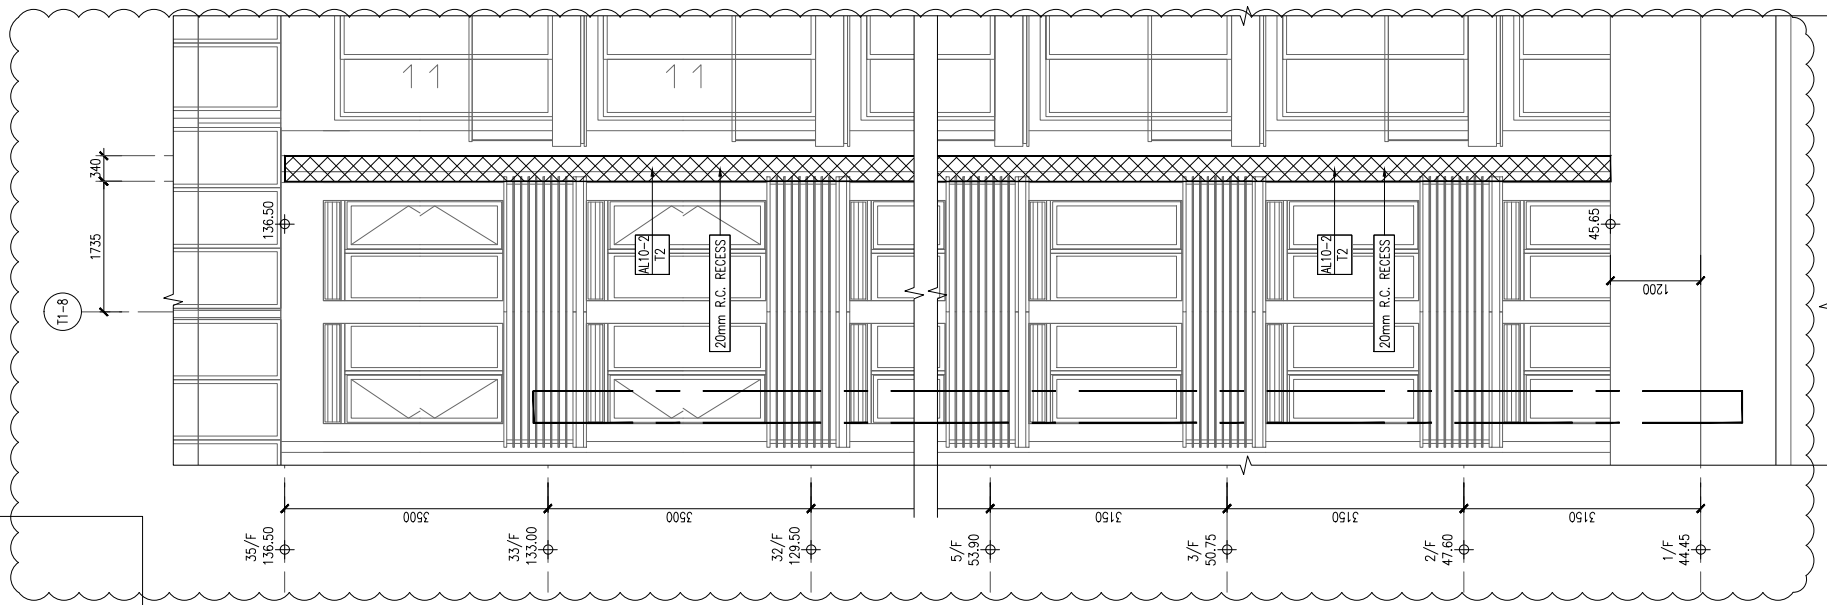

2 PARTIAL ELEVATION FOR R.C. RECESS

SCALE: 1 : 50

E-01.1

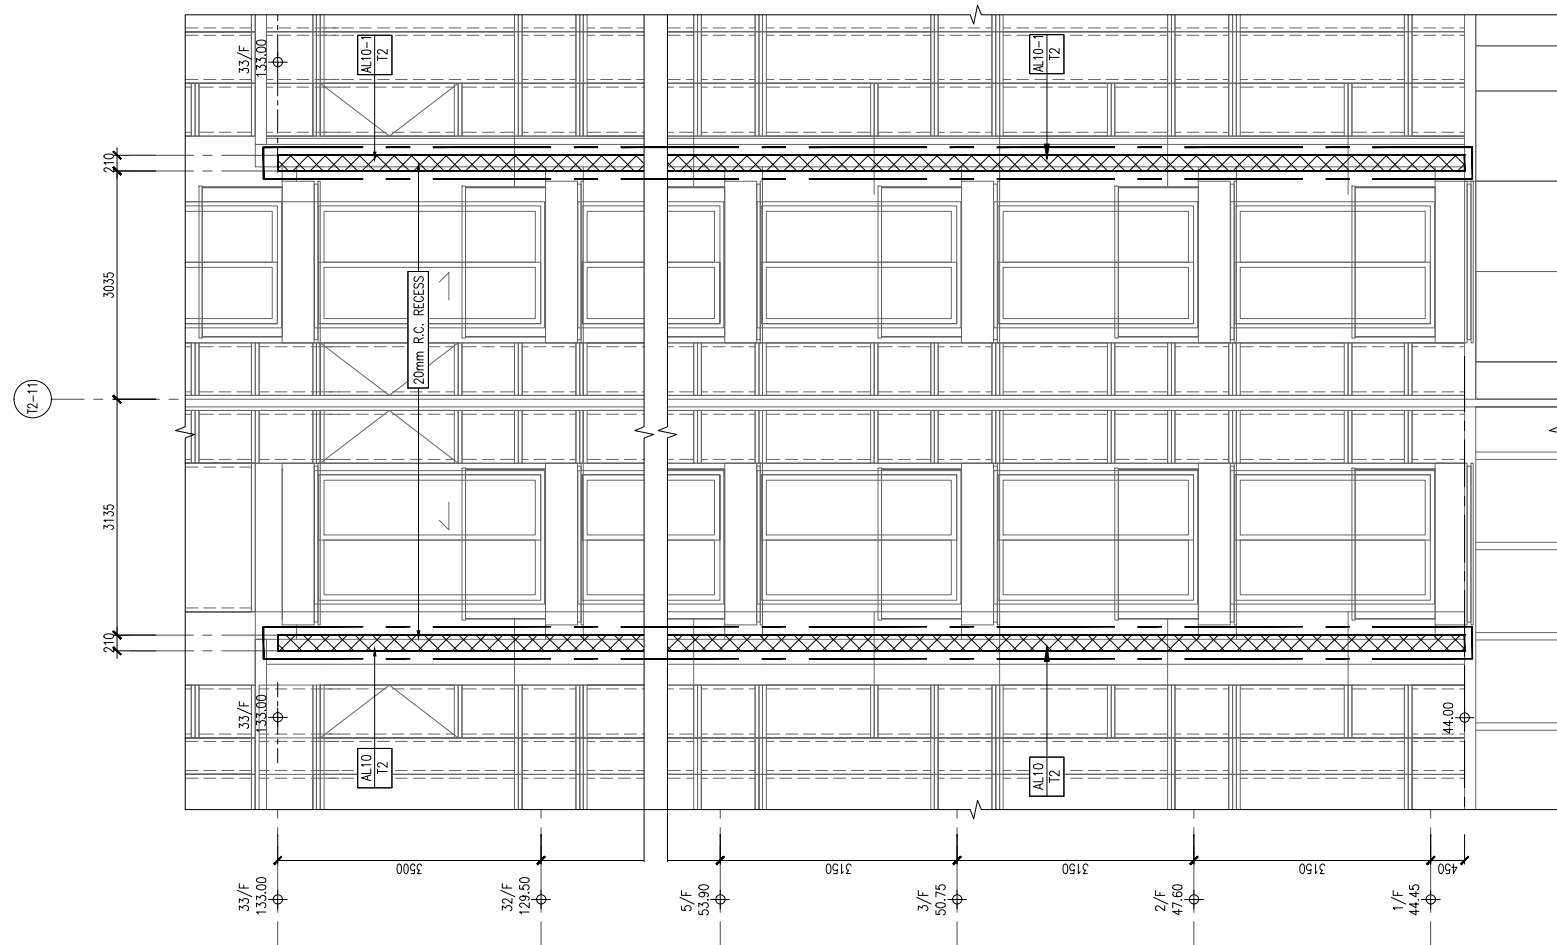

1 PARTIAL ELEVATION FOR R.C. RECESS

SCALE: 1 : 50

E-01.1

F.S.D. REF :
 Note :
 1. All dimensions are in mm.
 2. All elevations are viewed from outside.
 3. All dimensions to be verified on site before fabrication.

GENERAL NOTES

- Legend :**
- 1. F.F.L. -- Finished Floor Level
 - 2. S.F.L. -- Structural Floor Level
 - 3. (R) -- Reversed Detail
 - 4. MIR. -- Mirror



NO.	DATE	REVISED	BY
A	05-03-2020	R.C. RECESS ADDED	


CLIENT :
佳明集團控股有限公司
 GRAND MING GROUP HOLDINGS LIMITED

MAIN CONTRACTOR :
GRAND TECH CONSTRUCTION CO. LTD.

ARCHITECT :
WONG TUNG & PARTNERS LIMITED
 ARCHITECTS & PLANNERS



STRUCTURAL ENGINEER :
C M WONG & ASSOCIATES LTD



美特鋁質有限公司
 MIDI ALUMINIUM FABRICATOR LTD.
 Units 6-8, Sunray Industrial Centre, 1/F
 610 Cho Kwo Ling Road, Kowloon
 Tel: 23489211-4 Fax: (852) 27727666

PROJECT :
 RESIDENTIAL DEVELOPMENT AT
 TSING YI TOWN LOT 190 SAI SHAN ROAD

TITLE :
 KEY PLAN & PARTIAL ELEVATION
 FOR R.C. RECESS

JOB NO. :	J851
DRAWN BY :	DL
DATE :	18-11-2019
CHKD BY :	SCALE A1: AS SHOWN
DWG. NO. :	J851-ACF-E01.1
REV. :	A