

工程指示 / 要求簡箋(E.I.)

工程指示編號：EI / 0208 / 19

修改版次：-

工程編號：J - 837

工程名稱：觀塘裕民坊

工程項目：幕牆 Glass cladding 鐵件(A.F.位置用)(T1-T5 大貨鐵碼)

收件人：Maggie

發件人：Eric Liu

日期：01/02/2019

要求提供 / 確認 事項：

- | | | |
|------------------------------------|-------------------------------------|-------------------------------|
| <input type="checkbox"/> 初步鋁料 B.M. | <input type="checkbox"/> 加工拆圖，然後生產 | <input type="checkbox"/> 尺寸表 |
| <input type="checkbox"/> 正式鋁料 B.M. | <input type="checkbox"/> 技術上資料 / 指示 | <input type="checkbox"/> 報價 |
| <input type="checkbox"/> 配件 B.M. | <input type="checkbox"/> 樣辦或貨品說明書 | <input type="checkbox"/> 分判合約 |
| <input type="checkbox"/> 其他：_____ | | |

內容：

請按加工圖訂購 Glass cladding A.F.位置用鐵碼送地盤

1) 此為 Glass cladding A.F.位置用鐵碼大貨數量，其他 G.C.鐵碼大貨數已於 EI9943 出單

2) 因改分倉，鐵架要修改，待修改大圖後再出，先出鐵碼

謝謝！

請在 2019/ 2 / 18 前完成上列要求。

附：1 頁 B.M.，14 頁加工圖，~~14~~ 頁位置圖

以上項目為：

- 原合約工程包 原合約工程加 / 減賬 新工程報價

原因：-

分發東莞各部門：

- () 生產技術總監 連附件 () 技術部 連附件 ^永 () 生產部 連附件 () 機械設計部 連附件
 () 採購部 連附件 () 生產統籌部 連附件 ^梅
 () 質檢部 連附件 () 會計部 連附件 () 報關組 連附件 () 其他 楊榮輝 連附件
 分發其他分判：
 () 王禮秋 連附件

分發香港各部門：

- () 行政部 連附件 () 會計部 連附件 () 統籌部 連附件 () 工程部地盤科文 連附件 ^火
 () 採購部 連附件 () QS 部 連附件 () 維修部 連附件 () 其他 _____ 連附件

傳遞編號：

HK 0343 / 19

發件人簽署：


項目經理簽署：



美特鋁質有限公司
MIDI Aluminium Fabricator Ltd.

圖號	數量	位置	樓層	件層	樓層數	備註
GC-MD01A	36	TIGC-E	7F-0F	1	36	
工程號	J-837	地盤	觀塘裕民坊			

工程號	J-837	地盤	觀塘裕民坊
-----	-------	----	-------

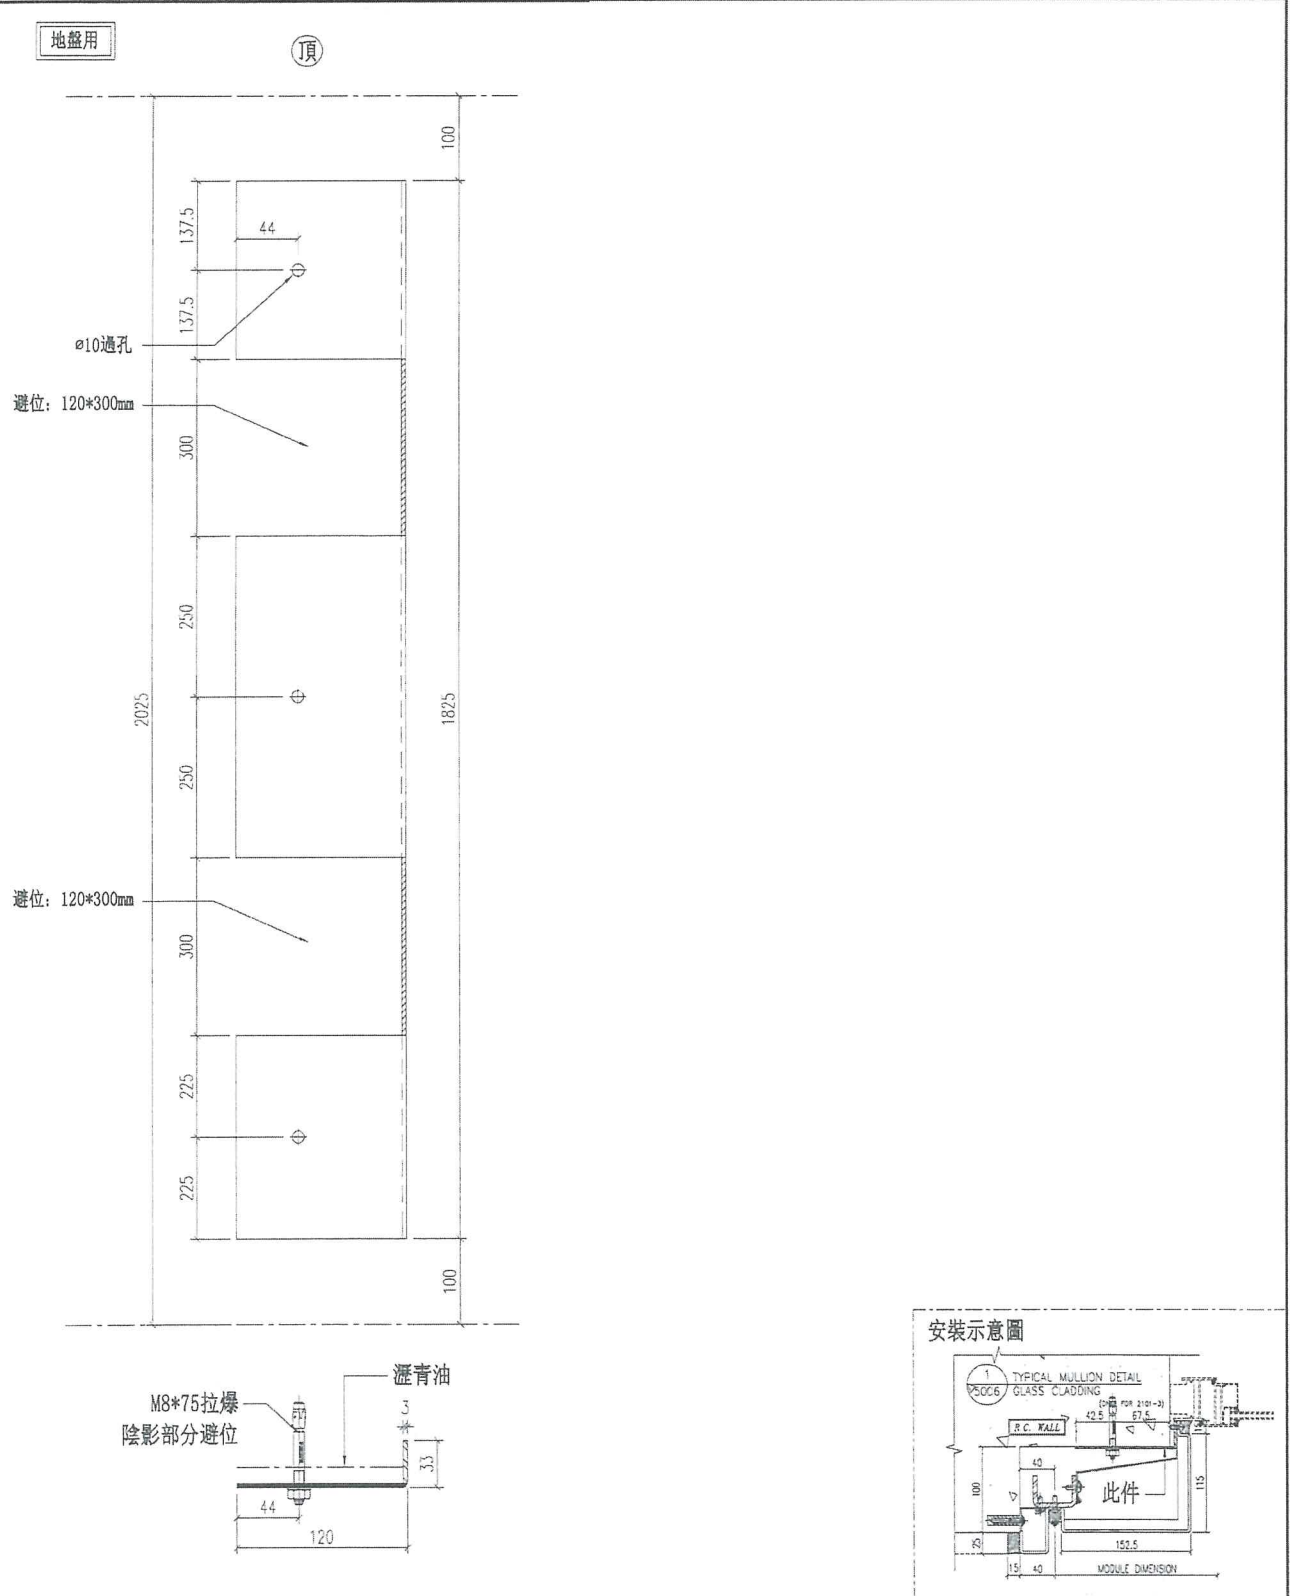




名稱	鐵角拆圖	制圖	羅志光	2018.11.19	修改	
材料	33*120*3鐵角	復核	謝永林		日期	
顏色	熱浸鋅+瀝青油	批准			圖號	GC-MD01A ✓

圖號	數量	位置	樓層	件/層	樓層數	備註
GC-MD02A	8	TIGC-E	7F-9F	1	8	
	36		10-30/F		36	

工程號 J-837 地盤 觀塘裕民坊

地盤用

頂

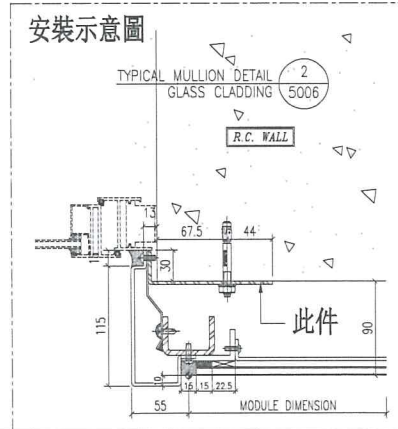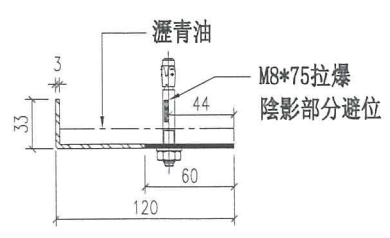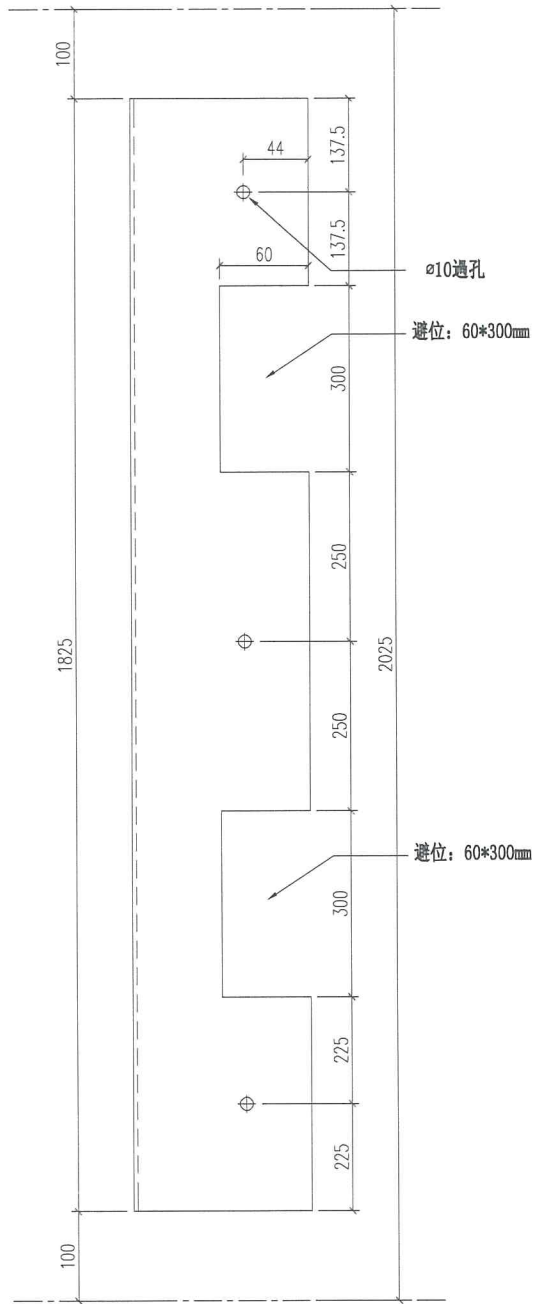

名稱	鐵角拆圖	制圖	羅志光	2018. 11. 19	修改		
材料	33*120*3鐵角	復核	謝永林		日期		
顏色	熱浸鋅+瀝青油	批准			圖號	GC-MD02A ✓	②





美特鋁質 有限公司
MIDI Aluminium Fabricator Ltd.


圖號	數量	位置	樓層	件/層	樓層數	備註
GC-MD05A	8	T2GC-M	7F-9F	1	8	
工程號	J-837	地盤	觀塘裕民坊	40	10-55F	40

地盤用

頂

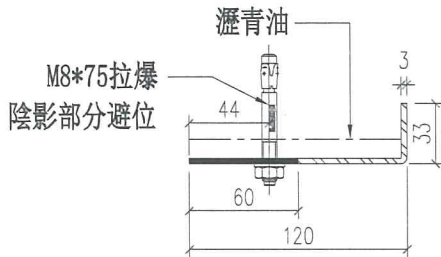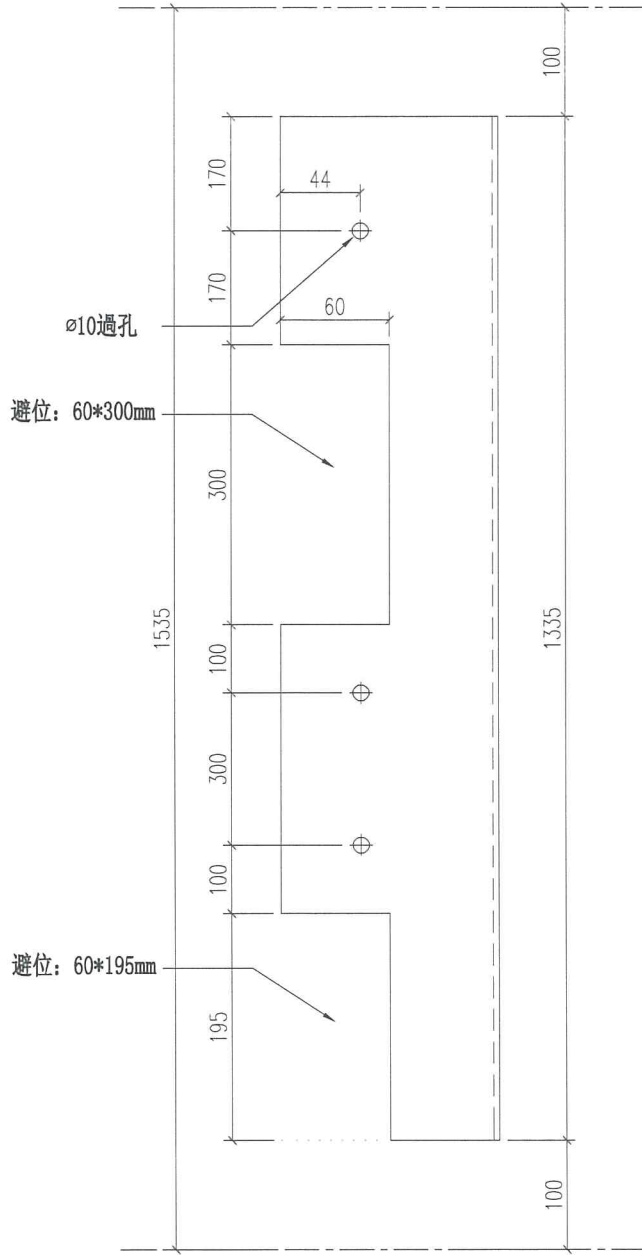

安裝示意圖

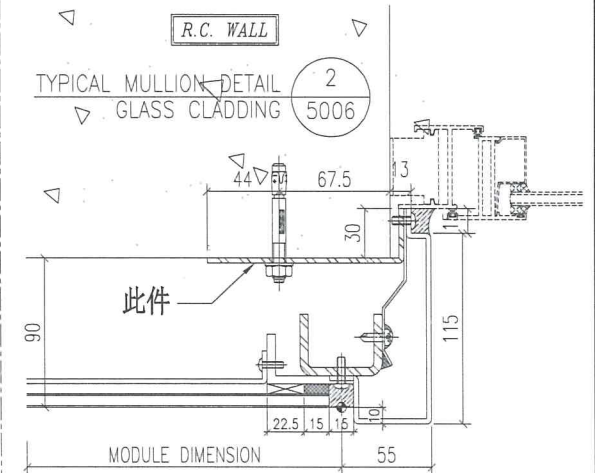

名稱	鐵角拆圖	制圖	羅志光	2018. 11. 19	修改		
材料	33*120*3鐵角	復核	謝永林		日期		
顏色	熱浸鋅	批准			圖號	GC-MD05A ✓	⑤






美特鋁質 有限公司
MIDI Aluminium Fabricator Ltd.

圖號	數量	位置	樓層	件/層	樓層數	備註
GC-MD06A	3	T2GC-M	7F-9F	1	3	
	40		1055F		40	

工程號 J-837 地盤 觀塘裕民坊

地盤用

頂

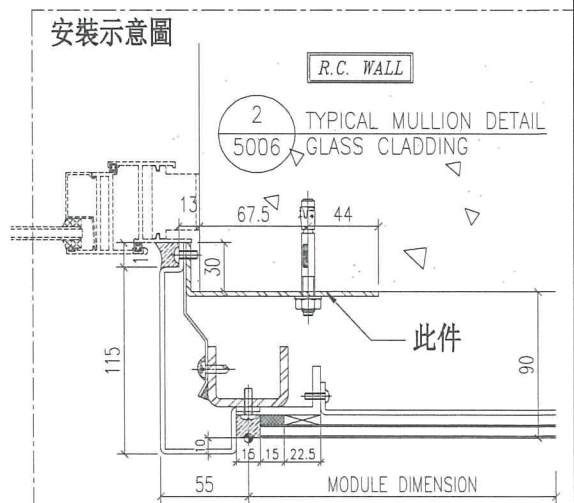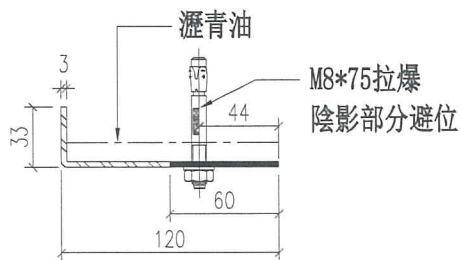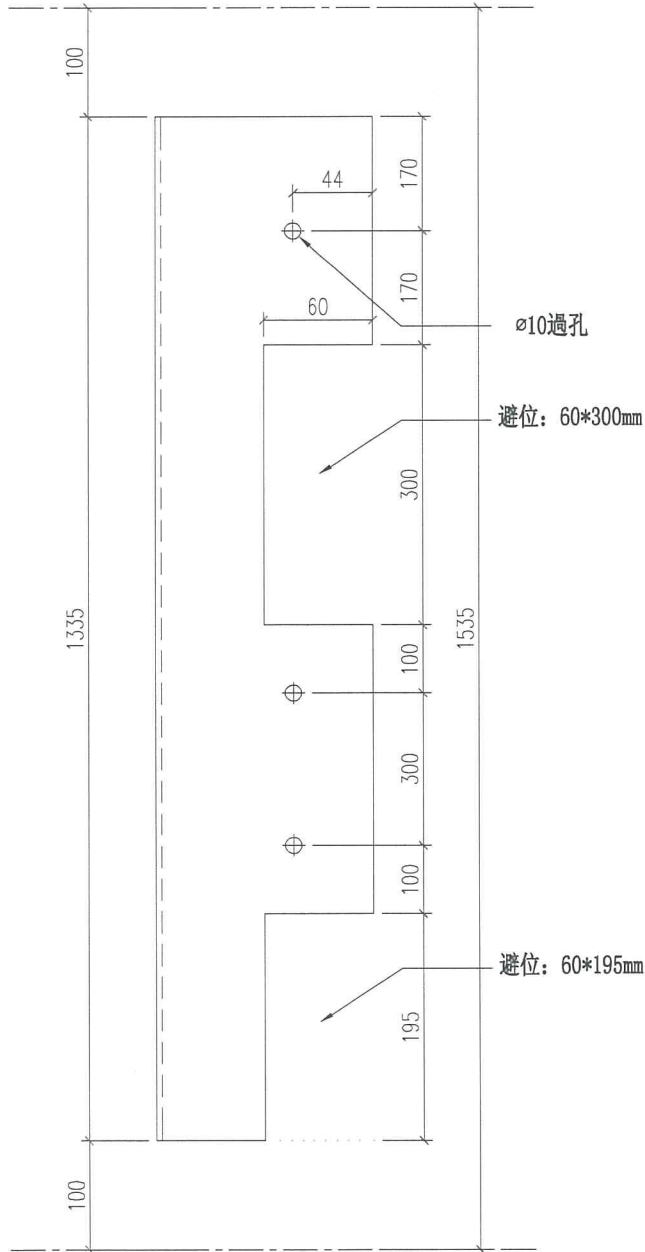

名稱	鐵角拆圖	制圖	羅志光	2018. 11. 19	修改		
材料	33*120*3鐵角	復核	謝永林		日期		
顏色	熱浸鋅	批准			圖號	GC-MD06A ✓	(4)





美特鋁質 有限公司
MIDI Aluminium Fabricator Ltd.

圖號	數量	位置	樓層	件/層	樓層數	備註
GC-MD07B	3	T2GC-M	7F-9F	1	3	
	40		10-55F		40	


工程號 J-837 地盤 觀塘裕民坊

地盤用

頂

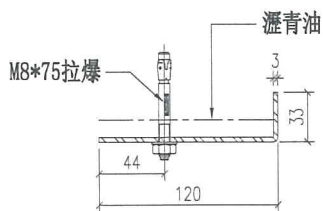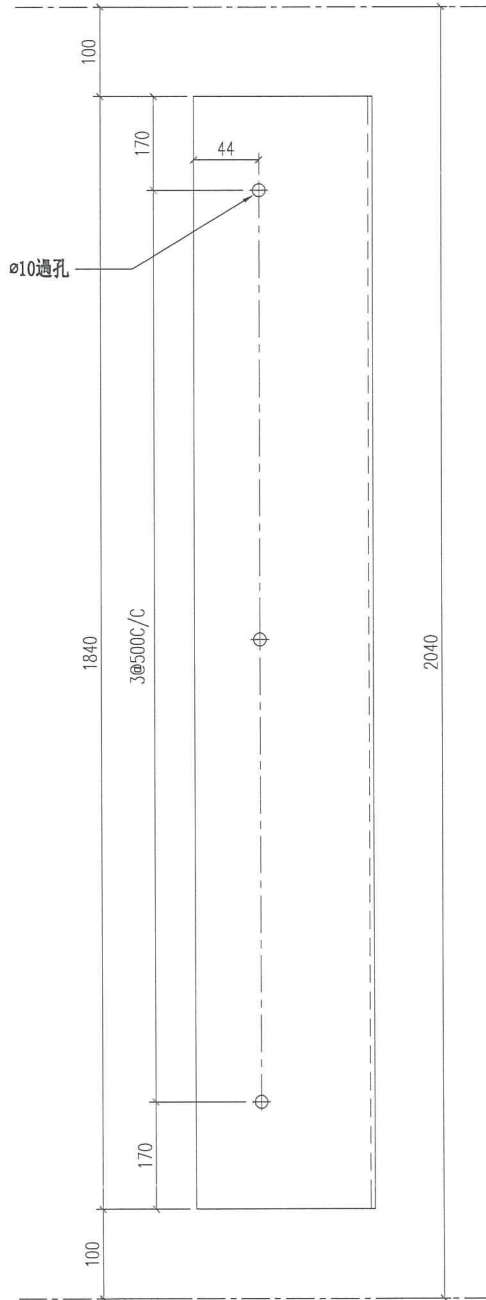

安裝示意圖

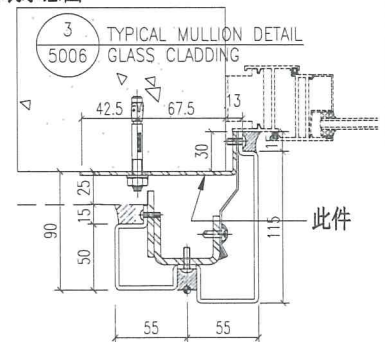

名稱	鐵角拆圖	制圖	羅志光	2018. 11. 19	修改	
材料	33*120*3鐵角	復核	謝永林		日期	
顏色	熱浸鋅+瀝青油	批准			圖號	GC-MD07B ✓ (5)





美特鋁質有限公司
MIDI Aluminium Fabricator Ltd.

圖號	數量	位置	樓層	件/層	樓層數	備註
GC-MD08A	3	T2GC-M	7F-9F	1	3	
	40		10-55/F		40	


工程號 J-837 地盤 觀塘裕民坊

地盤用

頂

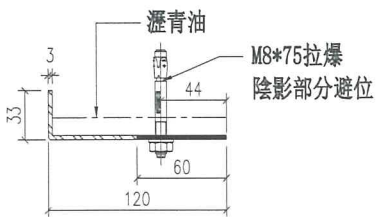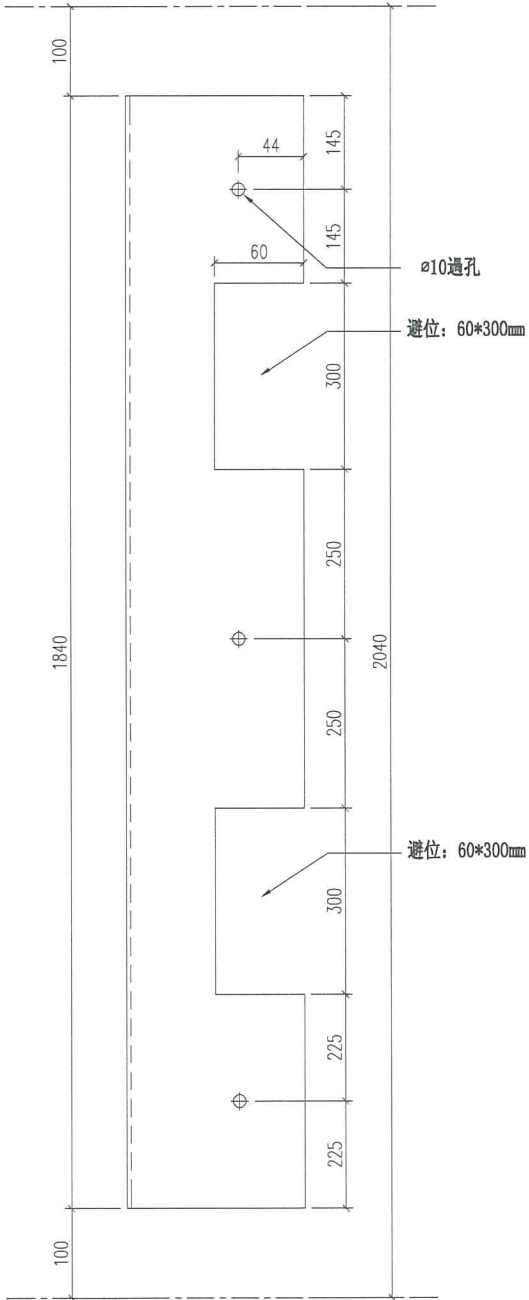

安裝示意圖

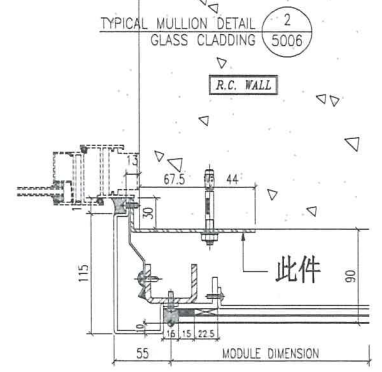

名稱	鐵角拆圖	制圖	羅志光	2018. 11. 19	修改		
材料	33*120*3鐵角	復核	謝永林		日期		
顏色	熱浸鋅+瀝青油	批准			圖號	GC-MD08A ✓	⑥





美特鋁質有限公司
MIDI Aluminium Fabricator Ltd.


工程號 J-837 地盤 觀塘裕民坊

地盤用

頂

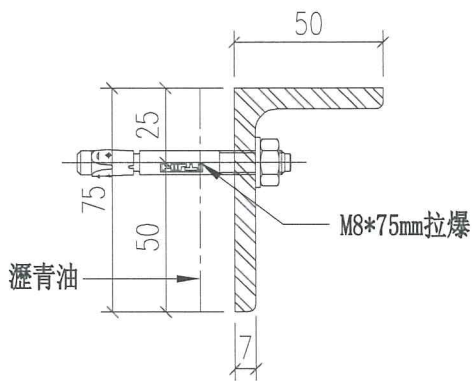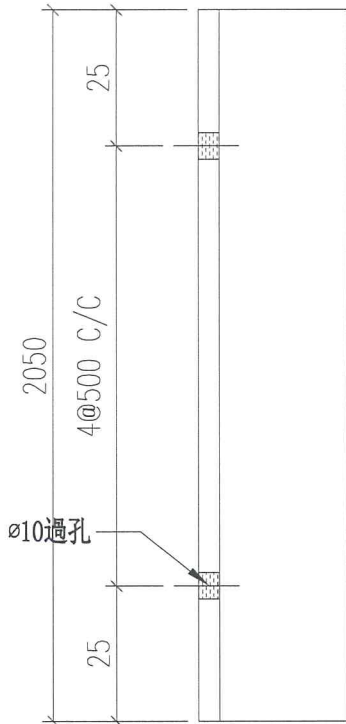

圖號	數量	位置	樓層	件/層	樓層數	分格
GC-DJ01	236	T1GC-H	7E-9F10-50	1	236	2250
	236	T1GC-G	7E-9F10-50	1	236	2250
	236	T1GC-B	7E-9F10-50	1	236	2250
	240	T2GC-B	7E-9F10-55	1	240	2250
	240	T2GC-A	7E-9F10-55	1	240	2250
	238	T3GC-B	7E-9F10-52	1	238	2250
	238	T3GC-A	7E-9F10-52	1	238	2250
小計:	21264					
後備:	0					
合計:	21264					

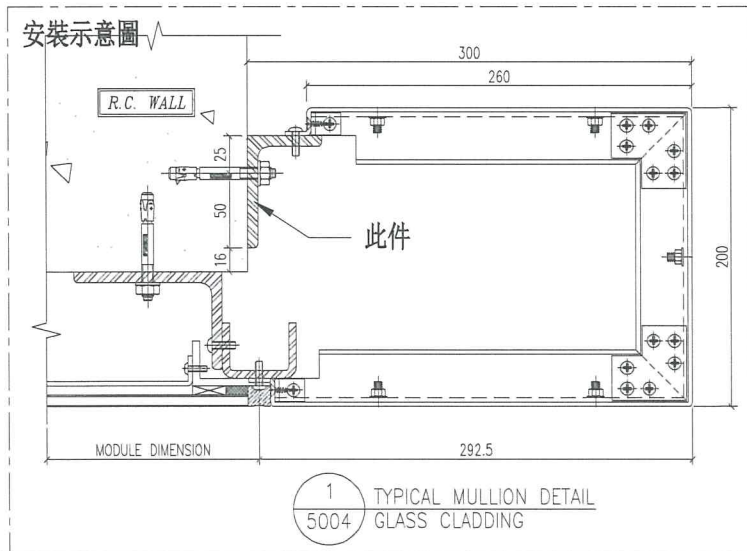



名稱	鐵角拆圖	制圖	羅志光	2018.11.17	修改		
材料	75*50*7mm鐵角	復核	謝永林		日期		
顏色	熱浸鋅+瀝青油	批准			圖號	GC-DJ01	✓ (7)




美特鋁質 有限公司
MIDI Aluminium Fabricator Ltd.

工程號 J-837 地盤 觀塘裕民坊

地盤用

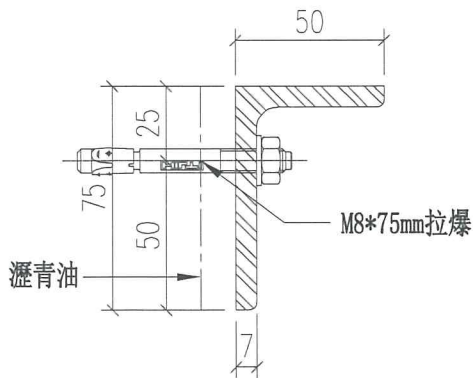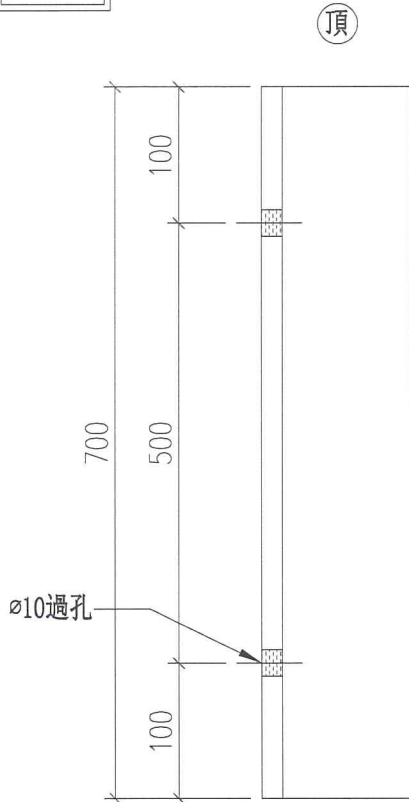

圖號	數量	位置	樓層	件/層	樓層數	分格
GC-DJ02	836	T1GC-H	7F-9F/10-50	1	836	900
	836	T1GC-G	7F-9F/10-50	1	836	900
	836	T1GC-B	7F-9F/10-50	1	836	900
	840	T2GC-B	7F-9F/10-55	1	840	900
	840	T2GC-A	7F-9F/10-55	1	840	900
	838	T3GC-B	7F-9F/10-52	1	838	900
	838	T3GC-A	7F-9F/10-52	1	838	900
小計:	25264					
後備:	0					
合計:	25264					

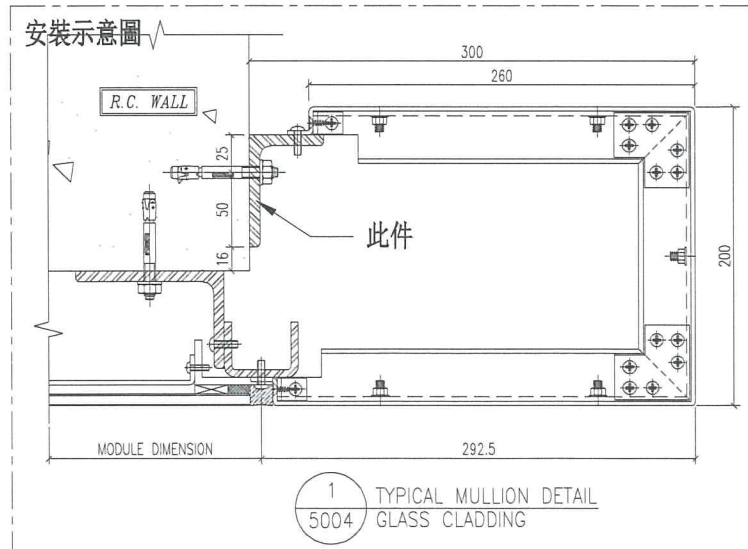

名稱	鐵角拆圖	制圖	羅志光	2018. 11. 17	修改		
材料	75*50*7mm鐵角	復核	謝永林		日期		
顏色	熱浸鋅+瀝青油	批准			圖號	GC-DJ02	8




美特鋁質 有限公司
MIDI Aluminium Fabricator Ltd.



工程號 J-837 地盤 觀塘裕民坊

圖號	數量	位置	樓層	件/層	樓層數
GC-EJ01	12148	T5GC-M	7E-9F1051	4	3/37
	12148	T5GC-L	7E-9F1051	4	3/37
合計:		24296			

地盤用

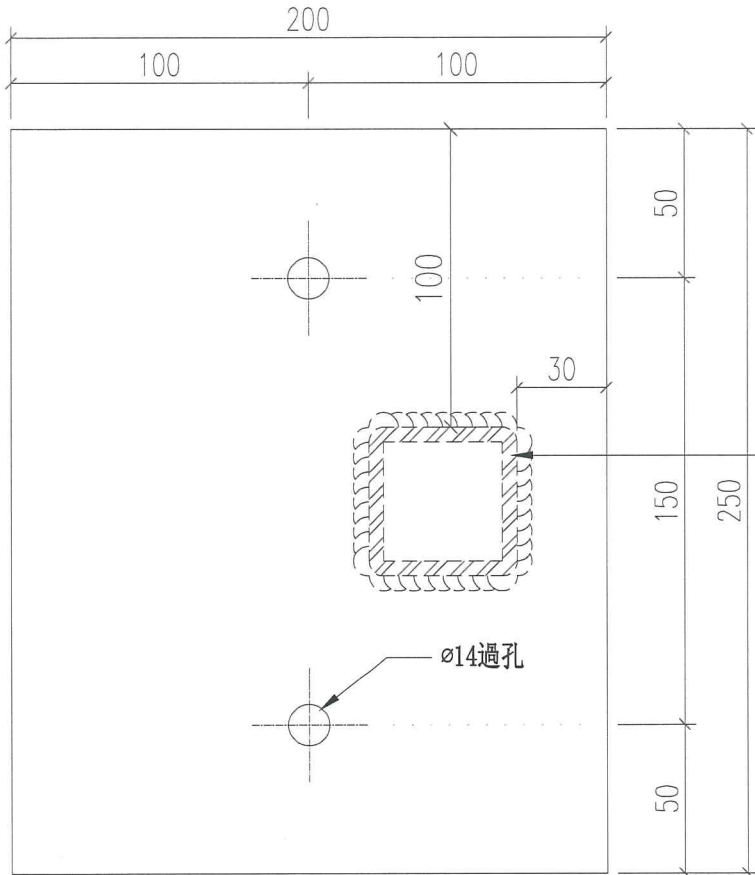

鐵通見: GC-EJ02
地盤燒焊

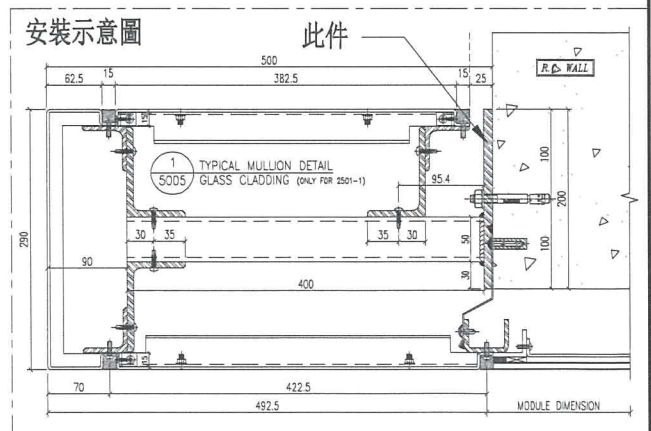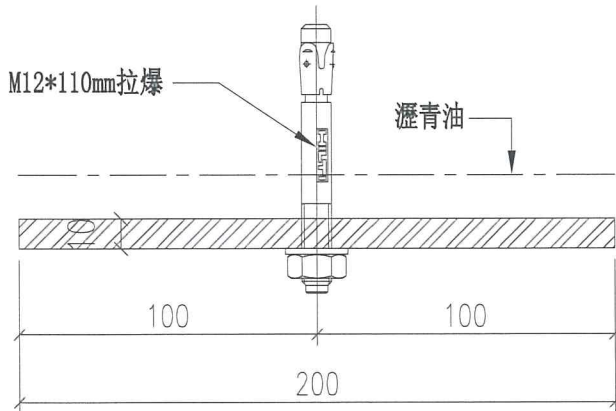

名稱	鐵巴拆圖	制圖	羅志光	2018. 11. 17	修改		
材料	200*10mm鐵巴	復核	謝永林		日期		
顏色	熱浸鋅+瀝青油	批准			圖號	GC-EJ01	✓ (9)





美特鋁質 有限公司
MIDI Aluminium Fabricator Ltd.

工程號 J-837 地盤 觀塘裕民坊


圖號	數量	位置	樓層	件/層	樓層數
GC-HJ01	12	T5GC-H	2E-9F/051	4	337
	148				
合計:	12				
	148				

地盤用

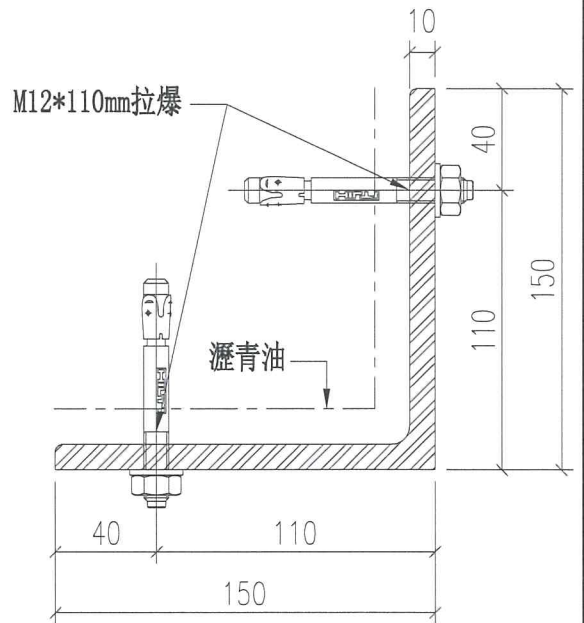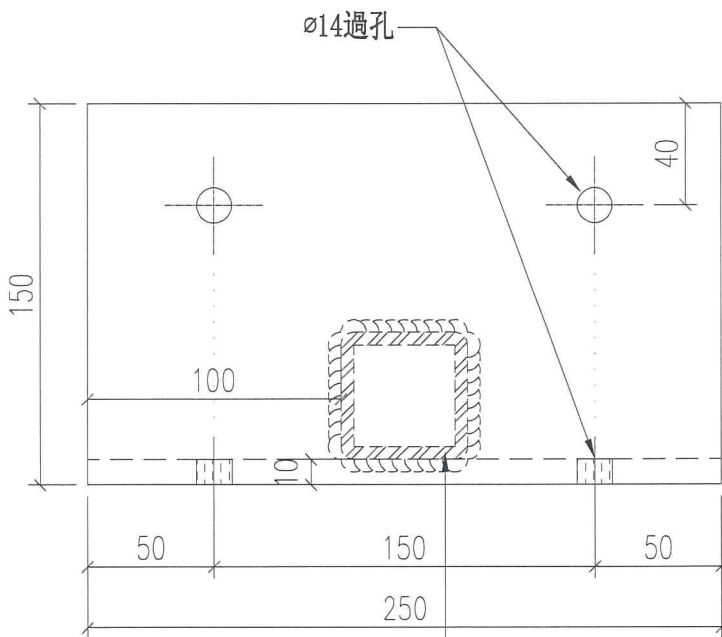

鐵通見: GC-HJ02
地盤燒焊

安裝示意圖

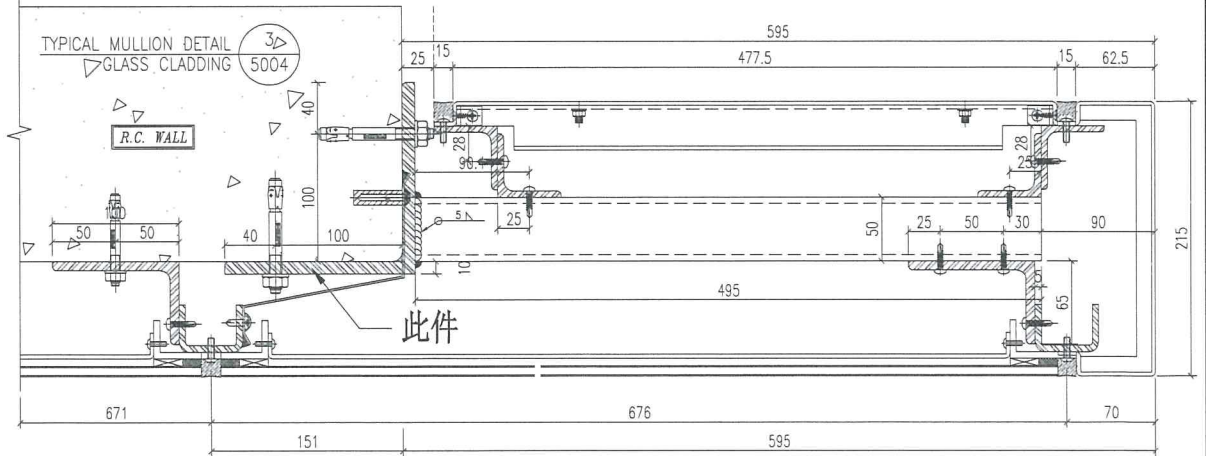

名稱	鐵角拆圖	制圖	羅志光	2018. 11. 17	修改		
材料	150*150*10mm鐵角	復核	謝永林		日期		
顏色	熱浸鋅+瀝青油	批准			圖號	GC-HJ01	✓ (10)





美特鋁質有限公司
MIDI Aluminium Fabricator Ltd.


工程號 J-837 地盤 觀塘裕民坊

地盤用

頂

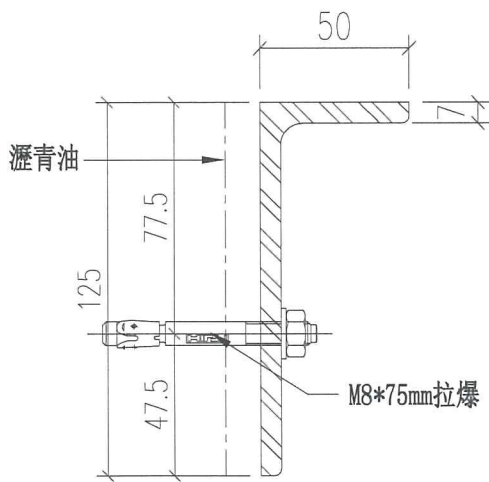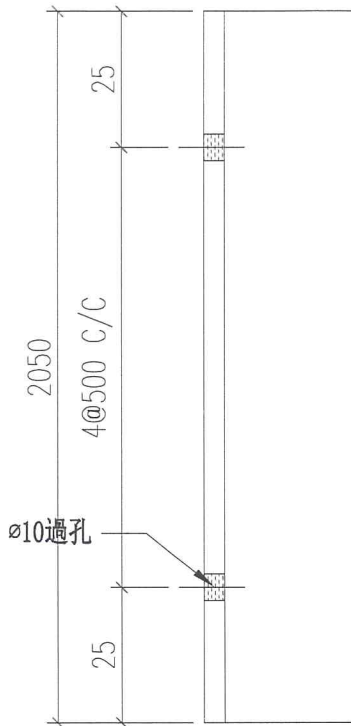

安裝示意圖

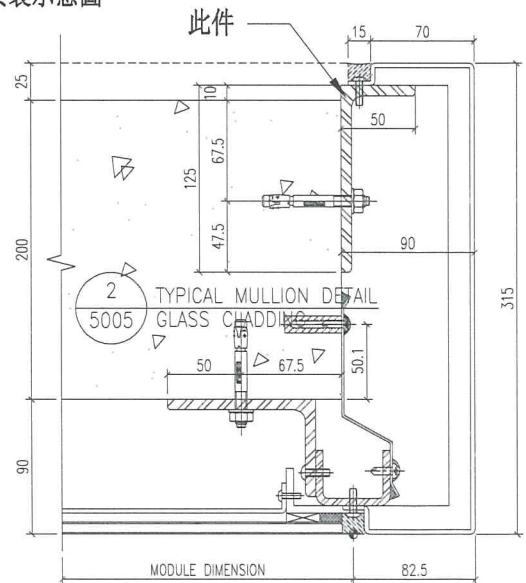

圖號	數量	位置	樓層	件/層	樓層數	分格
GC-KJ01	3	T2GC-M	7E-9F	1	3	2250
	40		10-55/F		40	
小計:	340					
後備:	0					
合計:	340					

名稱	鐵角拆圖	制圖	羅志光	2018. 11. 17	修改		
材料	125*50*7mm鐵角	復核	謝永林		日期		
顏色	熱浸鋅+瀝青油	批准			圖號	GC-KJ01	✓





美特鋁質有限公司
MIDI Aluminium Fabricator Ltd.


工程號 J-837 地盤 觀塘裕民坊

地盤用

頂

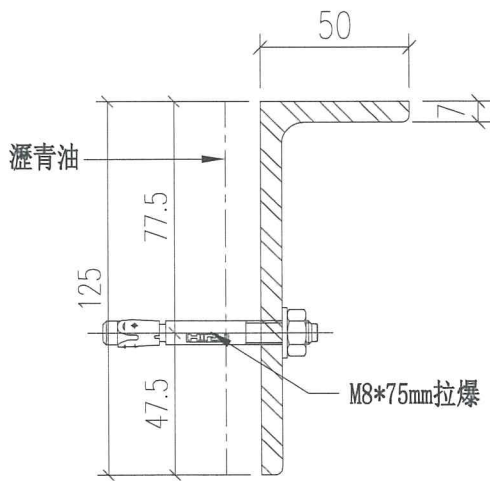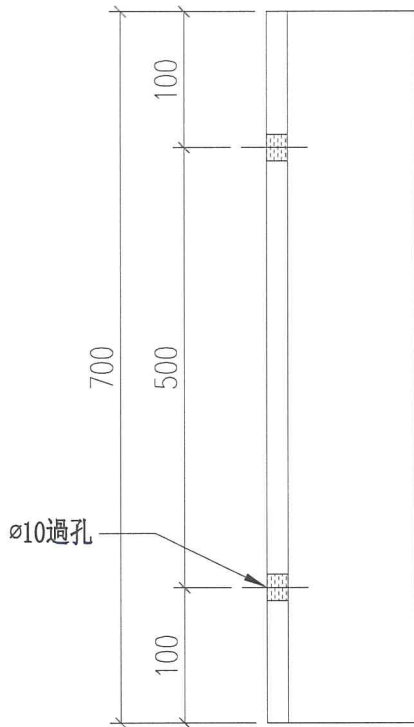

安裝示意圖

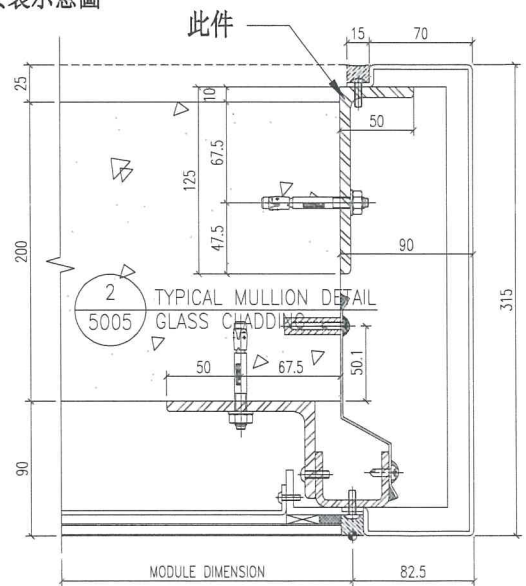

圖號	數量	位置	樓層	件/層	樓層數	分格
GC-KJ02	3	T2GC-M	7F-9F	1	3	900
	40		10-55		40	
小計:	340					
後備:	0					
合計:	340					

名稱	鐵角拆圖	制圖	羅志光	2018.11.17	修改		
材料	125*50*7mm鐵角	復核	謝永林		日期		
顏色	熱浸鋅+瀝青油	批准			圖號	GC-KJ02	

12





美特鋁質 有限公司
MIDI Aluminium Fabricator Ltd.

工程號 J-837 地盤 觀塘裕民坊


圖號	數量	L	EQ	N	M	位置	樓層	件/層	樓層數	分格	備註
GC-T02M-04a	340	932	216	1	500	T2GC-M	7F-9F	1	340	1010	
GC-T02M-07a	340	622	61	1	500	T2GC-M	7F-9F	1	340	700	
							10-55				

地盤用

共 801 件

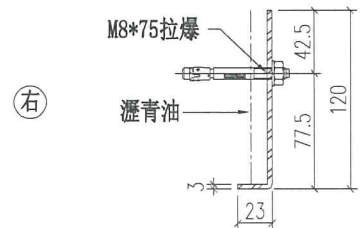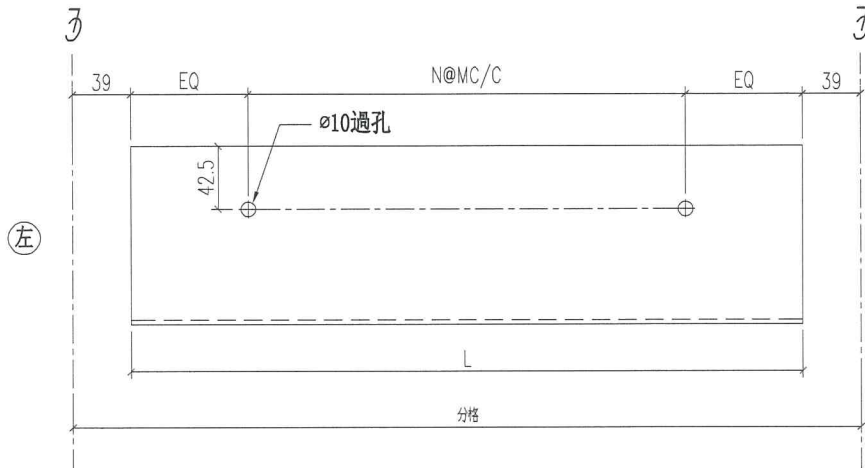


安裝示意圖

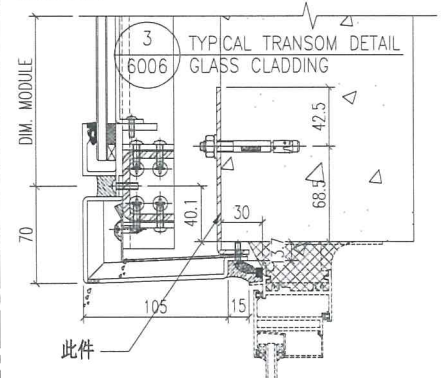

名稱	鐵角拆圖	制圖	羅志光	2018. 11. 19	修改		
材料	23*120*3鐵角	復核	謝永林		日期		
顏色	熱浸鋅+瀝青油	批准			圖號	GC-T02M-04a	

13


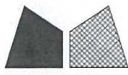


美特鋁質 有限公司
MIDI Aluminium Fabricator Ltd.

工程號 J-837 地盤 觀塘裕民坊



圖號	數量	L	EQ	N	M	位置	樓層	件/層	樓層數	分格	備註
GC-T02M-04b	349	932	216	1	500	T2GC-M	7F-9F	1	349	1010	
GC-T02M-07b	349	622	61	1	500	T2GC-M	7F-9F	1	349	700	
							10-55				
合計:	6										

地盤用

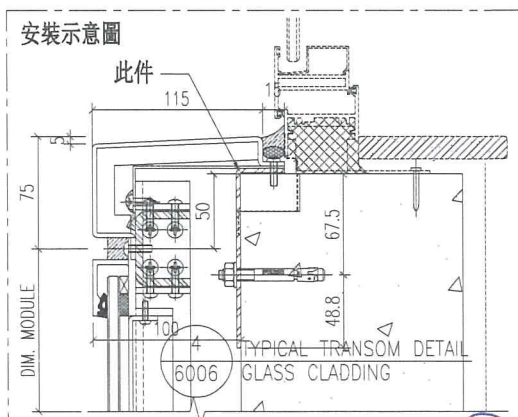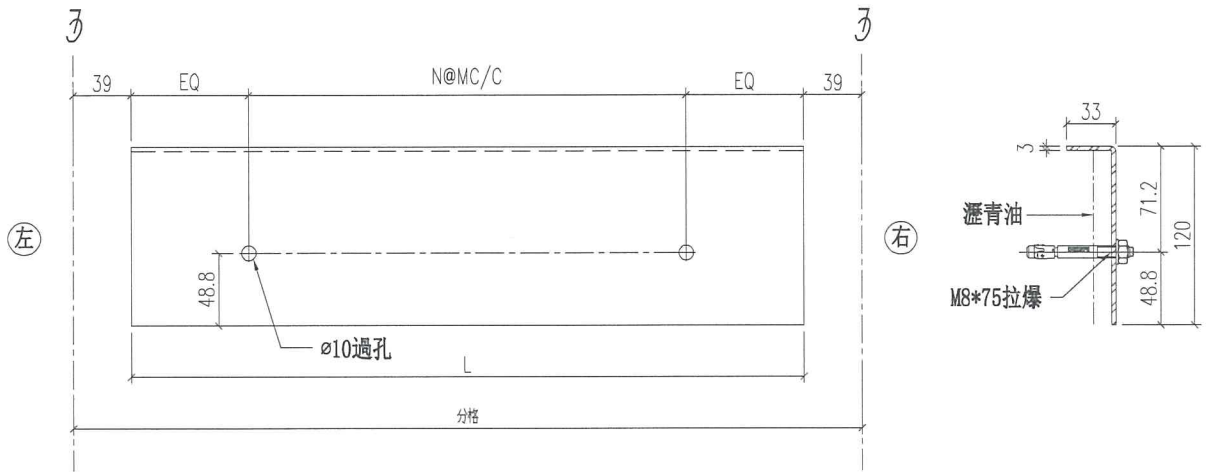

名稱	鐵角拆圖	制圖	羅志光	2018. 11. 19	修改	
材料	33*120*3鐵角	復核	謝永林		日期	
顏色	熱浸鋅+瀝青油	批准			圖號	GC-T02M-04b ✓

14

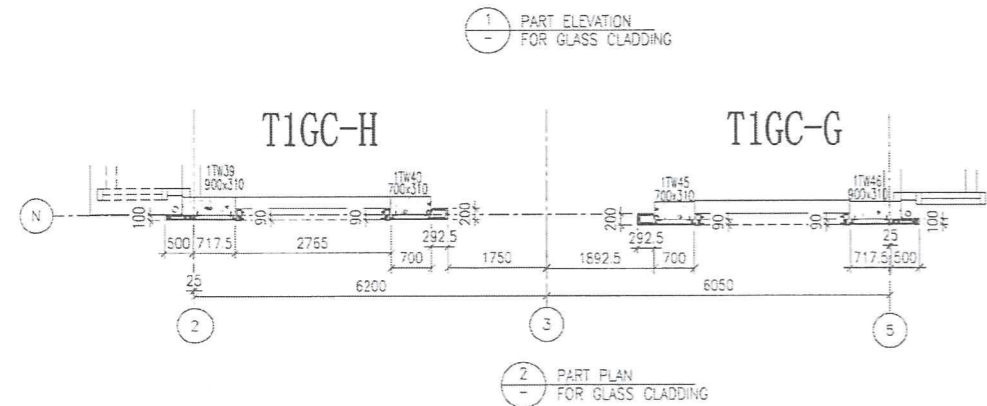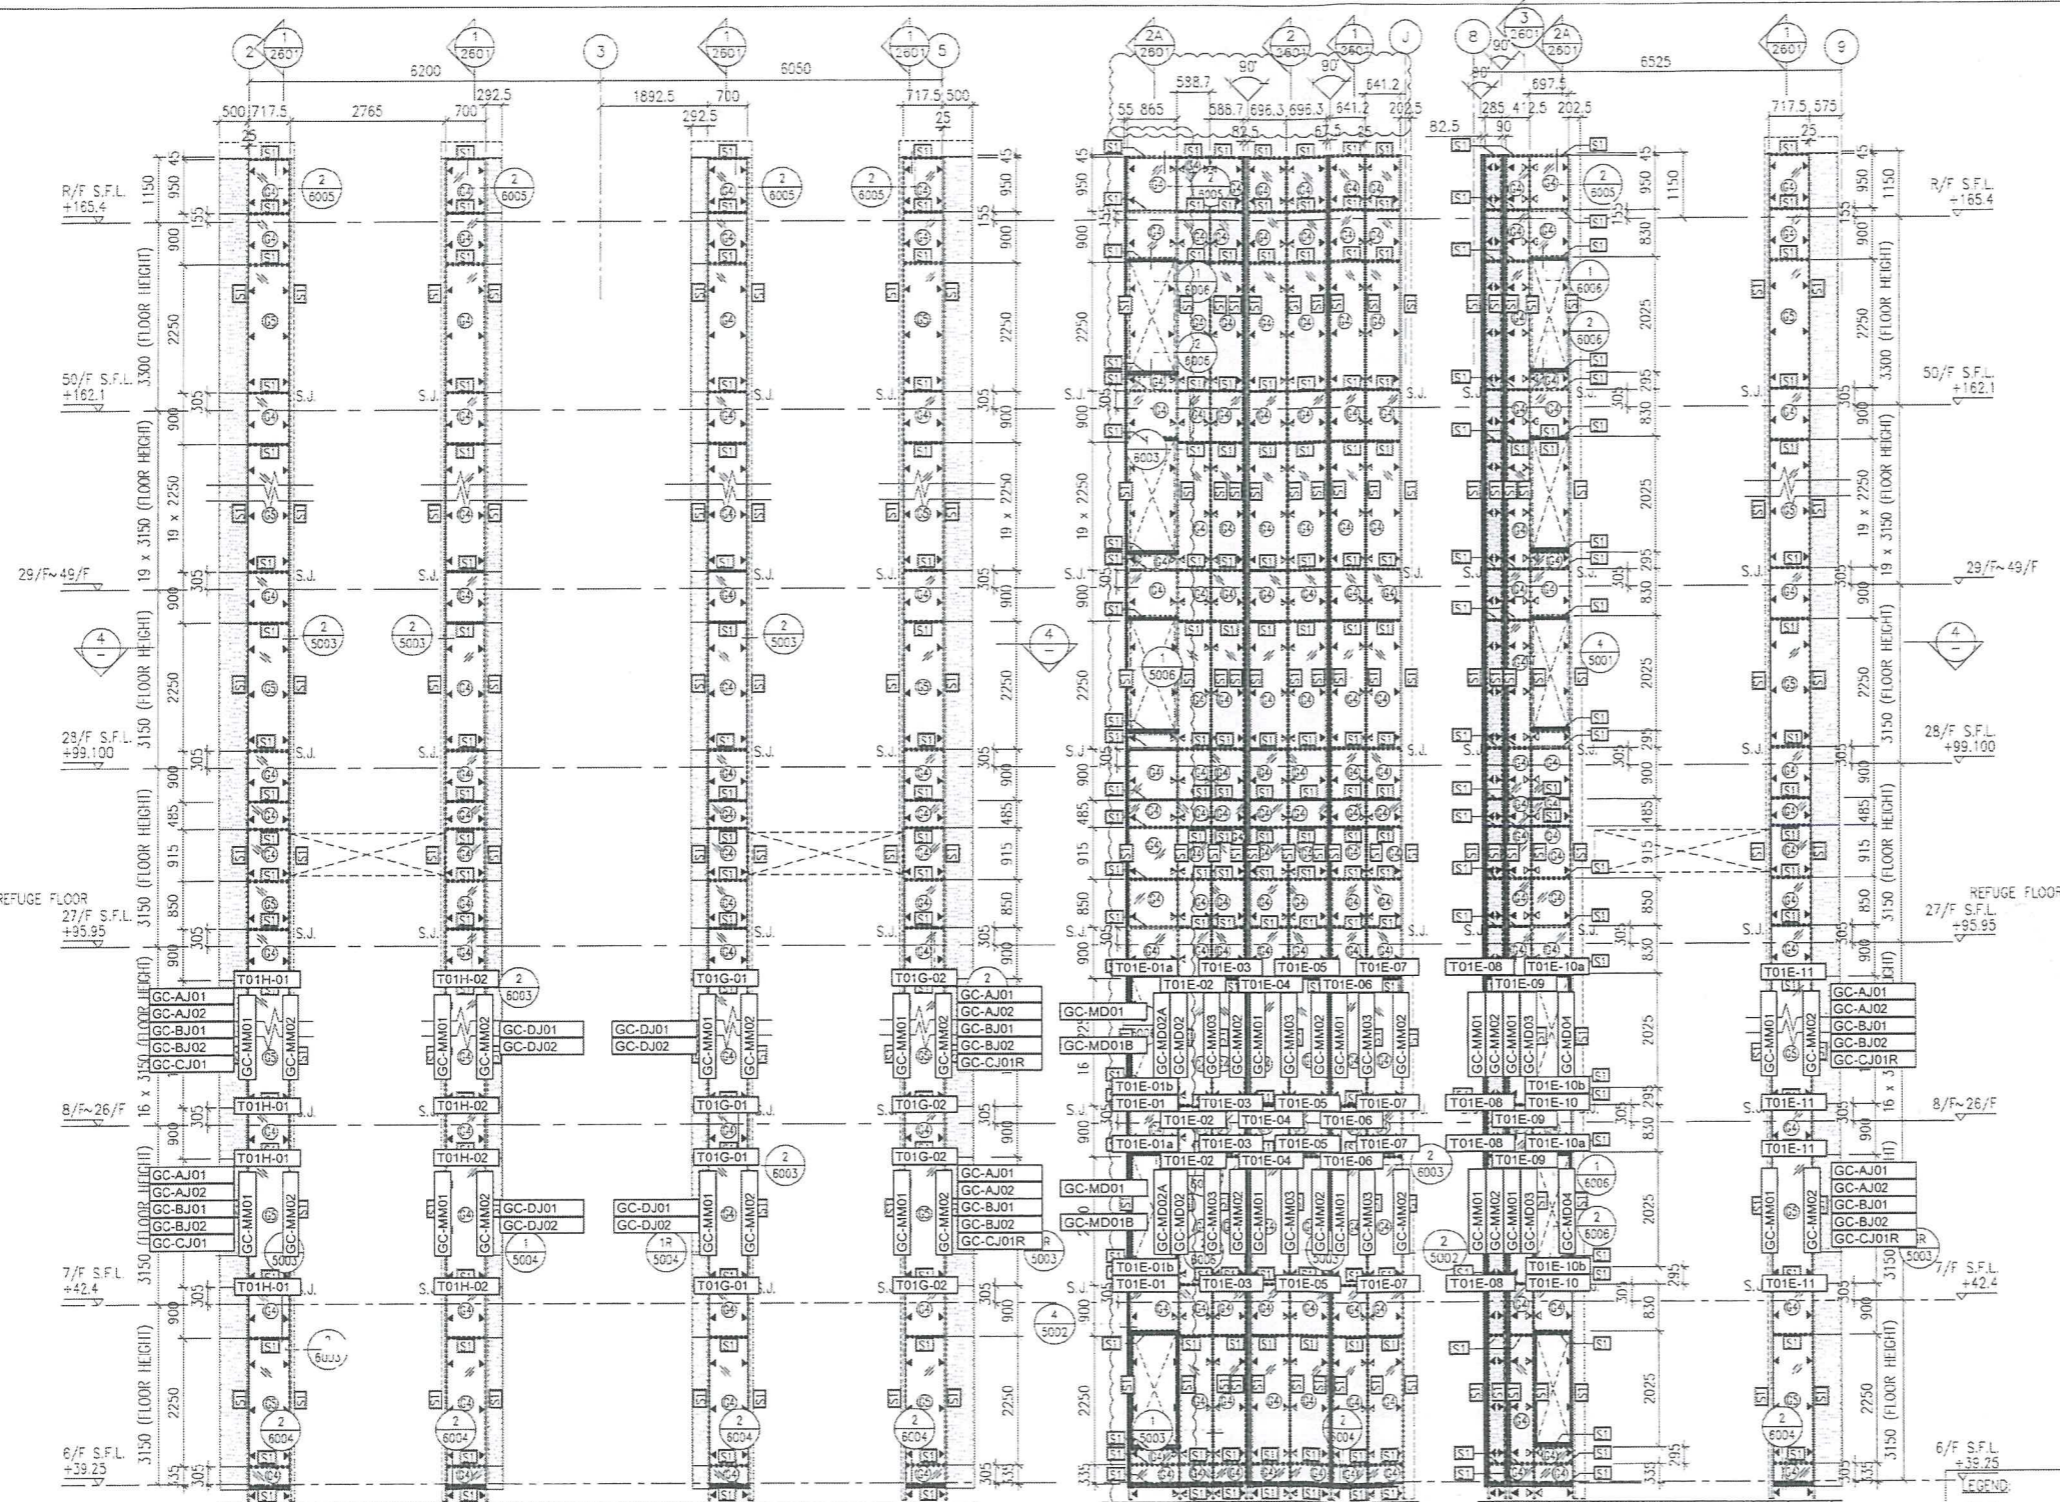

- LEGEND:**
- 50x37x5mm THK. G.M.S. CHANNEL (CUT FROM 100x50x5mm THK. G.M.S. R.H.S.)
 - 8 mm THK. HEAT STRENGTHENED BLUE TINTED GLASS (SPANDREL GLASS)
 - 8 mm THK. TEMPERED BLUE TINTED GLASS
 - 100x65x8mm THK. G.M.S. ANGLE BRACKET (L=250mm) W/ 2 NOS-HLTI HST3-R MB ANCHOR BOLT (MAX. @900c/c)
 - 100x65x8mm THK. G.M.S. ANGLE BRACKET (L=200mm) W/ 1 NO-HLTI HST3-R MB ANCHOR BOLT (MAX. @900c/c)
 - 100x50x6mm THK. G.M.S. ANGLE BRACKET (L=250mm) W/ 2 NOS-HLTI HST3-R MB ANCHOR BOLT (@900c/c)
 - 100x50x6mm THK. G.M.S. ANGLE BRACKET (L=250mm) W/ 2 NOS-Y12 STEEL BAR (BOND LENGTH=200mm)
 - 100x50x6mm THK. G.M.S. ANGLE BRACKET (L=200mm) W/ 1 NO-Y12 STEEL BAR (BOND LENGTH=200mm)
 - STACK JOINT
 - 3 mm THK. ALUM. CLADDING

B.D. REF :

CLIENT : 信和置業有限公司
Sino Land Company Limited

ARCHITECT : WONG TUNG & PARTNERS LIMITED
ARCHITECTS & PLANNERS

MAIN CONTRACTOR : CR Construction Company Limited

STRUCTURAL ENGINEER : AECOM

FAÇADE CONSULTANT : AECOM

NOTE :

- ALL DIMENSIONS ARE IN mm.
- ALL ELEVATIONS ARE VIEWED FROM OUTSIDE.
- ALL DIMENSIONS TO BE VERIFIED ON SITE BEFORE FABRICATION.

LEGEND :

- DETAIL MARK NO.
- REFER SHEET NO.
- F.F.L. --- FINISHED FLOOR LEVEL
- S.F.L. --- STRUCTURAL FLOOR LEVEL
- REVERSED DETAIL

B	17/11/2018	GENERAL REVISED
A	15/10/2018	GENERAL REVISED
NO	DATE	REVISED

JOB NO. : J-837

PROJECT : URA KWUN TONG TOWN CENTRE REDEVELOPMENT (AREA 2 & 3) AT NKIL 6514, KWUN TONG, KWLOON

TITLE : PART ELEVATION OF GLASS CLADDING AT TOWER 1

DATE : 04-JUL-18 SCALE : 1:60 (A1)

DRAWN BY : ASING CHECKED BY : -


美特鋁質有限公司
MIDI ALUMINIUM FABRICATOR LTD.
Units 6-8, Sunray Industrial Centre, 1/F
610 Ono Kwo Ling Road, Kowloon
Tel: 23489211-4 Fax: (852) 2727666


DWG NO. : JS37-GC-2101 REV. : B

B.D. REF :

CLIENT :
 信和置業有限公司
 Sino Land Company Limited

ARCHITECT :
 WONG TUNG & PARTNERS LIMITED
 ARCHITECTS & PLANNERS


MAIN CONTRACTOR :
 CR Construction Company Limited

STRUCTURAL ENGINEER :
 AECOM

FACADE CONSULTANT:
 AECOM

NOTE :
 1. ALL DIMENSIONS ARE IN mm.
 2. ALL ELEVATIONS ARE VIEWED FROM OUTSIDE.
 3. ALL DIMENSIONS TO BE VERIFIED ON SITE BEFORE FABRICATION.

LEGEND :
 (X1) --- DETAIL MARK NO.
 (X00) --- REFER SHEET NO.
 1. F.F.L --- FINISHED FLOOR LEVEL
 2. S.F.L --- STRUCTURAL FLOOR LEVEL
 3. (R) --- REVERSED DETAIL

NO.	DATE	REVISION	BY
B	17/11/2018	GENERAL REVISED	
A	15/10/2018	GENERAL REVISED	



JOB NO. : J-B37
 PROJECT :
 URA KWUN TONG TOWN CENTRE
 REDEVELOPMENT (AREA 2 & 3) AT
 NKIL 6514, KWUN TONG, KWLOON











TITLE :
 PART ELEVATION
 OF GLASS CLADDING
 AT TOWER 1

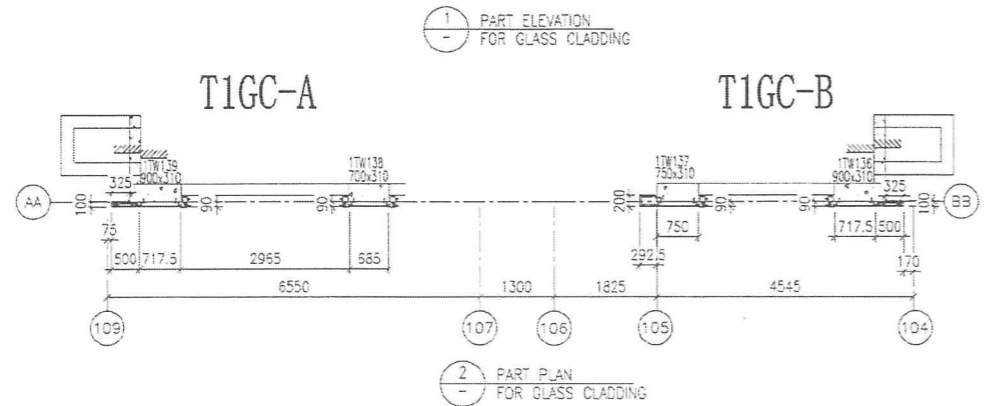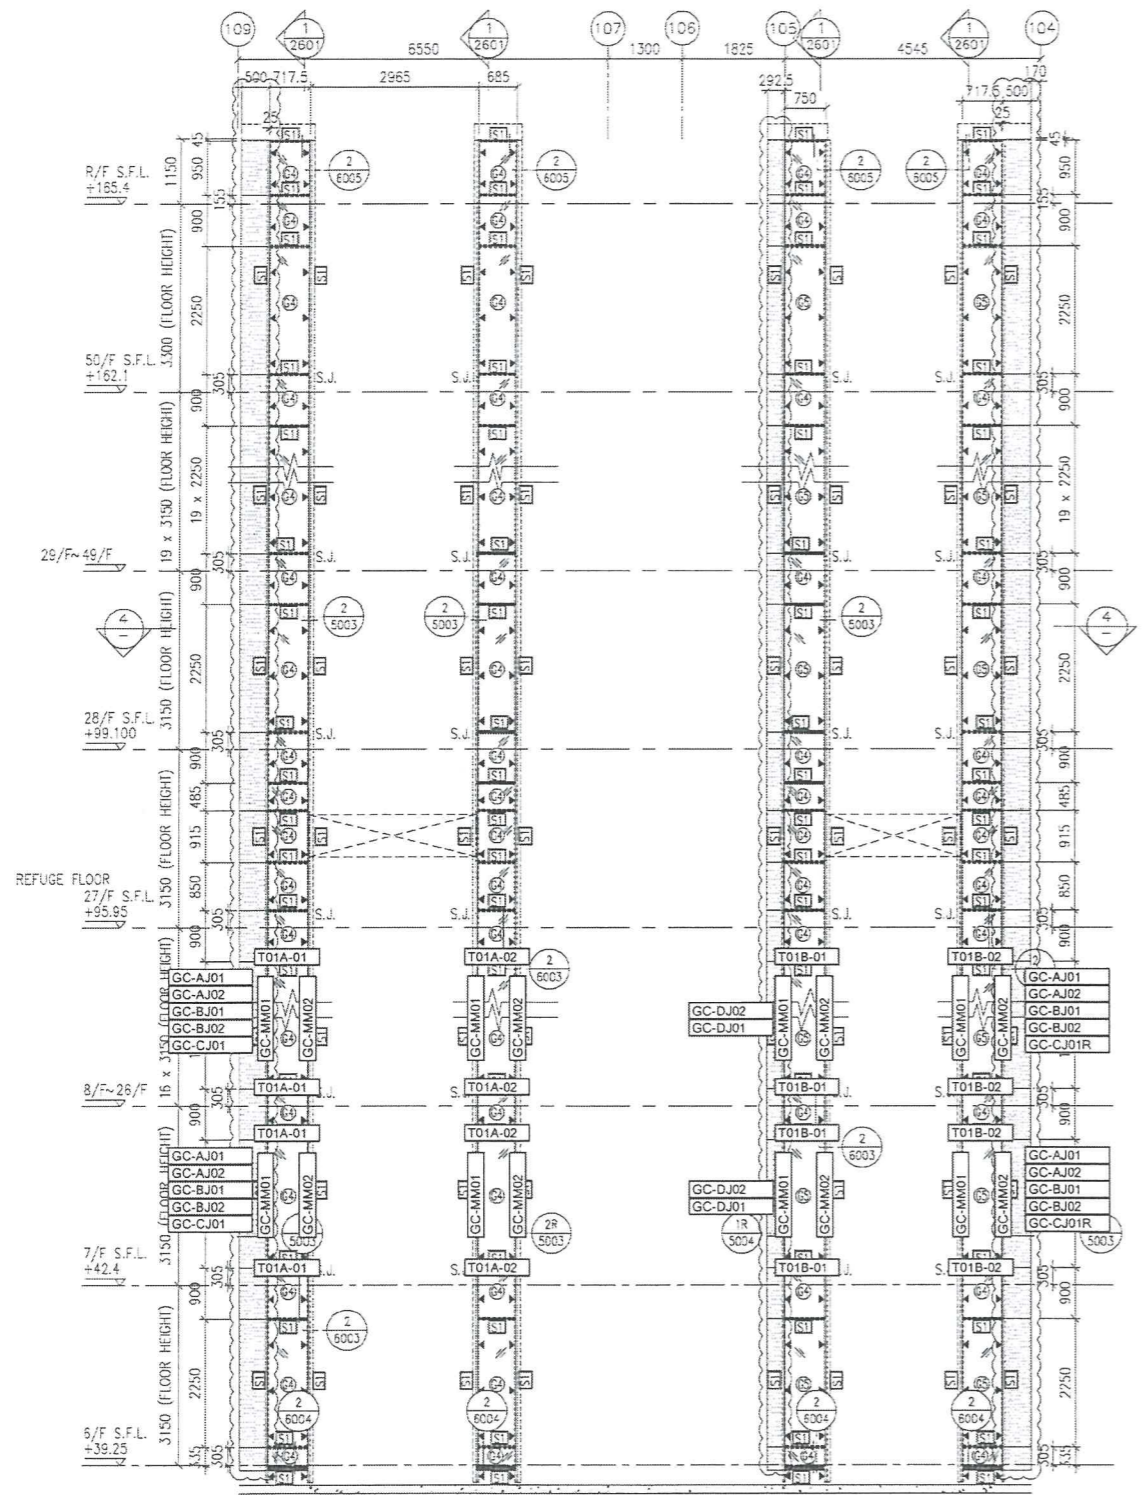
DATE : 04-JUL-18 SCALE : 1:60 (A1)
 DRAWN BY : ASING CHECKED BY : -

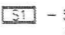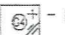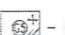 美特鋁質有限公司
 MIDI ALUMINIUM FABRICATOR LTD.
 Units 6-8, Sunray Industrial Centre, 1/F
 610 Cha Kwo Ling Road, Kowloon
 Tel: 23489211-4 Fax: (852) 2727666


DWG NO. : J837-GC-2102 REV. : B




- LEGEND:
-  - 50x37x5mm THK. G.M.S. CHANNEL (CUT FROM 100x50x5mm THK. G.M.S. R.H.S.)
 -  - 8 mm THK. HEAT STRENGTHENED BLUE TINTED GLASS (SPANDREL GLASS)
 -  - 8 mm THK. TEMPERED BLUE TINTED GLASS
 -  - 100x65x8mm THK. G.V.S. ANGLE BRACKET (L=250mm) W/ 2NOS-HILTI HST3-R M8 ANCHOR BOLT (MAX. @900c/c)
 -  - 100x65x2mm THK. G.M.S. ANGLE BRACKET (L=200mm) W/ 2NOS-HILTI HST3-R M8 ANCHOR BOLT (MAX. @900c/c)
 -  - 100x50x8mm THK. G.M.S. ANGLE BRACKET (L=250mm) W/ 2NOS-HILTI HST3-R M8 ANCHOR BOLT (@900c/c)
 -  - 100x50x8mm THK. G.M.S. ANGLE BRACKET (L=250mm) W/ 2NOS-Y12 STEEL BAR (BOND LENGTH=200mm)
 -  - 100x50x8mm THK. G.M.S. ANGLE BRACKET (L=200mm) W/ 1NO-Y12 STEEL BAR (BOND LENGTH=200mm)
 -  - STACK JOINT
 -  - 3 mm THK. ALUM. CLADDING

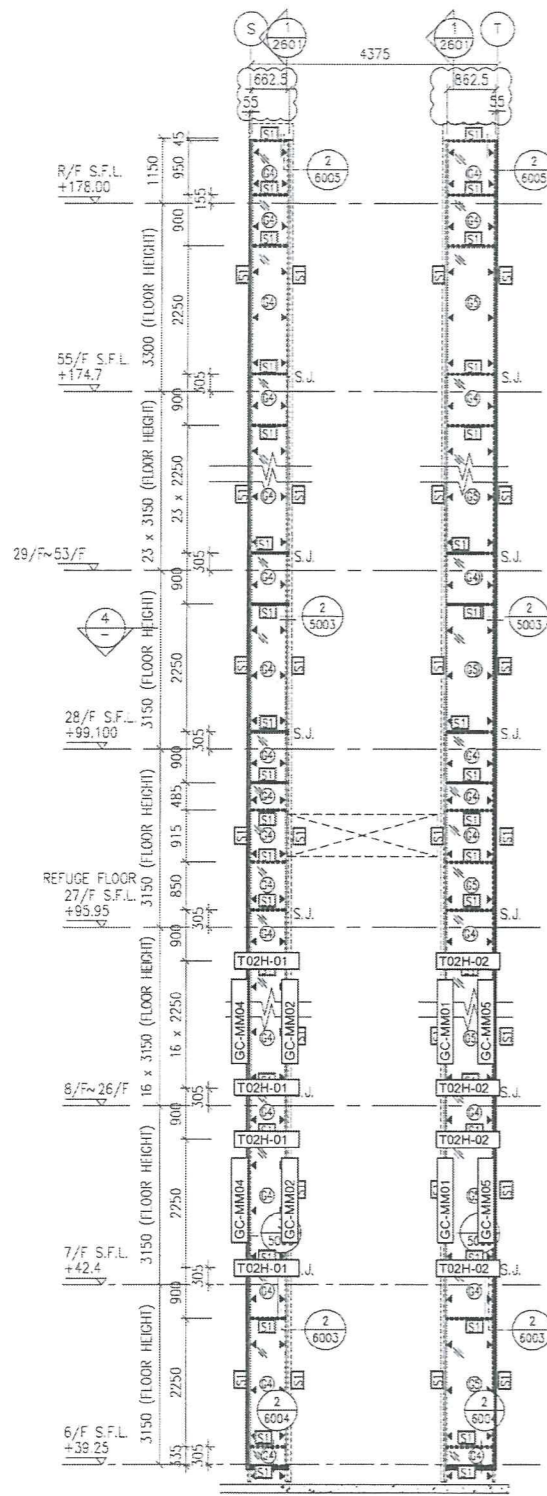


1 PART ELEVATION FOR GLASS CLADDING

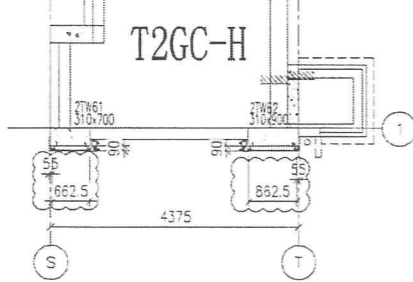

2 PART PLAN FOR GLASS CLADDING

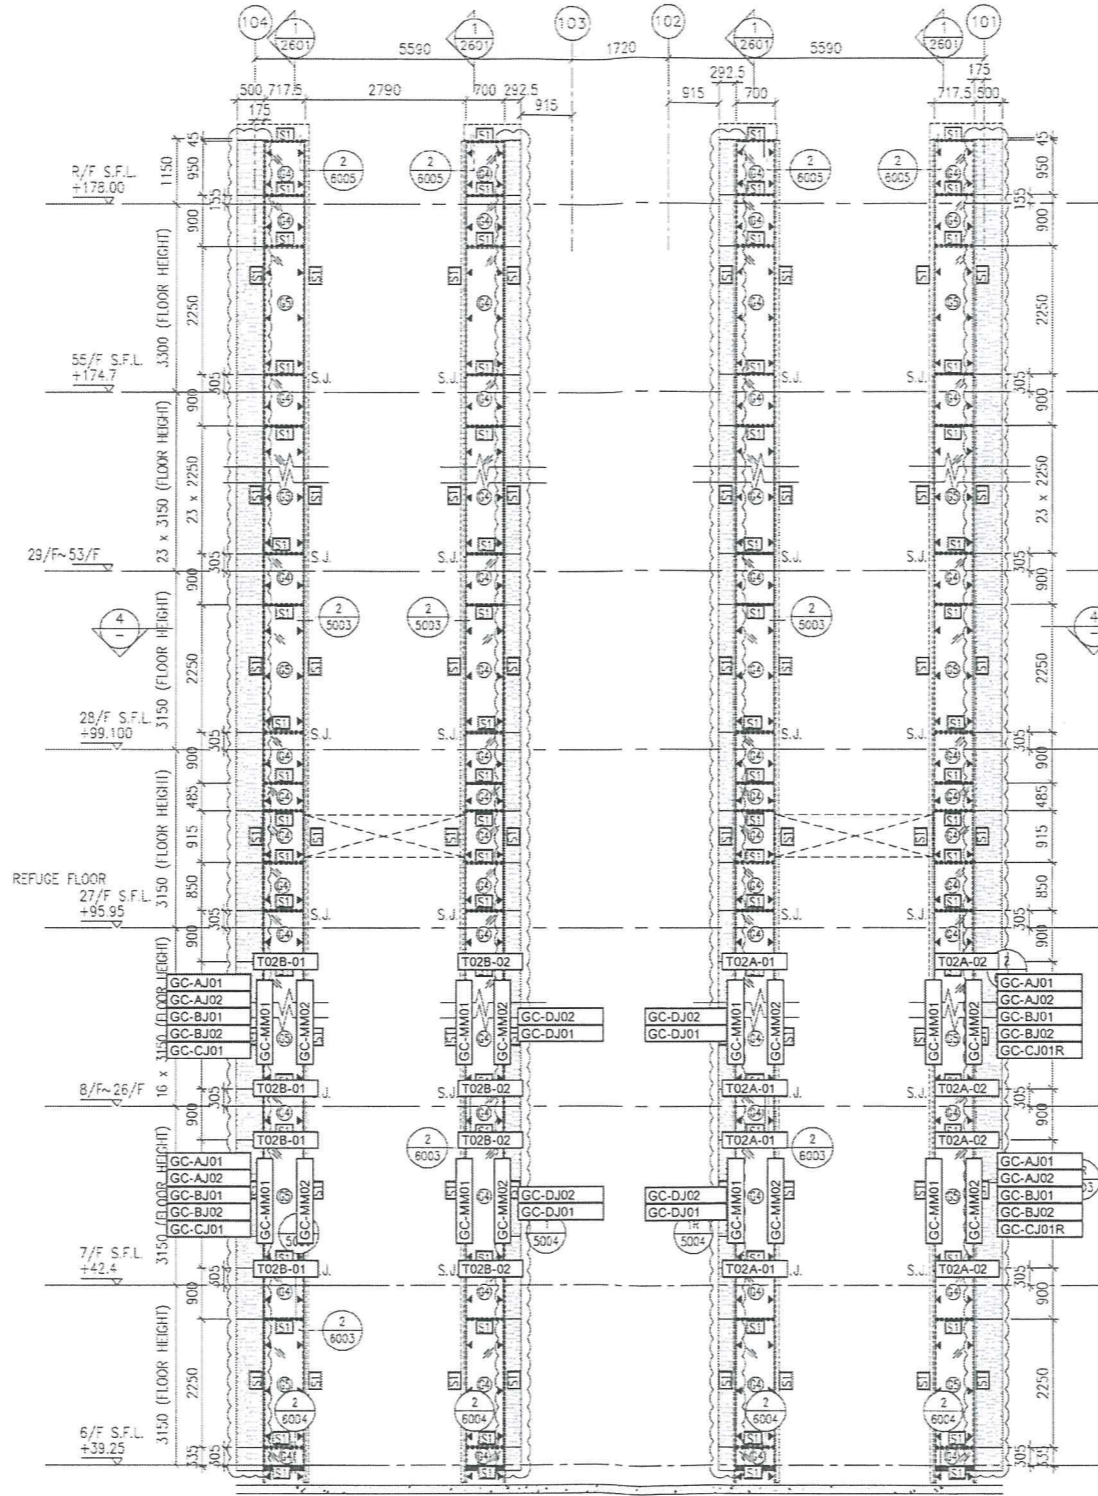

3 PART ELEVATION FOR GLASS CLADDING

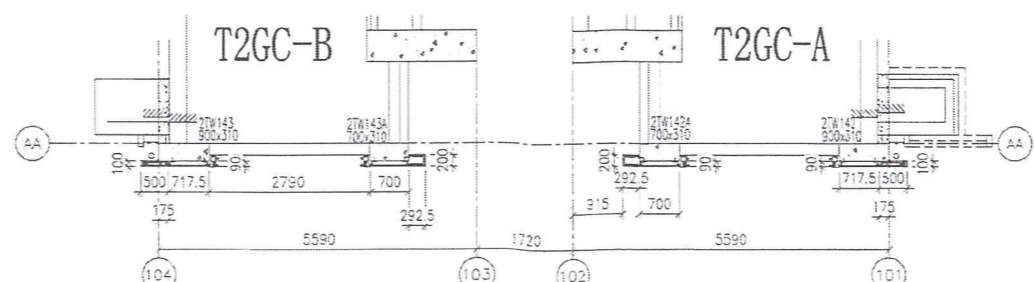

4 PART PLAN FOR GLASS CLADDING

- LEGEND:
- ST - 50x37x5mm THK. G.M.S. CHANNEL (CUT FROM 100x50x5mm THK. G.M.S. R.H.S.)
 - SG - 8 mm THK. HEAT STRENGTHENED BLUE TINTED GLASS (SPANDREL GLASS)
 - SG - 8 mm THK. TEMPERED BLUE TINTED GLASS
 - ▲ - 100x65x8mm THK. G.M.S. ANGLE BRACKET (L=250mm) W/ 2NOS-HILTI HST3-R MB ANCHOR BOLT (MAX. @900c/c)
 - ▲ - 100x65x8mm THK. G.M.S. ANGLE BRACKET (L=200mm) W/ 1NO-HILTI HST3-R MB ANCHOR BOLT (MAX. @900c/c)
 - ▲ - 100x50x6mm THK. G.M.S. ANGLE BRACKET (L=250mm) W/ 2NOS-HILTI HST3-R MB ANCHOR BOLT (MAX. @900c/c)
 - ▲ - 100x50x6mm THK. G.M.S. ANGLE BRACKET (L=200mm) W/ 1NO-HILTI HST3-R MB ANCHOR BOLT (MAX. @900c/c)
 - S.J. - STACK JOINT
 - AL - 3 mm THK. ALUM. CLADDING

B.D. REF :

CLIENT :
 Sino Land Company Limited

ARCHITECT :
 WONG TUNG & PARTNERS LIMITED
 ARCHITECTS & PLANNERS

MAIN CONTRACTOR :
 CR Construction Company Limited

STRUCTURAL ENGINEER :
 AECOM

FACADE CONSULTANT:
 AECOM

NOTE:
 1. ALL DIMENSIONS ARE IN mm.
 2. ALL ELEVATIONS ARE VIEWED FROM OUTSIDE.
 3. ALL DIMENSIONS TO BE VERIFIED ON SITE BEFORE FABRICATION.

LEGEND:
 (x1) - DETAIL MARK NO.
 (x001) - REFER SHEET NO.
 1. F.F.L. -- FINISHED FLOOR LEVEL
 2. S.F.L. -- STRUCTURAL FLOOR LEVEL
 3. (R) -- REVERSED DETAIL

NO.	DATE	REVISED	BY
B	17/11/2018	GENERAL	REVISED
A	15/10/2018	GENERAL	REVISED

JOB NO. : J-837
 PROJECT :
 LURA KWUN TONG TOWN CENTRE
 REDEVELOPMENT (AREA 2 & 3) AT
 NKIL 6514, KWUN TONG, KWLOON

TITLE :
 PART ELEVATION
 OF GLASS CLADDING
 AT TOWER 2


DATE : 04-JUL-18 SCALE : 1:60 (A1)

DRAWN BY : ASING CHECKED BY : -

MIDI ALUMINIUM FABRICATOR LTD.
 Units 6-8, Sunray Industrial Centre, 1/F
 610 Cha Kwo Ling Road, Kowloon
 Tel: 23469211-4 Fax: (852) 2727866


DWG NO. : J837-GC-2201 REV. : B

B.D. REF :

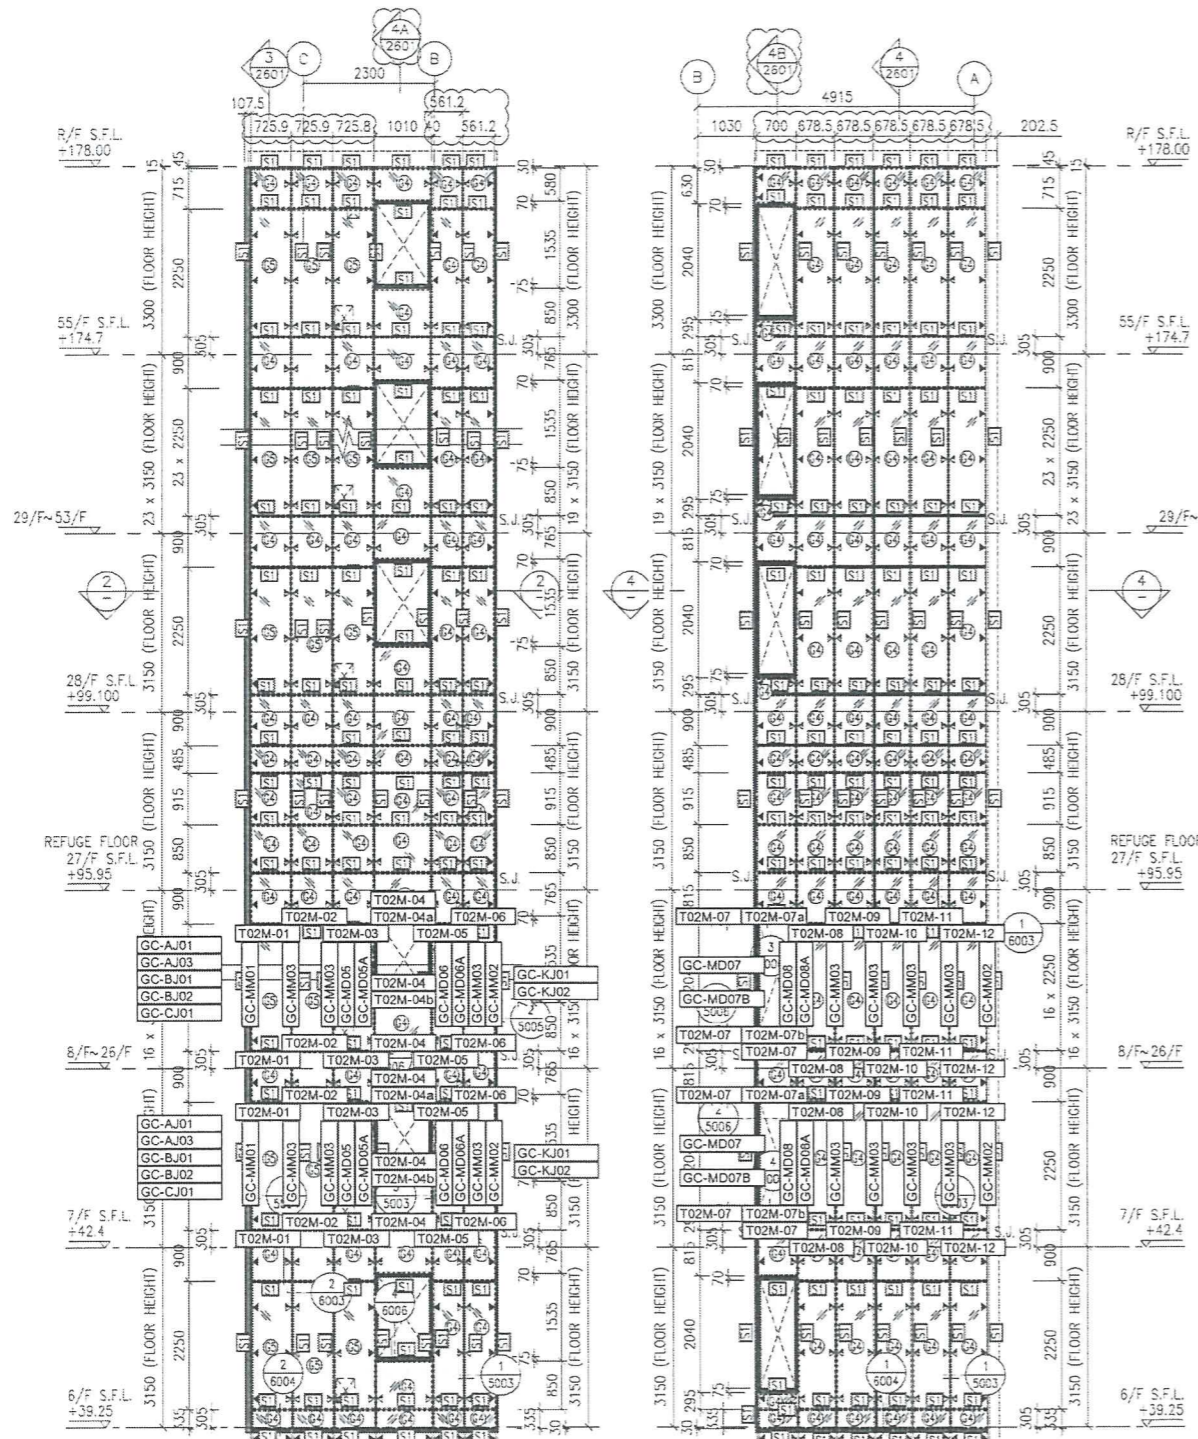

1 PART ELEVATION FOR GLASS CLADDING
 T2GC-M
 2 PART PLAN FOR GLASS CLADDING

3 PART ELEVATION FOR GLASS CLADDING
 T2GC-M
 4 PART PLAN FOR GLASS CLADDING

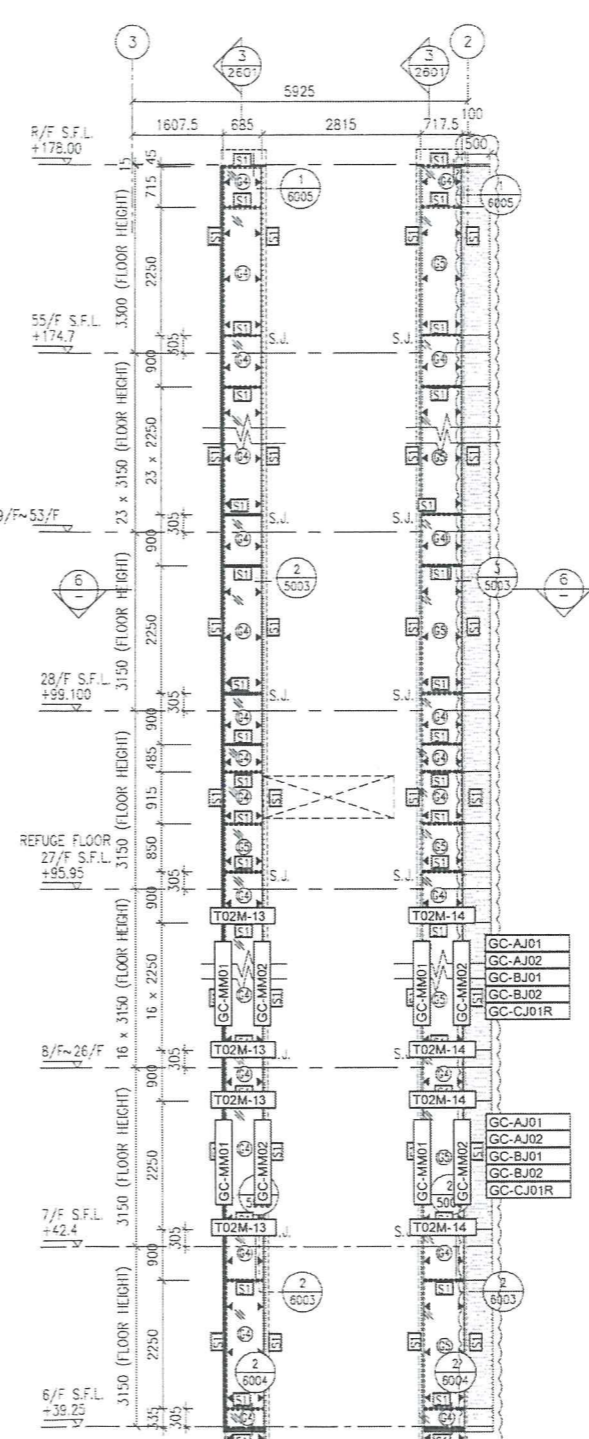

5 PART ELEVATION FOR GLASS CLADDING
 T2GC-M
 6 PART PLAN FOR GLASS CLADDING

- LEGEND:
- 51 - 50x37x5mm THK. G.M.S. CHANNEL (CUT FROM 100x50x5mm THK. G.M.S. R.H.S.)
 - 52 - 8 mm THK. HEAT STRENGTHENED BLUE TINTED GLASS (SPANDREL GLASS)
 - 53 - 8 mm THK. TEMPERED BLUE TINTED GLASS
 - 54 - 100x65x8mm THK. G.M.S. ANGLE BRACKET (L=250mm) W/ 2NOS-HILT HST3-R MB ANCHOR BOLT (MAX. @900c/c)
 - 55 - 100x65x8mm THK. G.M.S. ANGLE BRACKET (L=200mm) W/ 2NOS-HILT HST3-R MB ANCHOR BOLT (MAX. @900c/c)
 - 56 - 100x50x6mm THK. G.M.S. ANGLE BRACKET (L=250mm) W/ 2NOS-HILT HST3-R MB ANCHOR BOLT (MAX. @900c/c)
 - 57 - 100x50x6mm THK. G.M.S. ANGLE BRACKET (L=200mm) W/ 2NOS-HILT HST3-R MB ANCHOR BOLT (MAX. @900c/c)
 - 58 - 100x50x6mm THK. G.M.S. ANGLE BRACKET (L=250mm) W/ 2NOS-Y12 STEEL BAR (BOND LENGTH=200mm)
 - 59 - 100x50x6mm THK. G.M.S. ANGLE BRACKET (L=200mm) W/ 1NO-Y12 STEEL BAR (BOND LENGTH=200mm)
 - S.J. - STACK JOINT
 - 60 - 3 mm THK. ALUM. CLADDING

CLIENT :
 Sino Land Company Limited

ARCHITECT :
 WONG TUNG & PARTNERS LIMITED
 ARCHITECTS & PLANNERS

MAIN CONTRACTOR :
 CR Construction Company Limited

STRUCTURAL ENGINEER :
 AECOM

FAÇADE CONSULTANT:
 AECOM

NOTE :

- ALL DIMENSIONS ARE IN mm.
- ALL ELEVATIONS ARE VIEWED FROM OUTSIDE.
- ALL DIMENSIONS TO BE VERIFIED ON SITE BEFORE FABRICATION.

LEGEND :

Y1 - DETAIL MARK NO.
 X001 - REFER SHEET NO.

1. F.F.L. --- FINISHED FLOOR LEVEL
 2. S.F.L. --- STRUCTURAL FLOOR LEVEL
 3. (P) --- REVERSED DETAIL

B	17/11/2018	GENERAL REVISED	
A	15/10/2018	GENERAL REVISED	
NO.	DATE	REVISED	BY

JOB NO. : J-837
 PROJECT :
 URA KWUN TONG TOWN CENTRE
 REDEVELOPMENT (AREA 2 & 3) AT
 NKIL 6514, KWUN TONG, KWLOON

TITLE :
 PART ELEVATION
 OF GLASS CLADDING
 AT TOWER 2

DATE : 04-JUL-18 SCALE : 1:60 (A1)

DRAWN BY : ASING CHECKED BY : -

MIDI ALUMINIUM FABRICATOR LTD.
 Units 6-8, Sunray Industrial Centre, 1/F
 610 Che Kwo Ling Road, Kowloon
 Tel: 23489211-4 Fax: (852) 27278666

DWG NO. : J837-GC-2202 REV. : B

B.D. REF :

CLIENT :
 信和置業有限公司
 Sino Land Company Limited

ARCHITECT :
 WONG TUNG & PARTNERS LIMITED
 ARCHITECTS & PLANNERS

MAIN CONTRACTOR :
 CR Construction Company Limited

STRUCTURAL ENGINEER :
 AECOM

FACADE CONSULTANT :
 AECOM

NOTE :
 1. ALL DIMENSIONS ARE IN mm.
 2. ALL ELEVATIONS ARE VIEWED FROM OUTSIDE.
 3. ALL DIMENSIONS TO BE VERIFIED ON SITE BEFORE FABRICATION.

LEGEND :

 1. F.F.L. -- FINISHED FLOOR LEVEL
 2. S.F.L. -- STRUCTURAL FLOOR LEVEL
 3. (R) -- REVERSED DETAIL

B	17/11/2018	GENERAL REVISED	
A	15/10/2016	GENERAL REVISED	
NO.	DATE	REVISED	BY





JOB NO. : J-837
 PROJECT : URA KWUN TONG TOWN CENTRE REDEVELOPMENT (AREA 2 & 3) AT NKIL 6514, KWUN TONG, KWLOON

TITLE : PART ELEVATION OF GLASS CLADDING AT TOWER 3

DATE : 04-JUL-18 SCALE : 1:60 (A1)

DRAWN BY : ASING CHECKED BY :
 MIDI ALUMINIUM FABRICATOR LTD.
 Units 6-B, Sunray Industrial Centre, 1/F
 610 Cho Kwo Ling Road, Kwloon
 Tel: 23489211-4 Fax: (852) 2727666

DWG NO. : J837-GC-2301 REV. : B

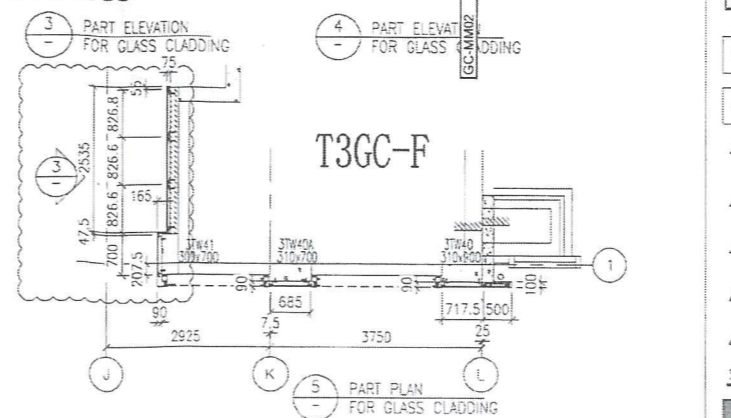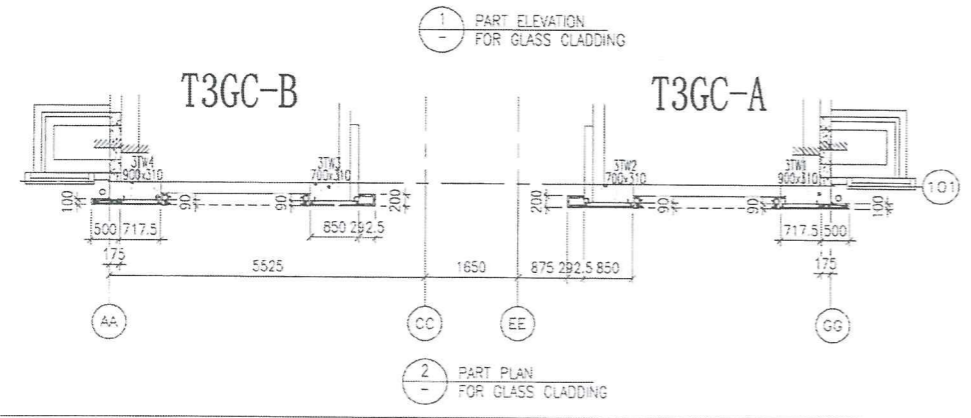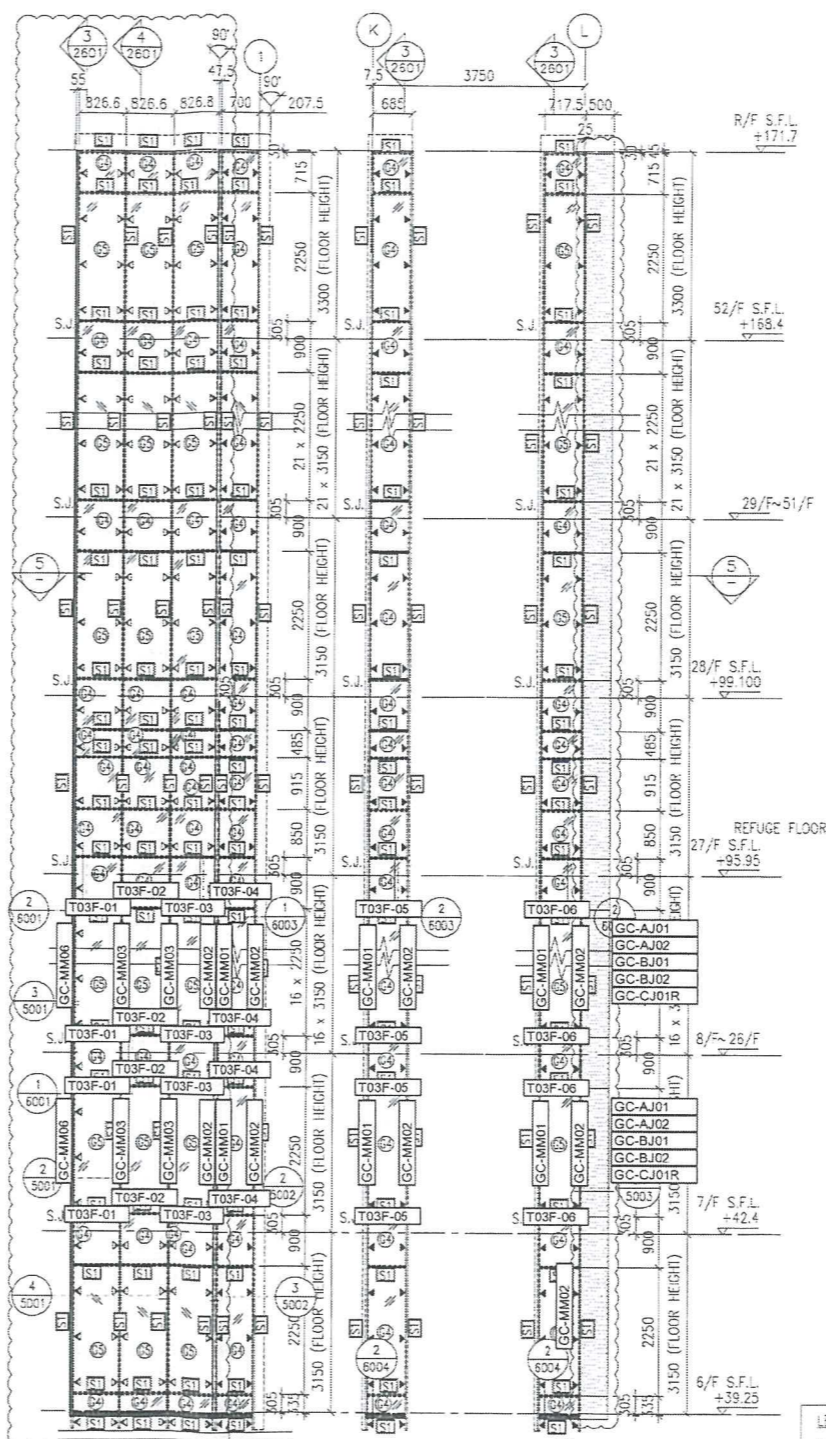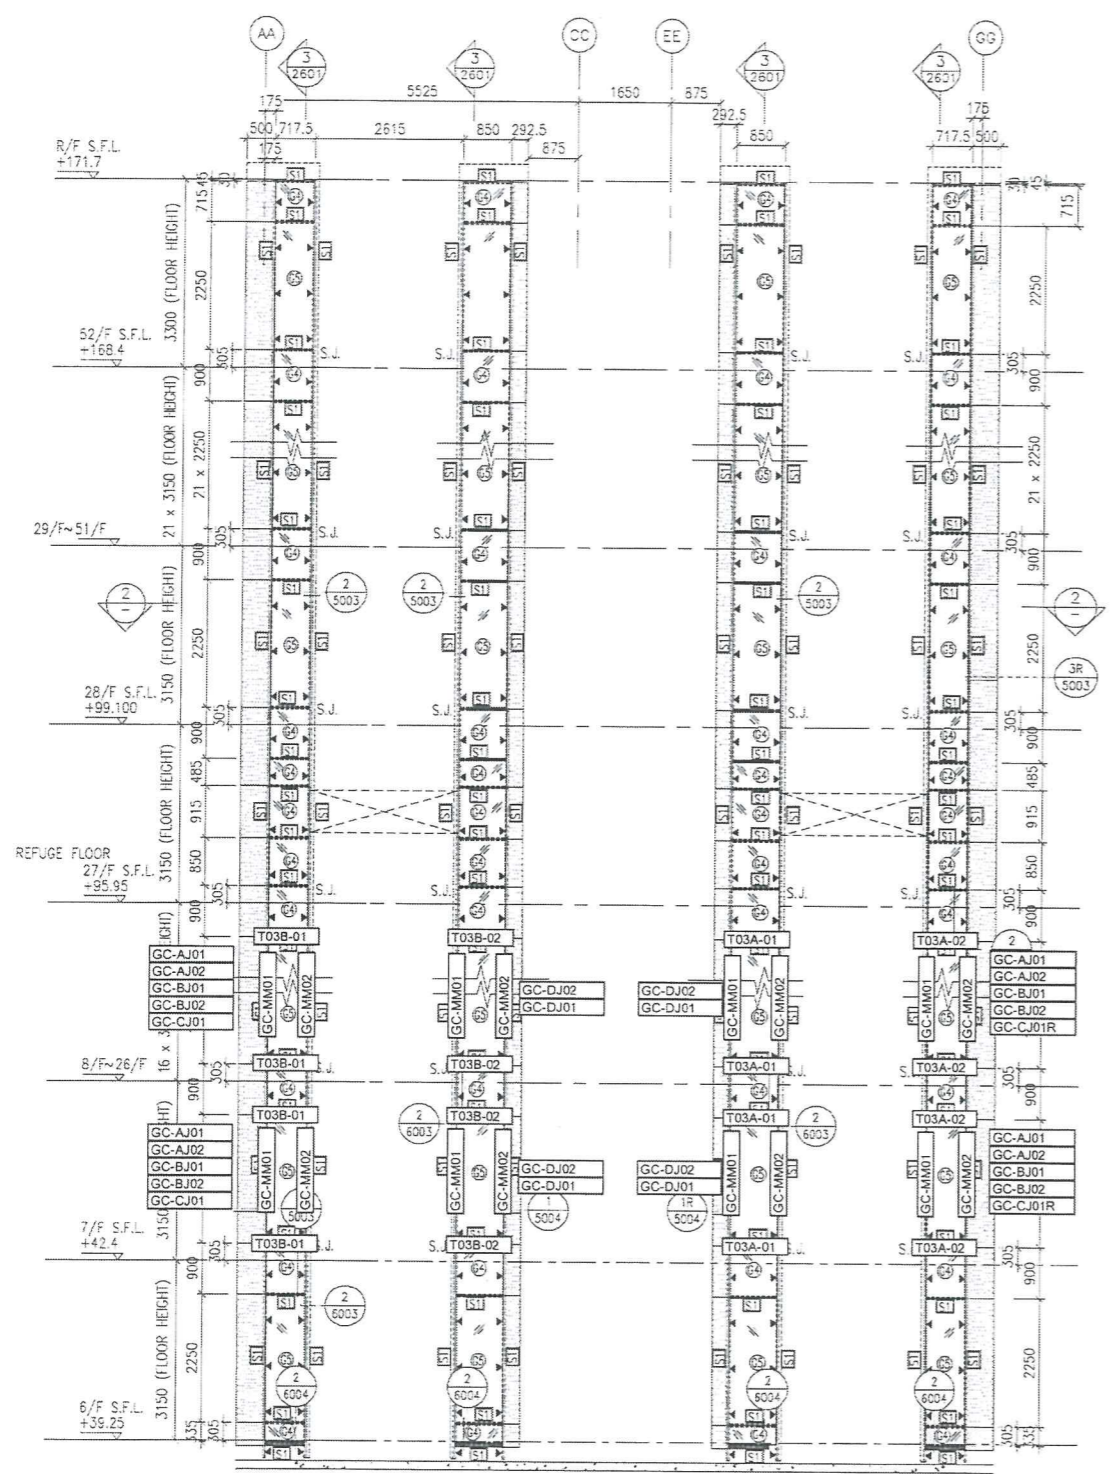


- LEGEND:
- 50x37x5mm THK. G.M.S. CHANNEL (CUT FROM 100x50x5mm THK. G.M.S. R.H.S.)
 - 8 mm THK. HEAT STRENGTHENED BLUE TINTED GLASS (SPANDREL GLASS)
 - 8 mm THK. TEMPERED BLUE TINTED GLASS
 - 100x65x6mm THK. G.M.S. ANGLE BRACKET (L=250mm) W/ 2N05-HILT HST3-R MB ANCHOR BOLT (MAX. @900c/c)
 - 100x65x6mm THK. G.M.S. ANGLE BRACKET (L=200mm) W/ 1N0-HILT HST3-R MB ANCHOR BOLT (MAX. @900c/c)
 - 100x50x6mm THK. G.M.S. ANGLE BRACKET (L=250mm) W/ 2N05-HILT HST3-R MB ANCHOR BOLT (@900c/c)
 - 100x50x6mm THK. G.M.S. ANGLE BRACKET (L=200mm) W/ 1N0-HILT HST3-R MB ANCHOR BOLT (@900c/c)
 - 100x50x6mm THK. G.M.S. ANGLE BRACKET (L=200mm) W/ 1N0-Y12 STEEL BAR (BOND LENGTH=200mm)
 - STACK JOINT
 - 3 mm THK. ALUM. CLADDING

B.D. REF :

CLIENT :
 信和置業有限公司
 Sino Land Company Limited



ARCHITECT :
 WONG TUNG & PARTNERS LIMITED
 ARCHITECTS & PLANNERS


MAIN CONTRACTOR :
 CR Construction Company Limited

STRUCTURAL ENGINEER :
 AECOM

FACADE CONSULTANT:
 AECOM

NOTE:
 1. ALL DIMENSIONS ARE IN mm.
 2. ALL ELEVATIONS ARE VIEWED FROM OUTSIDE.
 3. ALL DIMENSIONS TO BE VERIFIED ON SITE BEFORE FABRICATION.

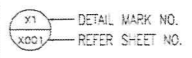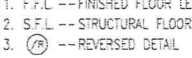LEGEND:
 DETAIL MARK NO.
 REFER SHEET NO.
 1. F.F.L -- FINISHED FLOOR LEVEL
 2. S.F.L -- STRUCTURAL FLOOR LEVEL
 3. (R) -- REVERSED DETAIL

NO.	DATE	REVISED	BY
B	17/11/2018	GENERAL REVISED	
A	15/10/2018	GENERAL REVISED	

JOB NO. : J-837
 PROJECT :
 URA KWUN TONG TOWN CENTRE
 REDEVELOPMENT (AREA 2 & 3) AT
 NKIL 6514, KWUN TONG, KWLOON





TITLE :
 PART ELEVATION
 OF GLASS CLADDING
 AT TOWER 5




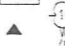
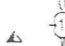




DATE : 04-JUL-18 SCALE : 1:60 (A1)


DRAWN BY : ASING CHECKED BY : -

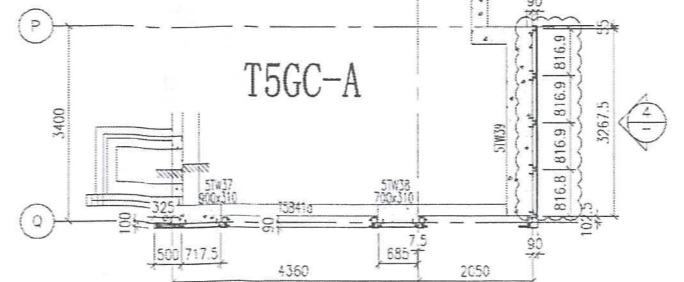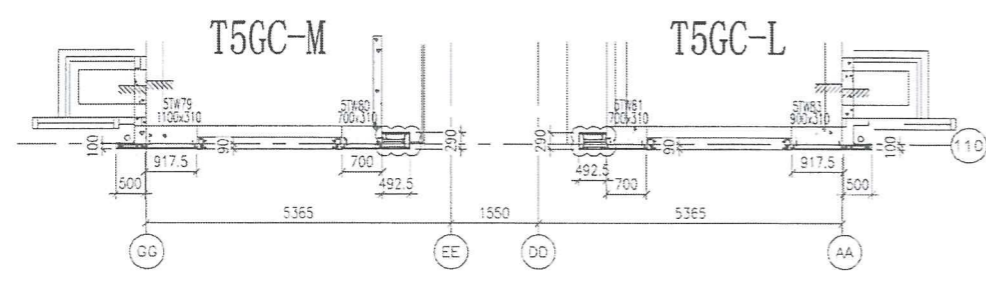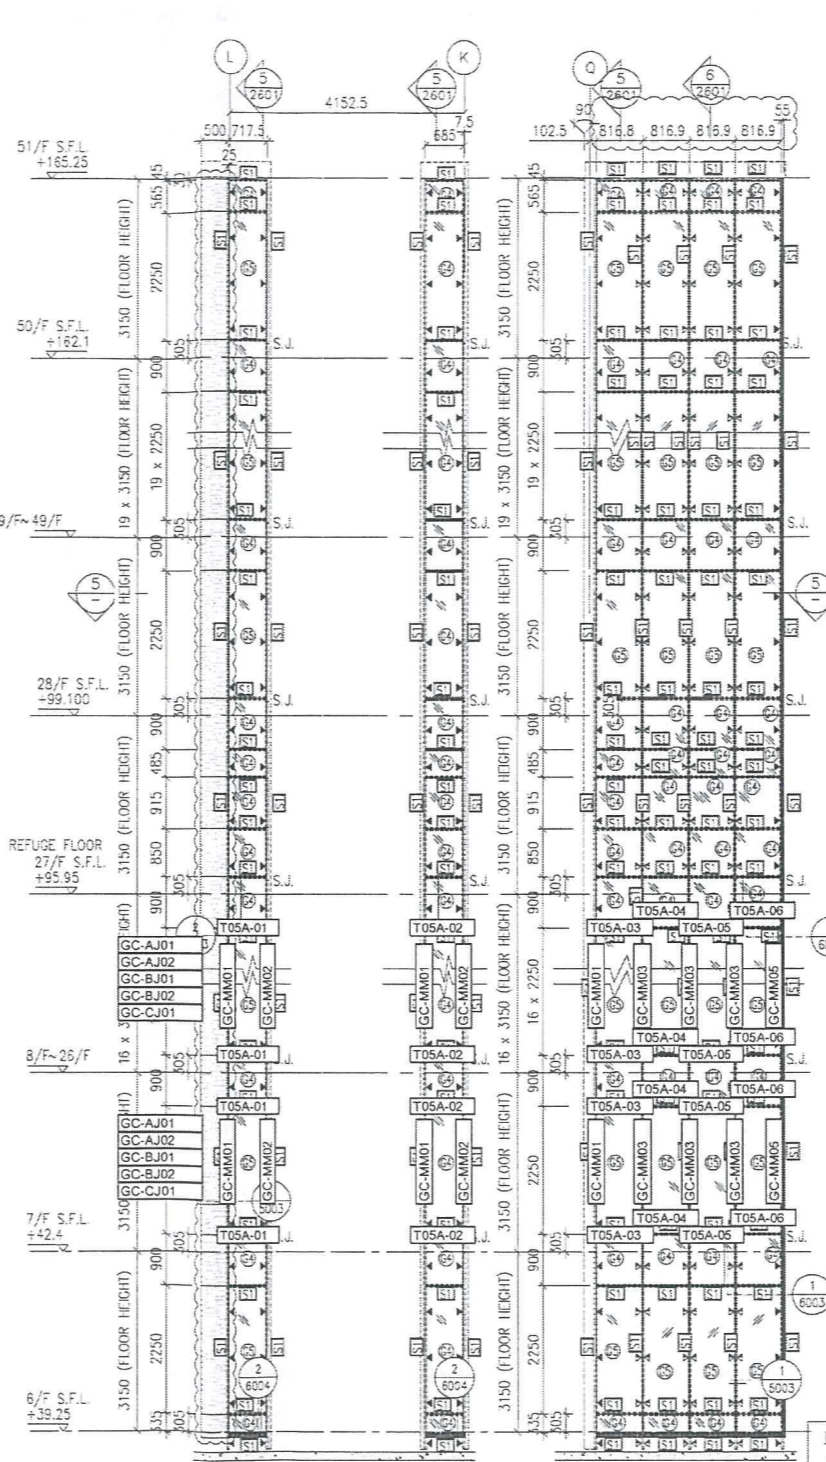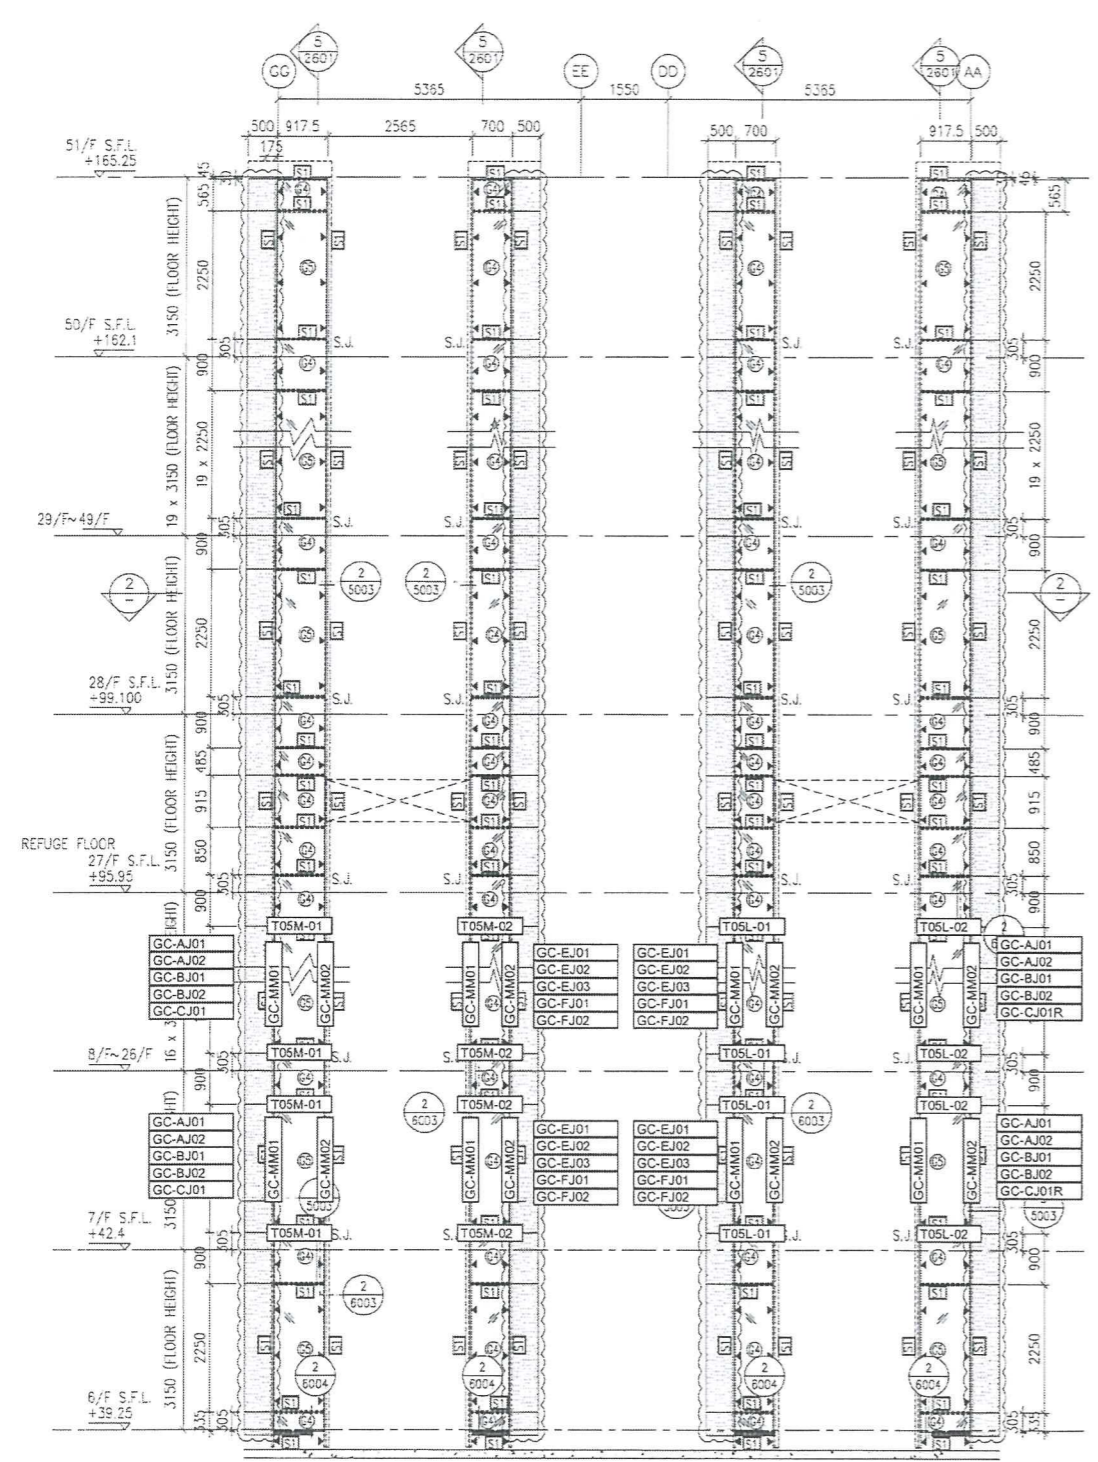 美特鋁質有限公司
 MIDI ALUMINIUM FABRICATOR LTD.
 Units 6-8, Sunray Industrial Centre, 1/F
 610 Cha Kwo Ling Road, Kowloon
 Tel: 23489211-4 Fax: (852) 2727666

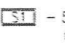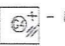DWG NO. : JB37-GC-2501 REV. : B



- LEGEND:
-  - 50x37x5mm THK G.M.S. CHANNEL (CUT FROM 100x50x5mm THK. G.M.S. R.H.S.)
 -  - 8 mm THK. HEAT STRENGTHENED BLUE TINTED GLASS (SPANDREL GLASS)
 -  - 8 mm THK. TEMPERED BLUE TINTED GLASS
 -  - 100x50x8mm THK. G.M.S. ANGLE BRACKET (L=250mm) W/ 2NOS-HILT1 HST3-R M8 ANCHOR BOLT (MAX. @900c/c)
 -  - 100x50x8mm THK. G.M.S. ANGLE BRACKET (L=200mm) W/ 2NOS-HILT1 HST3-R M8 ANCHOR BOLT (MAX. @900c/c)
 -  - 100x50x8mm THK. G.V.S. ANGLE BRACKET (L=250mm) W/ 2NOS-Y12 STEEL BAR (BOND LENGTH=200mm)
 -  - 100x50x8mm THK. G.V.S. ANGLE BRACKET (L=200mm) W/ 2NOS-Y12 STEEL BAR (BOND LENGTH=200mm)
 -  - STACK JOINT
 -  - 3 mm THK. ALUM. CLADDING

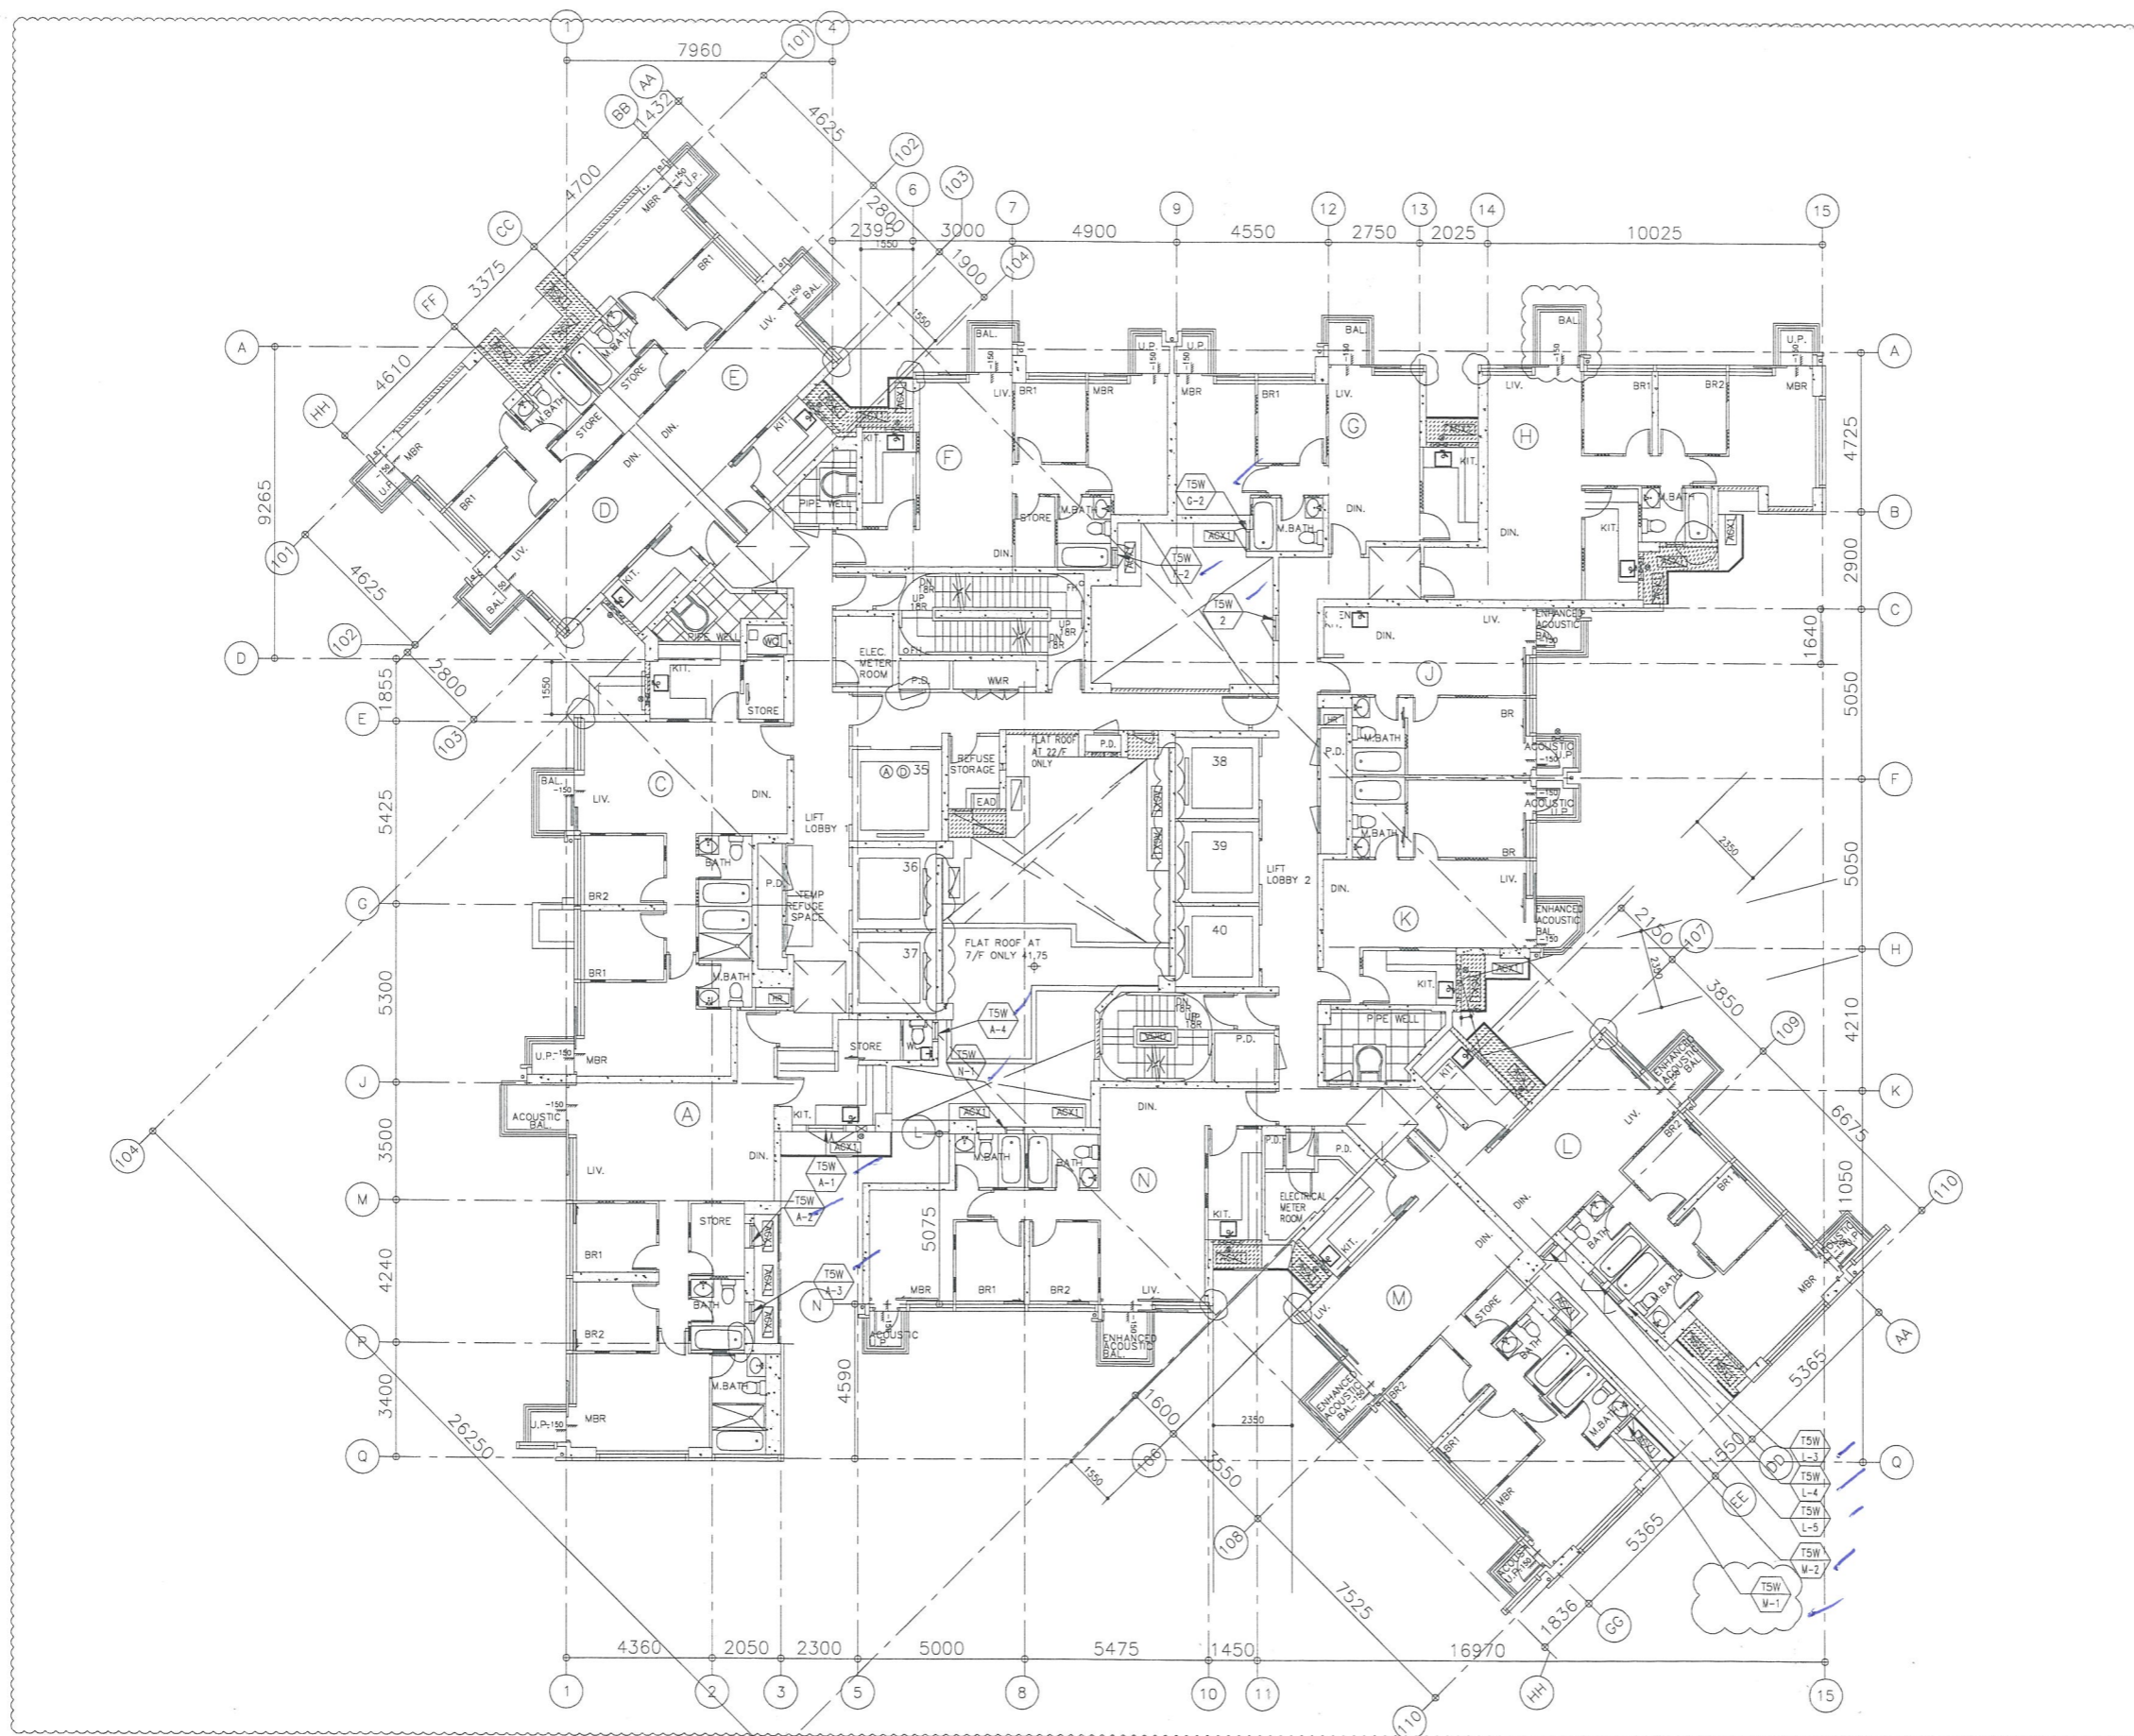

B.D. REF :

CLIENT :
 Sino Land Company Limited

ARCHITECT :
 WONG TUNG & PARTNERS LIMITED
 ARCHITECTS & PLANNERS

MAIN CONTRACTOR :
 CR Construction Company Limited

STRUCTURAL ENGINEER :
 AEM

FAÇADE CONSULTANT:

NOTE :
 1. ALL DIMENSIONS ARE IN mm.
 2. ALL ELEVATIONS ARE VIEWED FROM OUTSIDE.
 3. ALL DIMENSIONS TO BE VERIFIED ON SITE BEFORE FABRICATION.

LEGEND :
 X1 -- DETAIL MARK NO.
 X001 -- REFER SHEET NO.
 1. F.F.L -- FINISHED FLOOR LEVEL
 2. S.F.L -- STRUCTURAL FLOOR LEVEL
 3. (R) -- REVERSED DETAIL

C	2019-1-29	BY ARCHITECT COMMENT	Zeng
B	18-12-13	BY ARCHITECT COMMENT	Zeng
A	2018/09-1	BY ARCHITECT COMMENT	Zeng

JOB NO. : J-837
 PROJECT :
 URA KWUN TONG TOWN CENTRE
 REDEVELOPMENT (AREA 2 & 3) AT
 NKIL 6514, KWUN TONG, KOWLOON


TITLE :
 FULL PLAN LAYOUT
 (FOR T5 50/F FLOOR PLAN)(HIGH ZONE)

DATE : 09-JUL-18 SCALE : 1:200
 DRAWN BY : Zeng CHECKED BY : DW

美特鋁質有限公司
 MIDI ALUMINIUM FABRICATOR LTD.
 Units 6-8, Sunray Industrial Centre, 1/F
 610 Cho Kwo Ling Road, Kowloon
 Tel: 23489211-4 Fax: (852) 27727666

DWG NO. : J837-IW-3503 REV. : C

T5 -- TYPICAL FLOOR PLAN (HIGH ZONE)
 22/F - 26/F 28/F - 50/F (25 STOREYS)
 (FLOOR NOS. 24, 34, 44 NOT USED.)

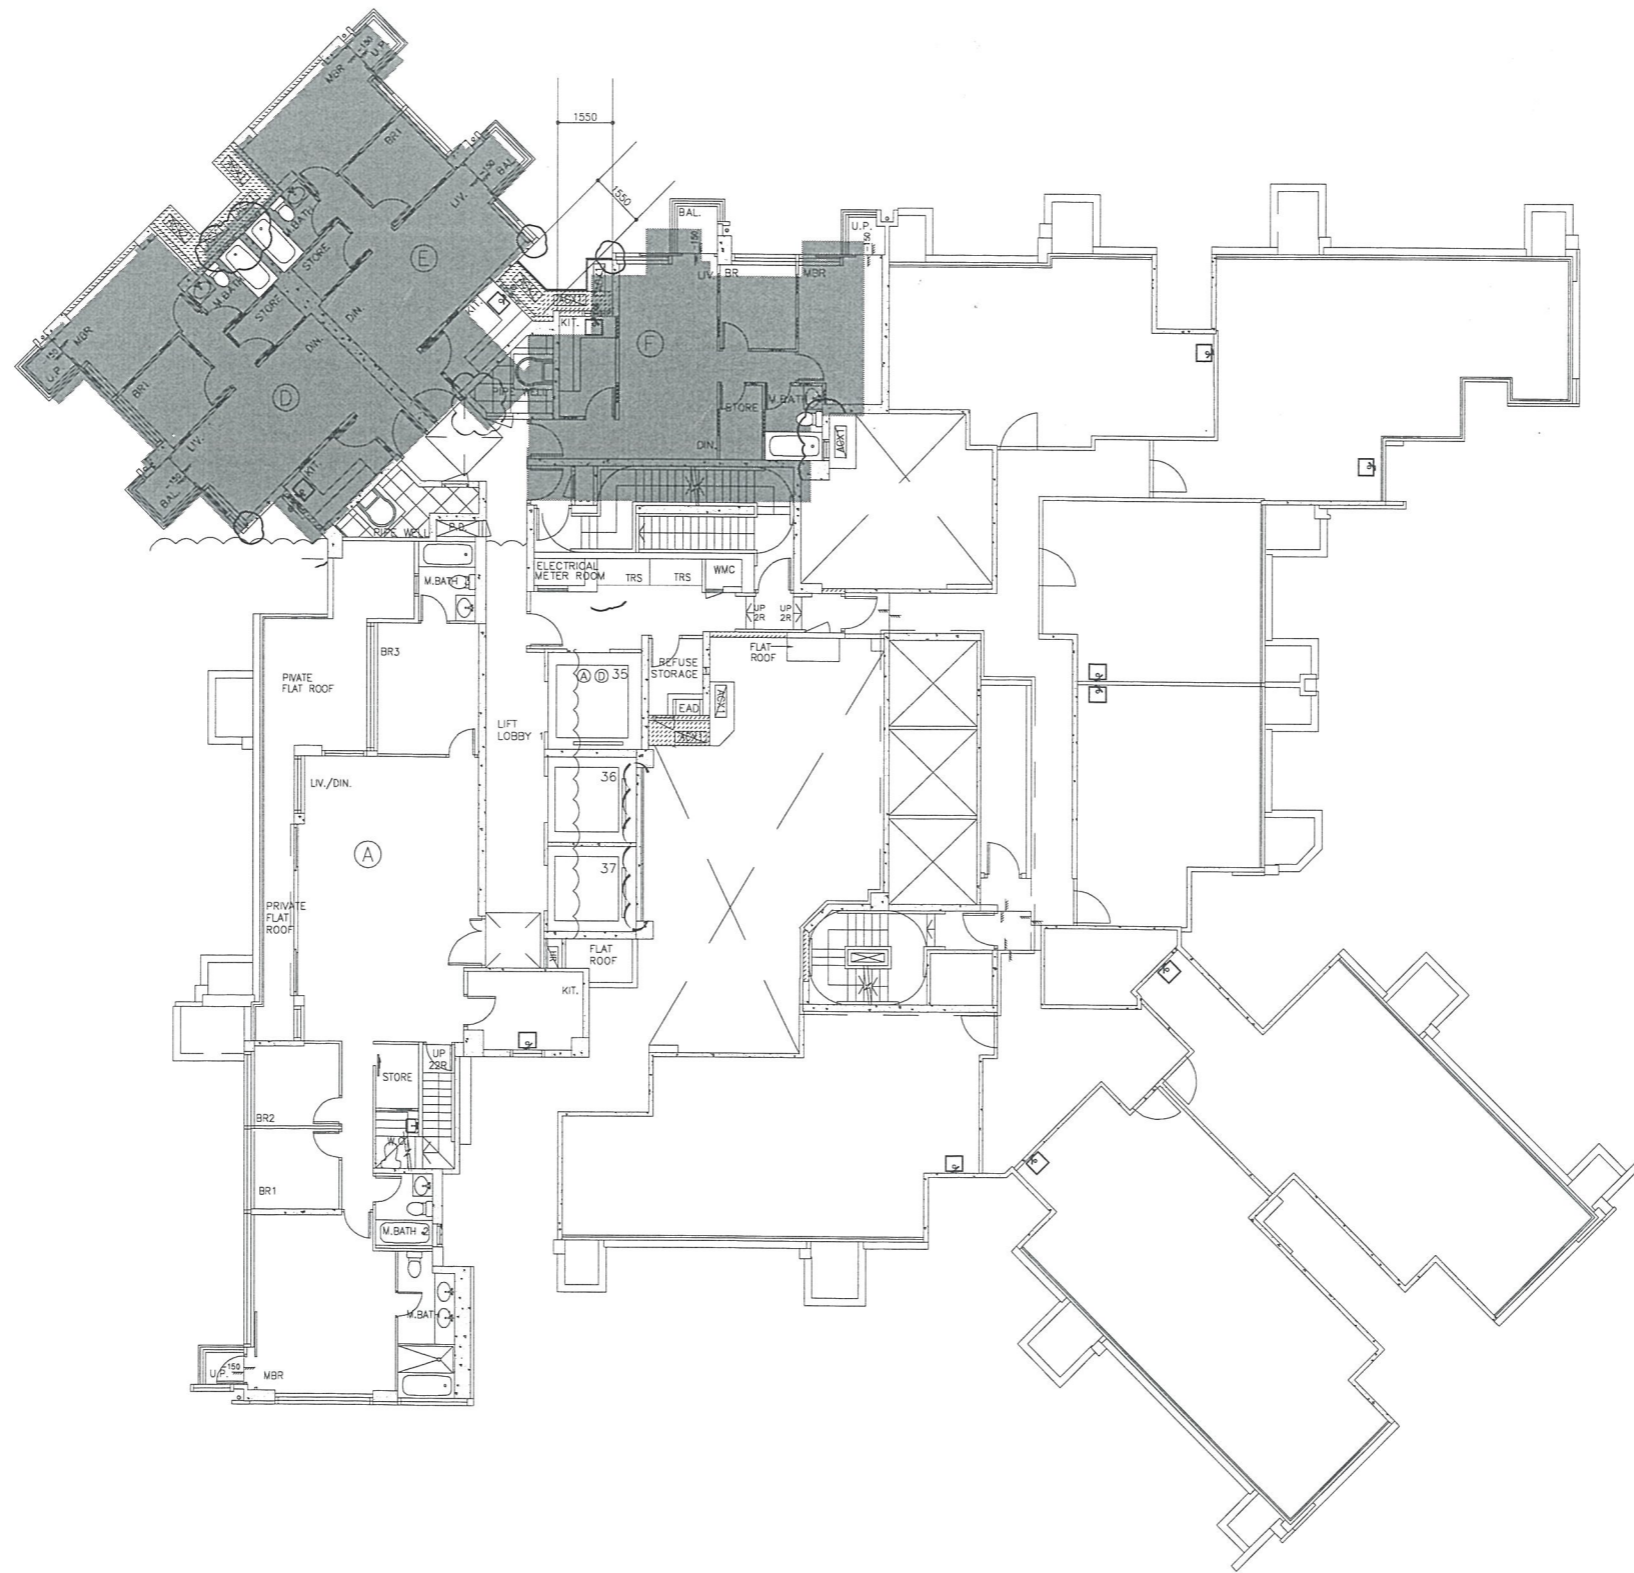

T5 - 51/F PLAN

LEGEND :

- AA1 OK
- AA1
- A1 OK
- A1
- A2
- B1
- B2
- B3
- B4
- B5
- C

B.D. REF :

CLIENT :
 信和置業有限公司
 Sino Land Company Limited

ARCHITECT :
 WONG TUNG & PARTNERS LIMITED
 ARCHITECTS & PLANNERS

MAIN CONTRACTOR :
 CR Construction Company Limited

STRUCTURAL ENGINEER :
 AEM

FACADE CONSULTANT:

NOTE :
 1. ALL DIMENSIONS ARE IN mm.
 2. ALL ELEVATIONS ARE VIEWED FROM OUTSIDE.
 3. ALL DIMENSIONS TO BE VERIFIED ON SITE BEFORE FABRICATION.

LEGEND :
 X1 --- DETAIL MARK NO.
 X001 --- REFER SHEET NO.
 1. F.F.L. --- FINISHED FLOOR LEVEL
 2. S.F.L. --- STRUCTURAL FLOOR LEVEL
 3. (R) --- REVERSED DETAIL

NO.	DATE	REVISED	BY

JOB NO. : J-837
 PROJECT :
 URA KWUN TONG TOWN CENTRE
 REDEVELOPMENT (AREA 2 & 3) AT
 NKIL 6514, KWUN TONG, KOWLOON

TITLE :
 FULL PLAN LAYOUT
 (FOR T5 51/F FLOOR PLAN)

DATE : 09-JUL-18 SCALE : 1:200

DRAWN BY : Zeng CHECKED BY : DW

美特鋁質有限公司
 MIDI ALUMINIUM FABRICATOR LTD.
 Units 6-8, Sunray Industrial Centre, 1/F
 610 Cho Kwo Ling Road, Kowloon
 Tel: 23489211-4 Fax: (852) 2727666

DWG NO. : J837-IW-3504 REV. : -